


west virginia department of environmental protection

EARL RAY TOMBLIN, GOVERNOR
RANDY C. HUFFMAN, CABINET SECRETARY
OFFICE OF ABANDONED MINE LANDS
AMIGO PORTALS
RALEIGH COUNTY, WEST VIRGINIA

U.S.G.S. LOCATION MAP
SCALE: 1 INCH = 2000 FEET

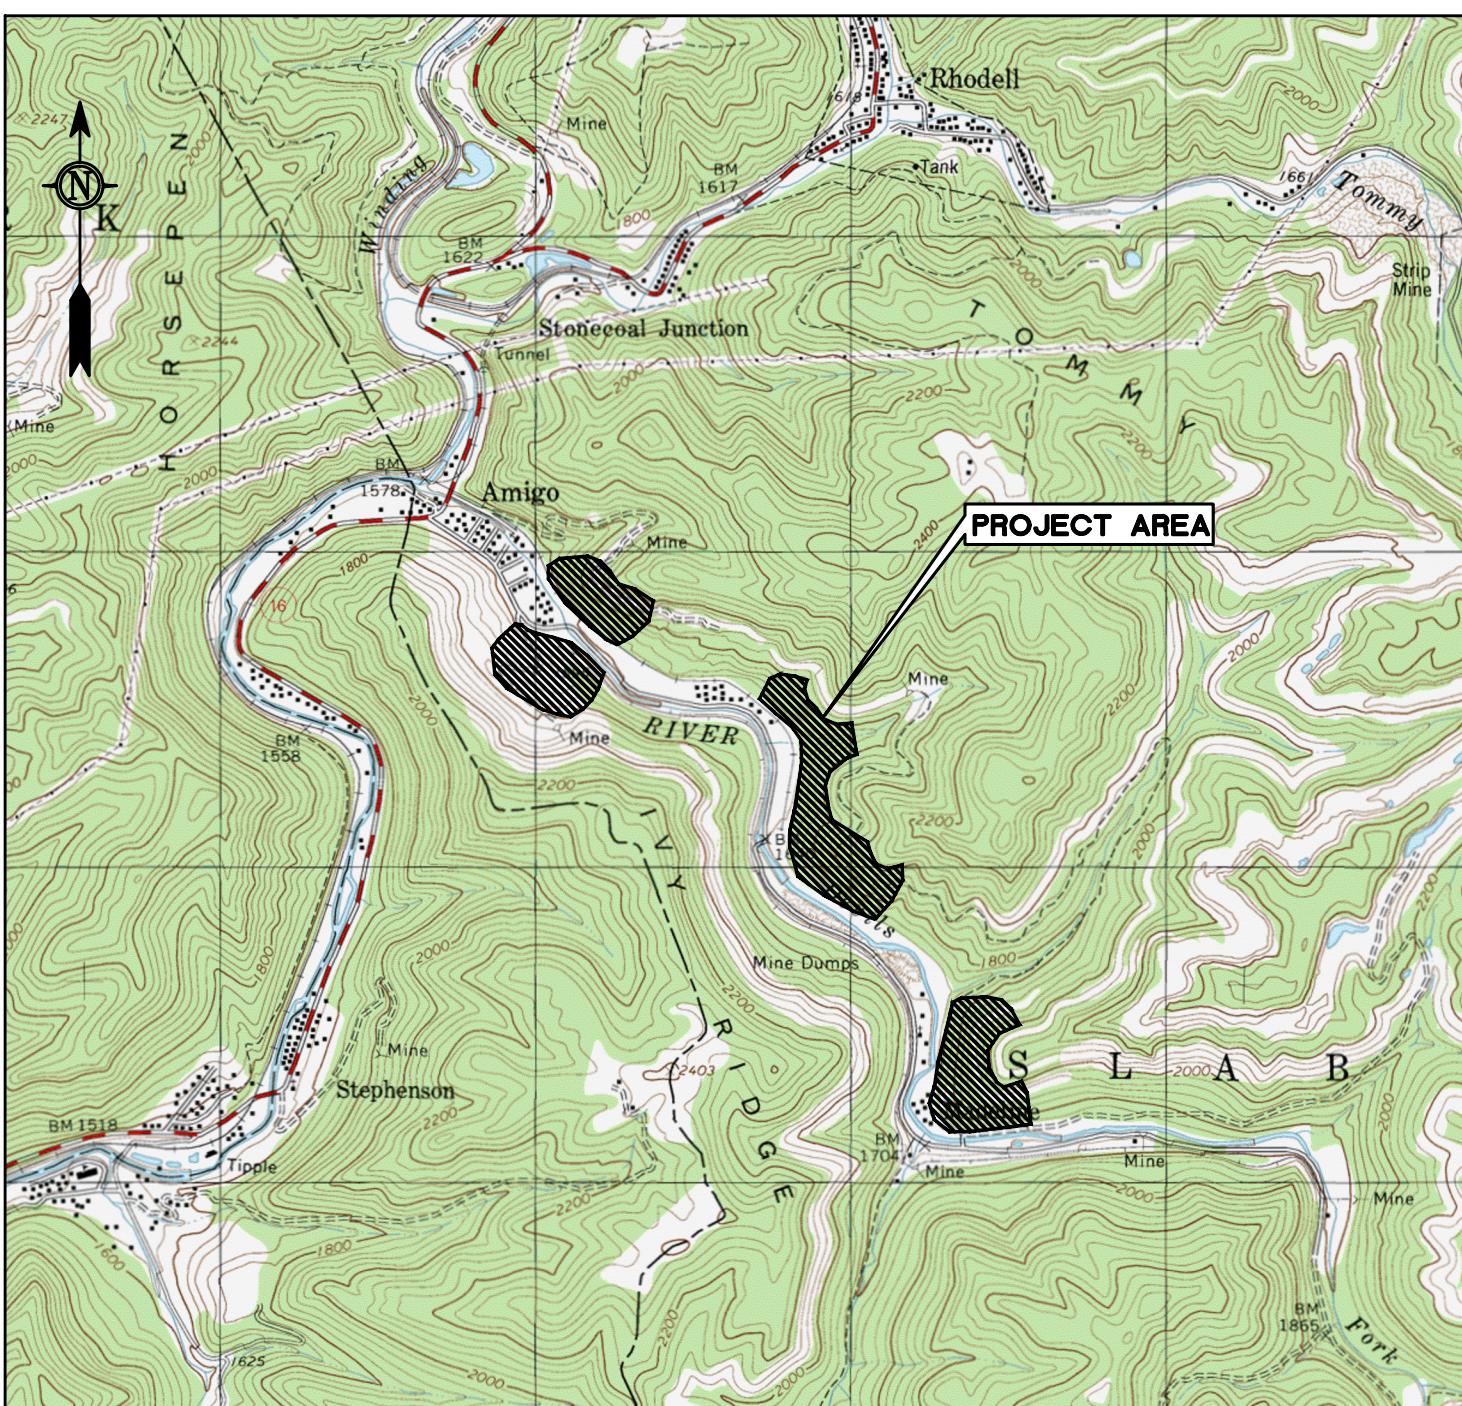

MAPPING REFERENCE:
CRUMMER, WEST VIRGINIA
U.S.G.S. 7.5 MINUTE QUADRANGLE
1997

BID FORM


ITEM NO.	QUANTITY	DESCRIPTION	UNIT PRICE	AMOUNT
1.0	1	"Mobilization and Demobilization," per lump sum. Cannot be more than 10% of the Total Amount Bid for the project.	ls.	\$
2.0	1	"Construction Layout," per lump sum. Cannot be more than 3% of the Total Amount Bid for the project.	ls.	\$
3.0	1	"Quality Control," per lump sum. Cannot be more than 3% of the Total Amount Bid for the project.	ls.	\$
4.1	1	"Site Preparation," per lump sum. Cannot be more than 10% of the Total Amount Bid for the project.	ls.	\$
4.2	200	"Class I Aggregate," per ton	\$	\$
4.3	120	"Temporary Culvert," per linear foot	\$	\$
5.1	2,700	"Silt Fence," per linear foot	\$	\$
5.2	2,700	"Straw Wattles," per linear foot	\$	\$
5.3	6	"Stabilized Construction Entrance," per each	\$	\$
5.4	500	"Rock Check Dams," per linear foot	\$	\$
6.0	6	"Revegetation," per plan view acre	\$	\$
7.1	60	"2-Foot Deep Ripping 2H:1V VEE Channel," per linear foot	\$	\$
7.2	900	"Stream Bank Protection," per linear foot	\$	\$
7.3	1	"Type A Manhole," per each	\$	\$
9.1	2	"Wet/Modified Wet Seal," per each	\$	\$
9.2	13	"Bar Gate," per each	\$	\$
9.3	1	"Dry Seal," per each	\$	\$
9.4	2	"Low Slump Concrete Dry Seal," per each	\$	\$
9.5	100	"Soda Ash Briquettes," per 50 pound bag	\$	\$
10.1	100	"Underdrain," per linear foot	\$	\$
10.2	100	"12-inch Conveyance Pipe," per linear foot	\$	\$
12.0	1,000	"Erosion Control Matting," per square yard	\$	\$
TOTAL			\$	

SHEET INDEX


DRAWING NO.	DESCRIPTION
1	TITLE AND SHEET INDEX
2	GENERAL NOTES AND SURVEY CONTROL POINT LOCATIONS
3	COMPOSITE
4 - 12	EXISTING CONDITIONS
13 - 21	EROSION & SEDIMENTATION
22 - 30	PROPOSED
31 - 39	TAX MAP OVERLAY
40	CHANNEL AND MISCELLANEOUS DETAILS
41	MISCELLANEOUS DETAILS
42 - 44	MINE SEAL DETAILS

PLANS PREPARED BY:


gai consultants
300 SUMMERS STREET, SUITE 1100
CHARLESTON, WEST VIRGINIA 25301
304-926-8100

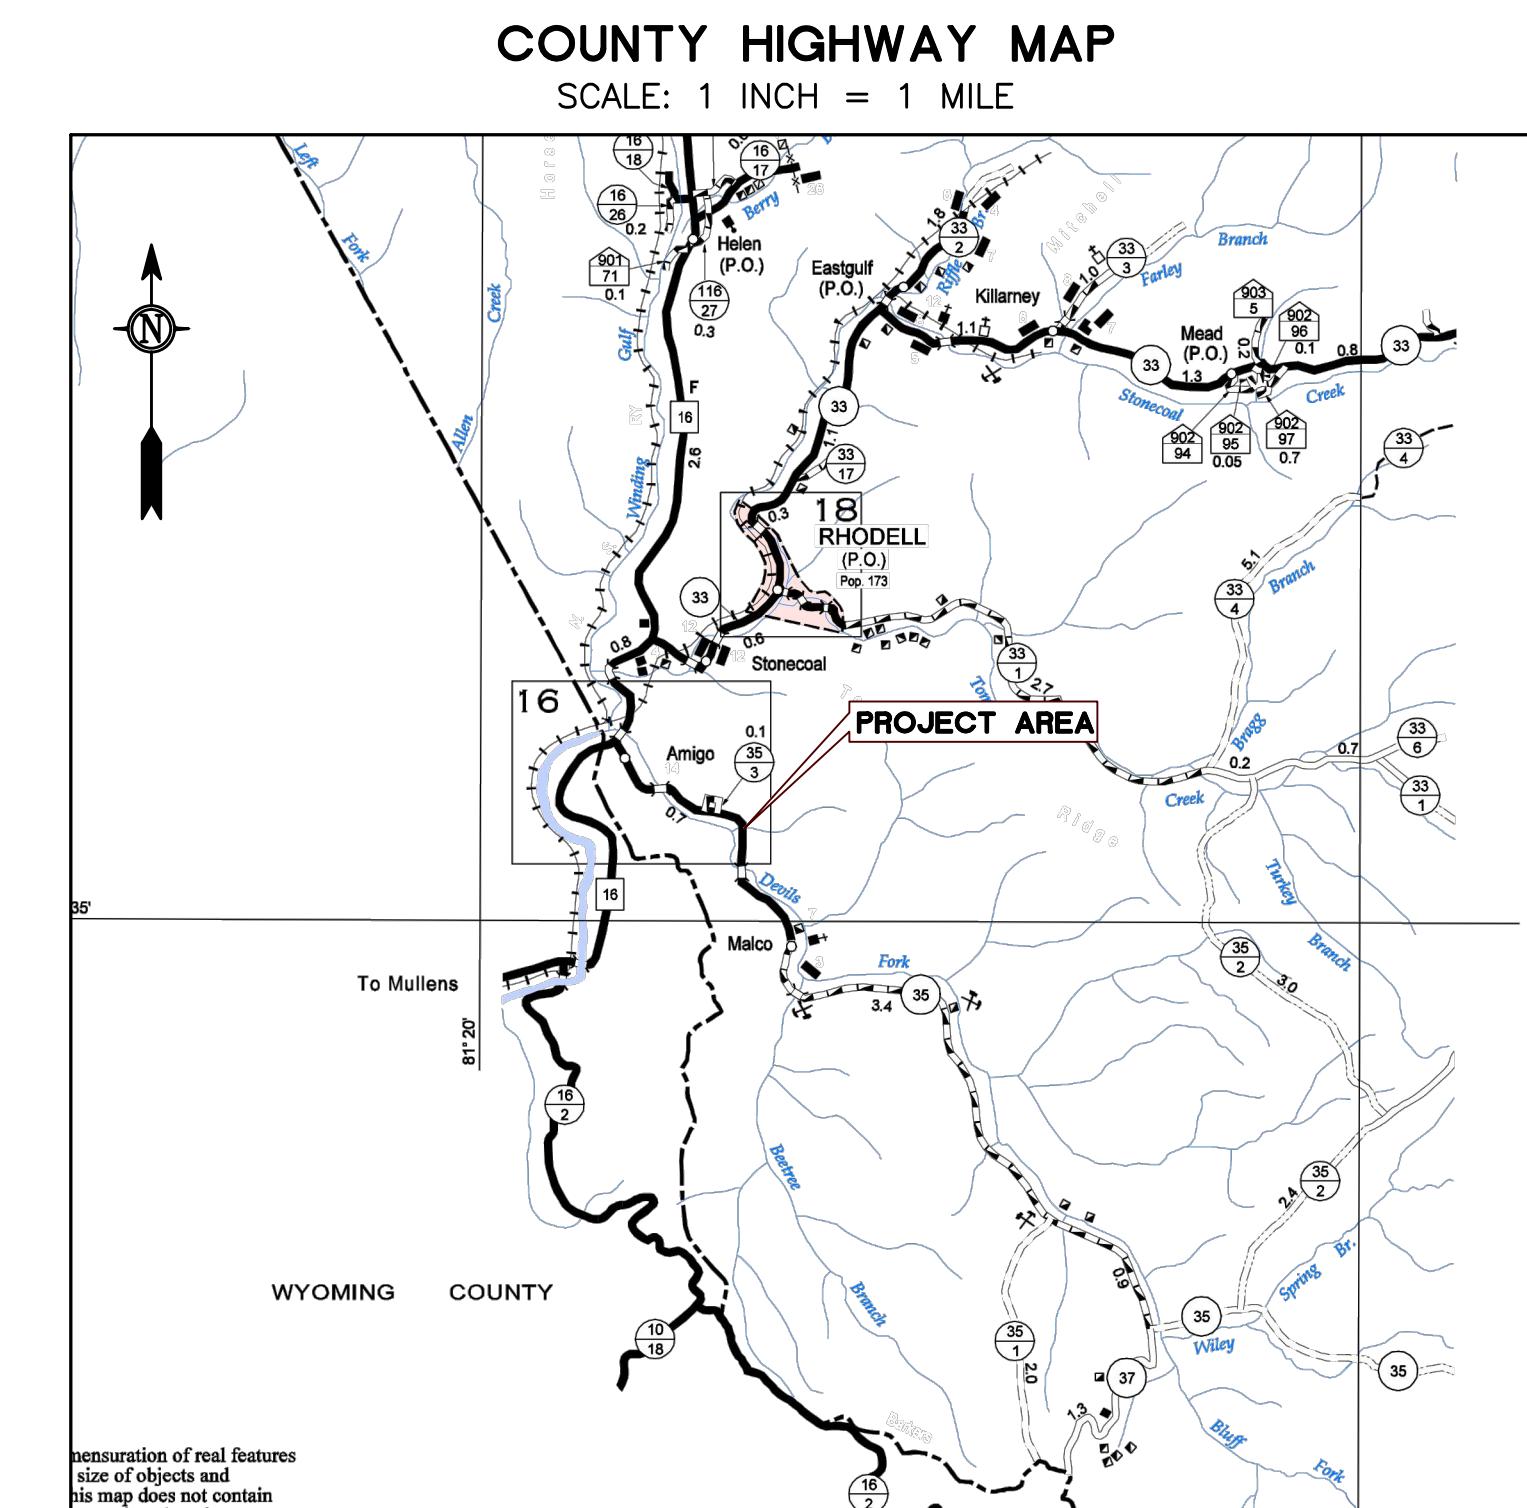


MAPPING REFERENCE
WYOMING COUNTY
GENERAL HIGHWAY MAP
(2011)

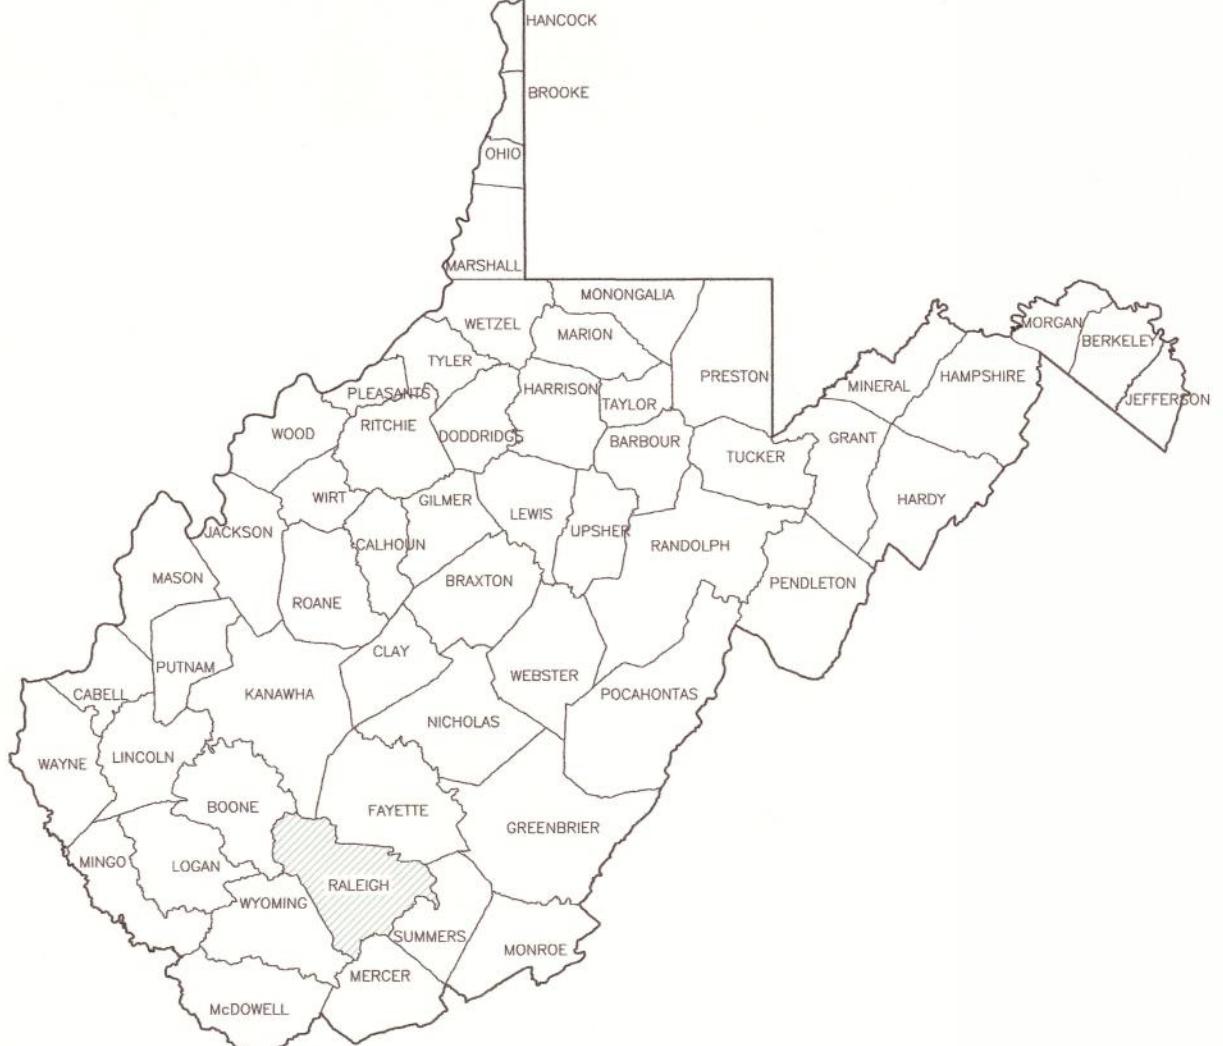

west virginia department of environmental protection

EARL RAY TOMBLIN, GOVERNOR
RANDY C. HUFFMAN, CABINET SECRETARY
OFFICE OF ABANDONED MINE LANDS
AMIGO PORTALS
RALEIGH COUNTY, WEST VIRGINIA

U.S.G.S. LOCATION MAP
SCALE: 1 INCH = 2000 FEET

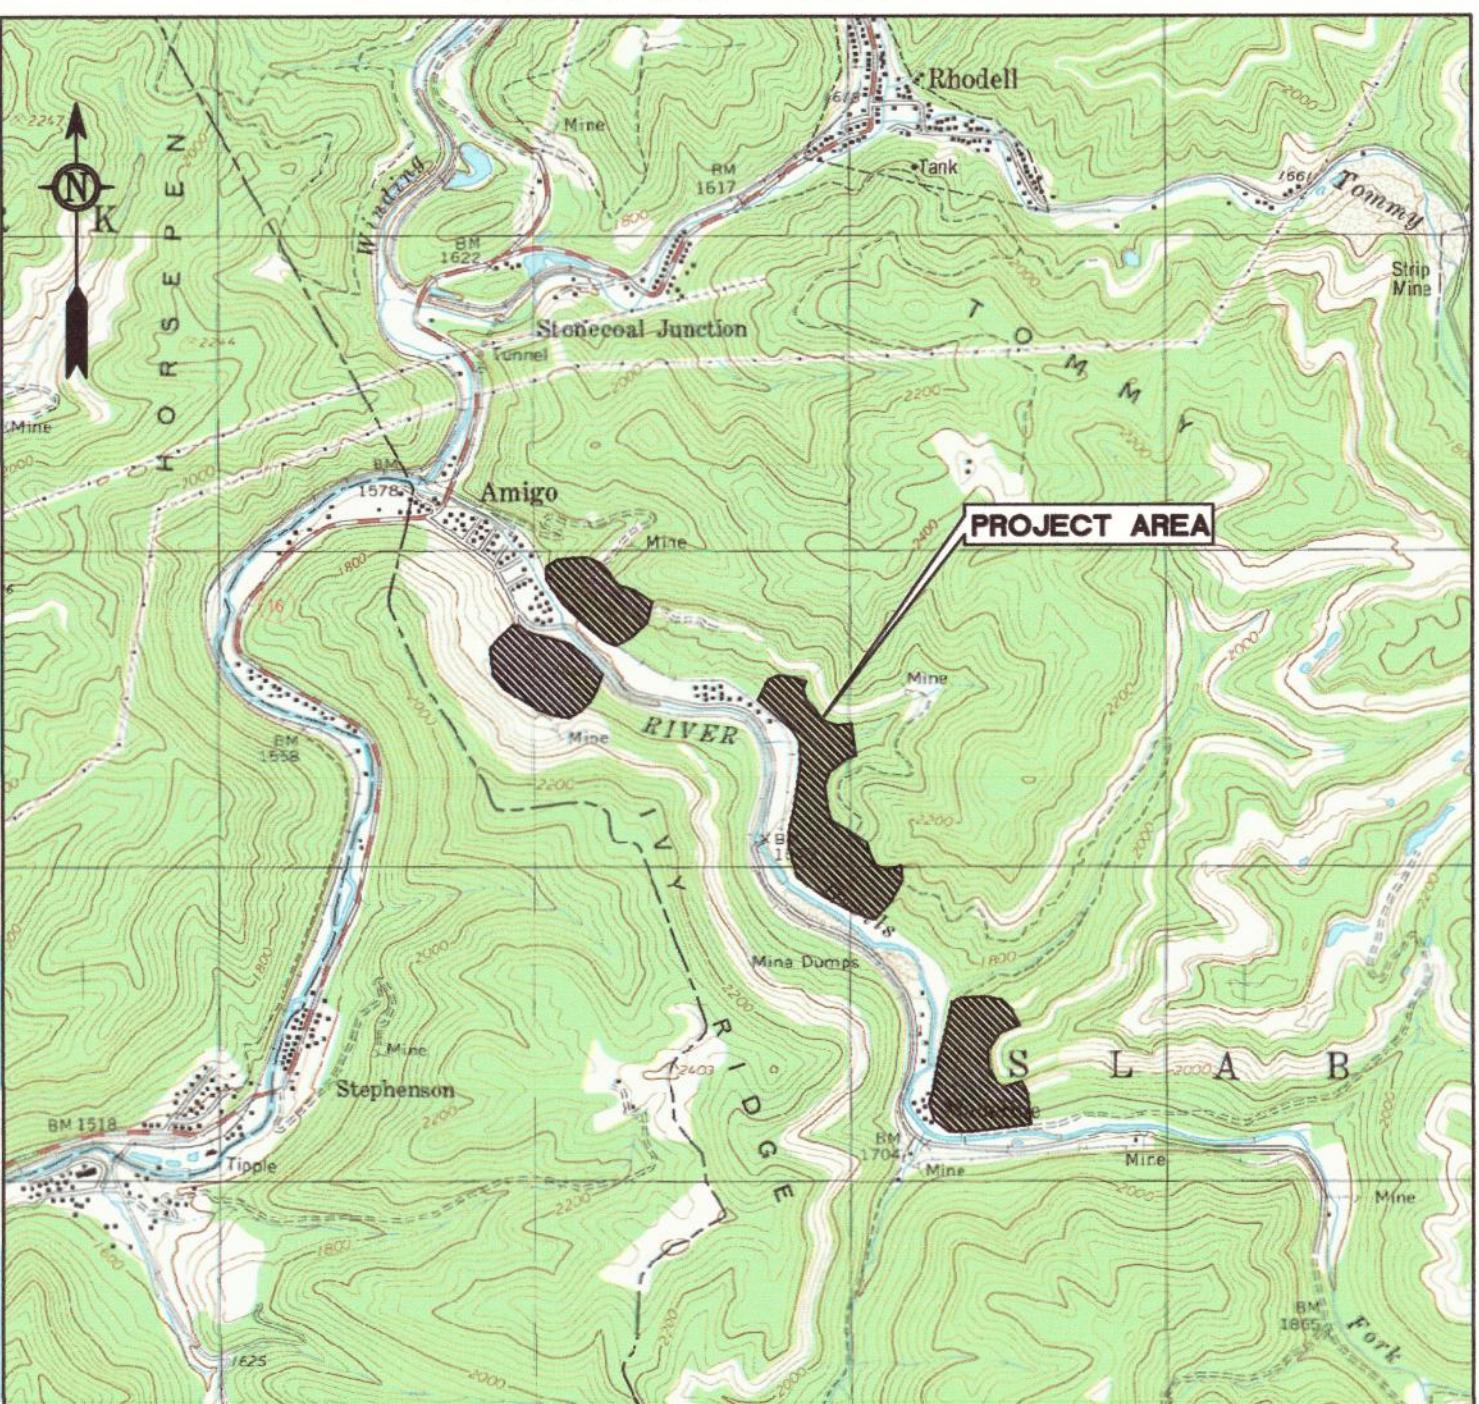

MAPPING REFERENCE:
CRUMPLER, WEST VIRGINIA
U.S.G.S. 7.5 MINUTE QUADRANGLE
1997

BID FORM

ITEM NO.	QUANTITY	DESCRIPTION	UNIT PRICE	AMOUNT
1.0	1	"Mobilization and Demobilization," per lump sum. Cannot be more than 10% of the Total Amount Bid for the project.	ls.	\$
2.0	1	"Construction Layout," per lump sum. Cannot be more than 3% of the Total Amount Bid for the project.	ls.	\$
3.0	1	"Quality Control," per lump sum. Cannot be more than 3% of the Total Amount Bid for the project.	ls.	\$
4.1	1	"Site Preparation," per lump sum. Cannot be more than 10% of the Total Amount Bid for the project.	ls.	\$
4.2	200	"Class 1 Aggregate," per ton	\$	\$
4.3	120	"Temporary Culvert," per linear foot	\$	\$
5.1	2,700	"Silt Fence," per linear foot	\$	\$
5.2	2,700	"Straw Wattles," per linear foot	\$	\$
5.3	6	"Stabilized Construction Entrance," per each	\$	\$
5.4	500	"Rock Check Dams," per linear foot	\$	\$
6.0	6	"Revegetation," per plan view acre	\$	\$
7.1	60	"2-Foot Deep Riprap 2H:1V VEE Channel," per linear foot	\$	\$
7.2	900	"Stream Bank Protection," per linear foot	\$	\$
7.3	1	"Type A Manhole," per each	\$	\$
9.1	2	"Wet/Modified Wet Seal," per each	\$	\$
9.2	13	"Bar Gate," per each	\$	\$
9.3	1	"Dry Seal," per each	\$	\$
9.4	2	"Low Slump Concrete Dry Seal," per each	\$	\$
9.5	100	"Soda Ash Briquettes," per 50 pound bag	\$	\$
10.1	100	"Underdrain," per linear foot	\$	\$
10.2	100	"12-inch Conveyance Pipe," per linear foot	\$	\$
12.0	1,000	"Erosion Control Matting," per square yard	\$	\$
TOTAL				\$

SHEET INDEX

DRAWING NO.	DESCRIPTION
1	TITLE AND SHEET INDEX
2	GENERAL NOTES AND SURVEY CONTROL POINT LOCATIONS
3	COMPOSITE
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41	MISCELLANEOUS DETAILS
42 - 44	MINE SEAL DETAILS


PLANS PREPARED BY:




gai consultants
300 SUMMERS STREET, SUITE 1100
CHARLESTON, WEST VIRGINIA 25301
304-926-8100



1-15-14
Charles F. Straley, PE

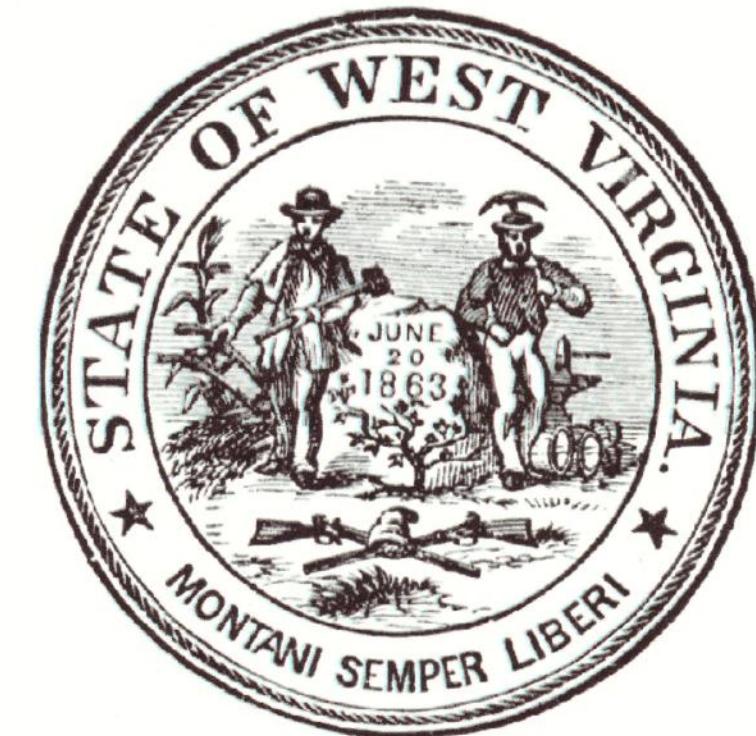

COUNTY HIGHWAY MAP
SCALE: 1 INCH = 1 MILE

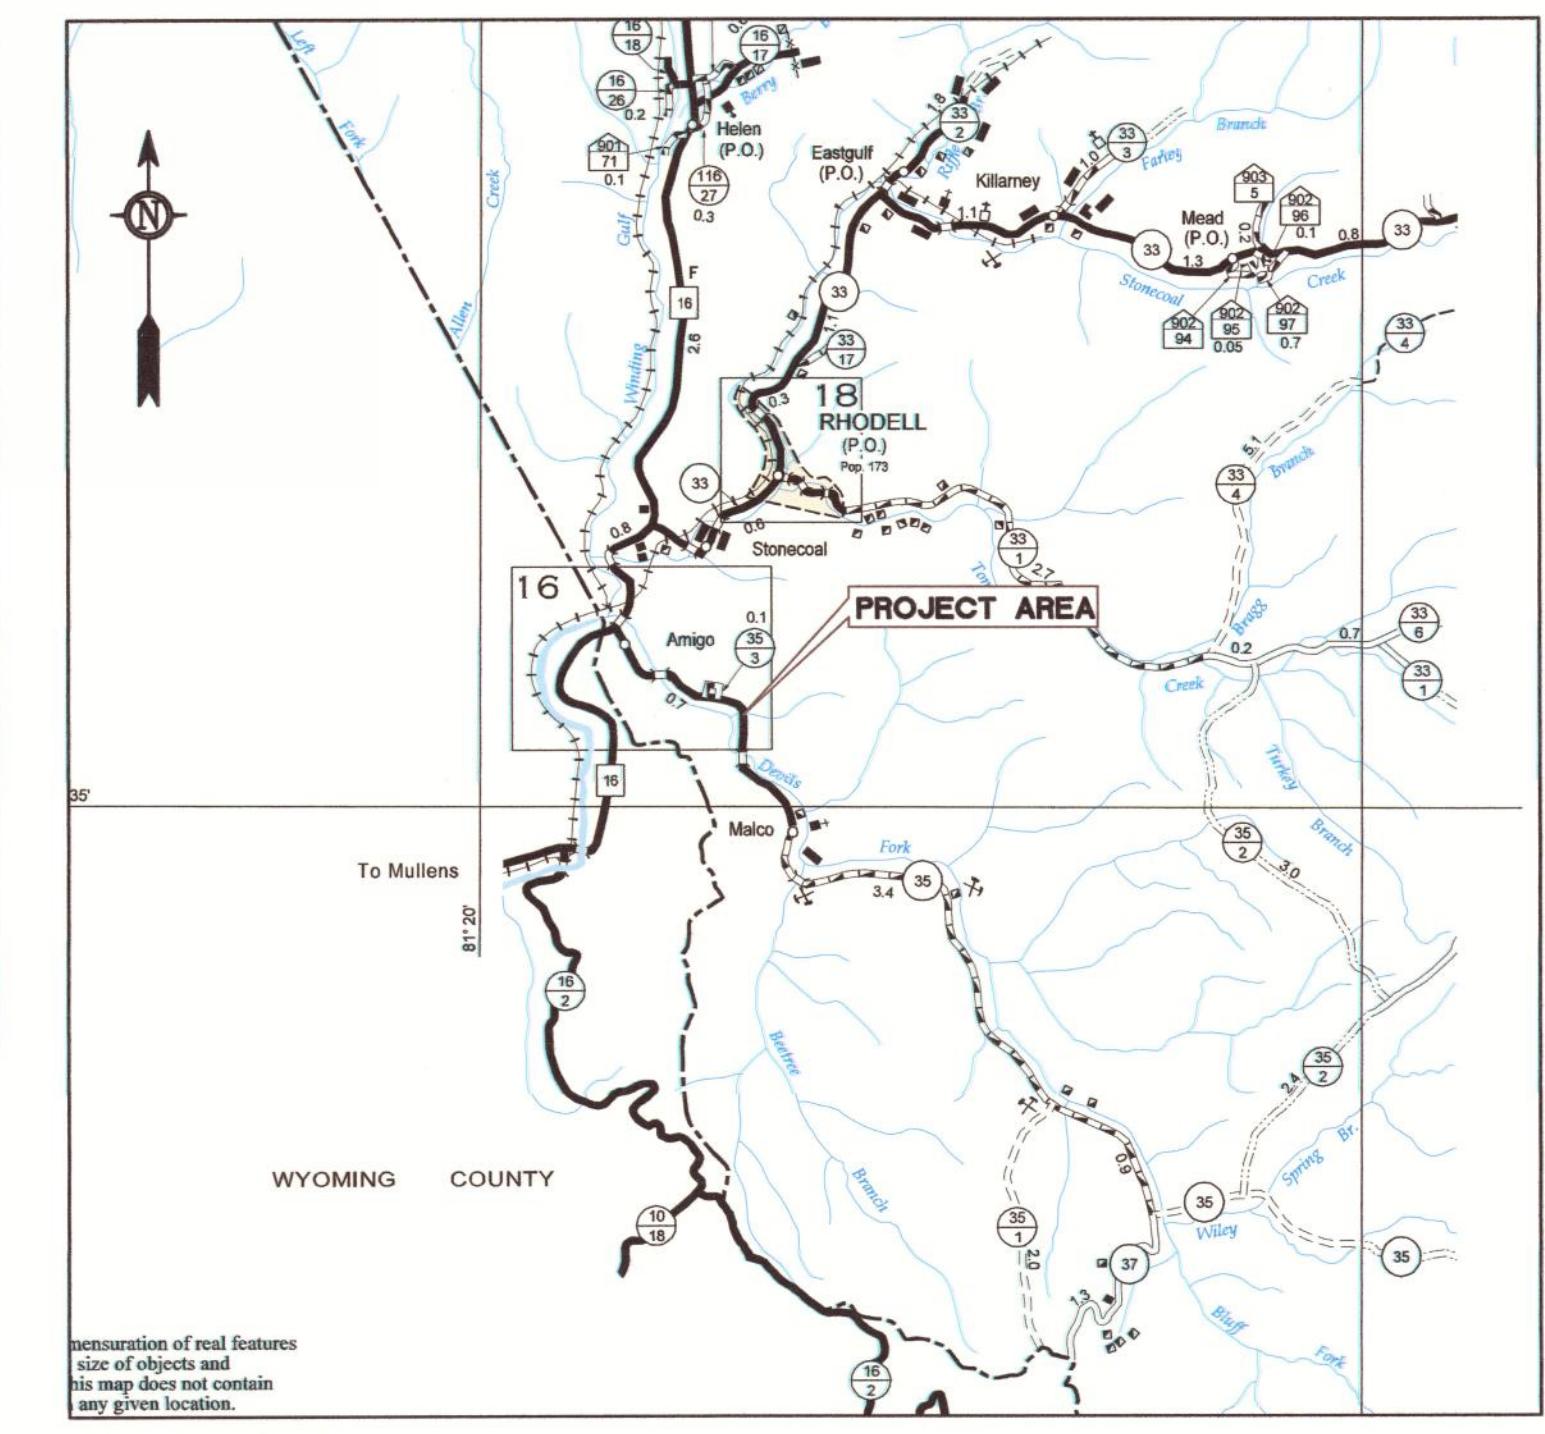

MAPPING REFERENCE:
RALEIGH COUNTY, WEST VIRGINIA
GENERAL HIGHWAY MAP
(2011)

gai consultants
Transforming ideas into reality

AMIGO PORTALS

RALEIGH COUNTY, WV

PLOT SCALE:

TAC

DRAWN BY:

TAC

CHECKED BY:

JTG

APPROVED BY:

CFS

DATE:

January 14, 2014

PROJECT NUMBER:

E130389

GENERAL NOTES &
SURVEY CONTROL
POINT LOCATIONS

REVISED

SCALE
N/A

DRAWING NUMBER

2

LEGEND


CULVERT	EXISTING FEATURE
CULVERT	PROPOSED FEATURE
----- 650 -----	EXISTING CONTOUR (SURVEY)
----- 700 -----	PROPOSED CONTOUR
----- CWL -----	CONSTRUCTION WORK LIMIT
-----	EXISTING STREAM OR PRIMARY FLOW PATH
-----	EXISTING ROAD
----- OHE -----	EXISTING OVERHEAD ELECTRIC
----- OHU -----	EXISTING OVERHEAD UTILITY
-----	PROPOSED CHANNEL CENTERLINE AND TOP EDGES (AT MIN. DEPTH)
x 680.5	SPOT ELEVATION, PROPOSED GRADE
600.5 x	SPOT ELEVATION, EXISTING GROUND SURFACE
----- SW -----	STRAW WATTLE
----- SF -----	SILT FENCE
-----	EXISTING STORM SEWER LINE
----- ← -----	FLOW DIRECTION
-----	PROPERTY LINE
----- X ----- X ----- X ----- X -----	PROPOSED FENCE
(7) 123	PARCEL NUMBER
1 12	DETAIL NUMBER 1 (OR SECTION OR PROFILE REFERENCE) DRAWING 12
	RIPRAP/ROCK
	COMPACTED BACKFILL
	EX. CONCRETE PAVING
	EX. ASPHALT PAVING
	EX. GRAVEL PAVING
	AGGREGATE PLACEMENT

GENERAL NOTES

- IT SHALL BE THE SOLE RESPONSIBILITY OF THE CONTRACTOR TO LOCATE AND AVOID ALL UTILITIES, FACILITIES, AND OTHER STRUCTURES AND OBSTRUCTIONS. UTILITY LOCATIONS ARE BASED ON INFORMATION PROVIDED ON THE BASE MAPPING, ADDITIONAL SURVEYING, AND ON SITE OBSERVATIONS, AND MAY NOT BE ALL INCLUSIVE. ACTUAL LOCATIONS MAY DEVIATE FROM THAT SHOWN. ALL UTILITIES SHALL BE FIELD VERIFIED PRIOR TO CONSTRUCTION. CONTACT EACH RESPECTIVE UTILITY/LANDOWNER FOR SERVICE LINE LOCATIONS.
- SANITARY SYSTEMS, STORM DRAINS, AND CULVERTS ARE NOT SHOWN OR ARE NOT SHOWN IN THEIR ENTIRETY AND MUST BE LOCATED BY THE CONTRACTOR PRIOR TO CONSTRUCTION.
- ALL FENCES ARE NOT DEPICTED. THE CONTRACTOR SHALL REPAIR/REPLACE ANY EXISTING FENCES AND GATES THAT ARE DAMAGED/DESTROYED BY THE CONTRACTOR AT HIS OWN EXPENSE.
- THE CONTRACTOR SHALL MAINTAIN UNRESTRICTED ACCESS AT THE SITE AT ALL TIMES DURING CONSTRUCTION.
- LOCATIONS OF SURVEY CONTROL POINTS SHOULD BE FIELD VERIFIED PRIOR TO COMMENCING WORK. FIELD VERIFICATION OF CROSS SECTIONS SHALL ALSO BE COMPLETED AND ACCEPTED BY THE WVDEP PRIOR TO COMMENCING WORK.
- REFER TO THE OTHER DRAWINGS FOR SPECIFIC NOTES REGARDING THE RECLAMATION WORK.
- ALL DISTURBED AREAS WITHIN THE CONSTRUCTION WORK LIMIT SHALL BE REVEGETATED. ALL OTHER AREAS DISTURBED BY THE CONTRACTOR OUTSIDE THE CONSTRUCTION WORK LIMIT SHALL BE REVEGETATED AT THE CONTRACTOR'S OWN EXPENSE.
- IT IS POSSIBLE THAT CERTAIN ASPECTS OF THE BASE TOPOGRAPHIC MAPPING MAY BE DIFFERENT FROM CONDITIONS EXISTING IN THE FIELD. OTHER NATURAL OCCURRENCES SUCH AS EROSION MAY HAVE RESULTED IN CONDITIONS DIFFERENT THAN SHOWN ON THE BASE MAPPING.
- CONTOUR INTERVAL OF BASE MAPPING IS 2-FOOT. CERTAIN AREAS OF PROPOSED GRADING VARY IN CONTOUR INTERVAL.
- THE CONTRACTOR SHALL UTILIZE EXISTING ACCESS ROADS TO THE PROJECT AREA IN ACCORDANCE WITH THE SPECIFICATIONS.

CONTROL POINTS				
CONTROL POINT	NORTHING (FT)	EASTING (FT)	ELEVATION (FT)	REF PLAN SHEET
1	216299.885	1876740.977	1589.97	5
2	216233.890	1877043.286	1593.92	5
3	216083.137	1877133.426	1595.62	5
4	215203.446	1879207.313	1626.70	7
5	214949.039	1879310.050	1633.37	7
6	214791.721	1879256.976	1631.53	7
7	214030.892	1879128.366	1642.98	8
8	213912.131	1879090.141	1643.76	8
9	213537.550	1879340.727	1648.09	9
10	213399.265	1879610.111	1652.33	9
11	212287.179	1880723.694	1676.33	11
12	212170.055	1880731.617	1675.74	11
13	210854.549	1881014.742	1706.13	12
14	210811.291	1881317.494	1713.33	12

SURVEY CONTROL POINT LOCATIONSKnow what's below.
Call before you dig.

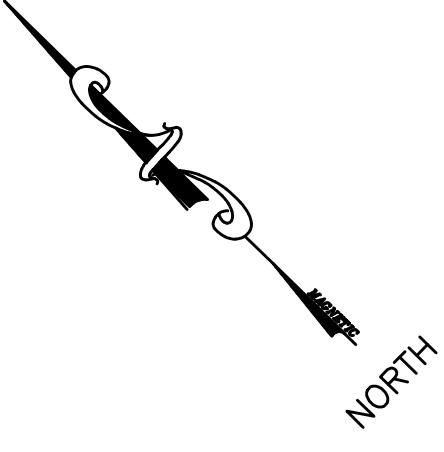

NORTH

LEGEND:


- PROP. 10' CONTOURS
- EX. 10' CONTOURS
- EX. 2' CONTOURS
- EX. WATER LINE
- EX. FENCE LINE
- CONSTRUCTION WORK LIMITS
- EX. OVERHEAD ELECTRIC
- EX. CULVERT
- EX. TREE LINE
- EX. REFUSE LIMITS


MAPPING REFERENCE:

CONTROL SURVEY BY MEAD & HUNT DATED 4/19/13.



Know what's below.
Call before you dig.

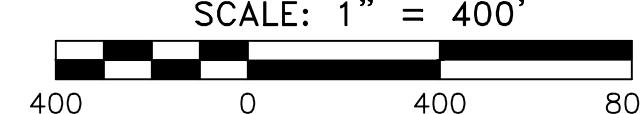SCALE: 1" = 400'

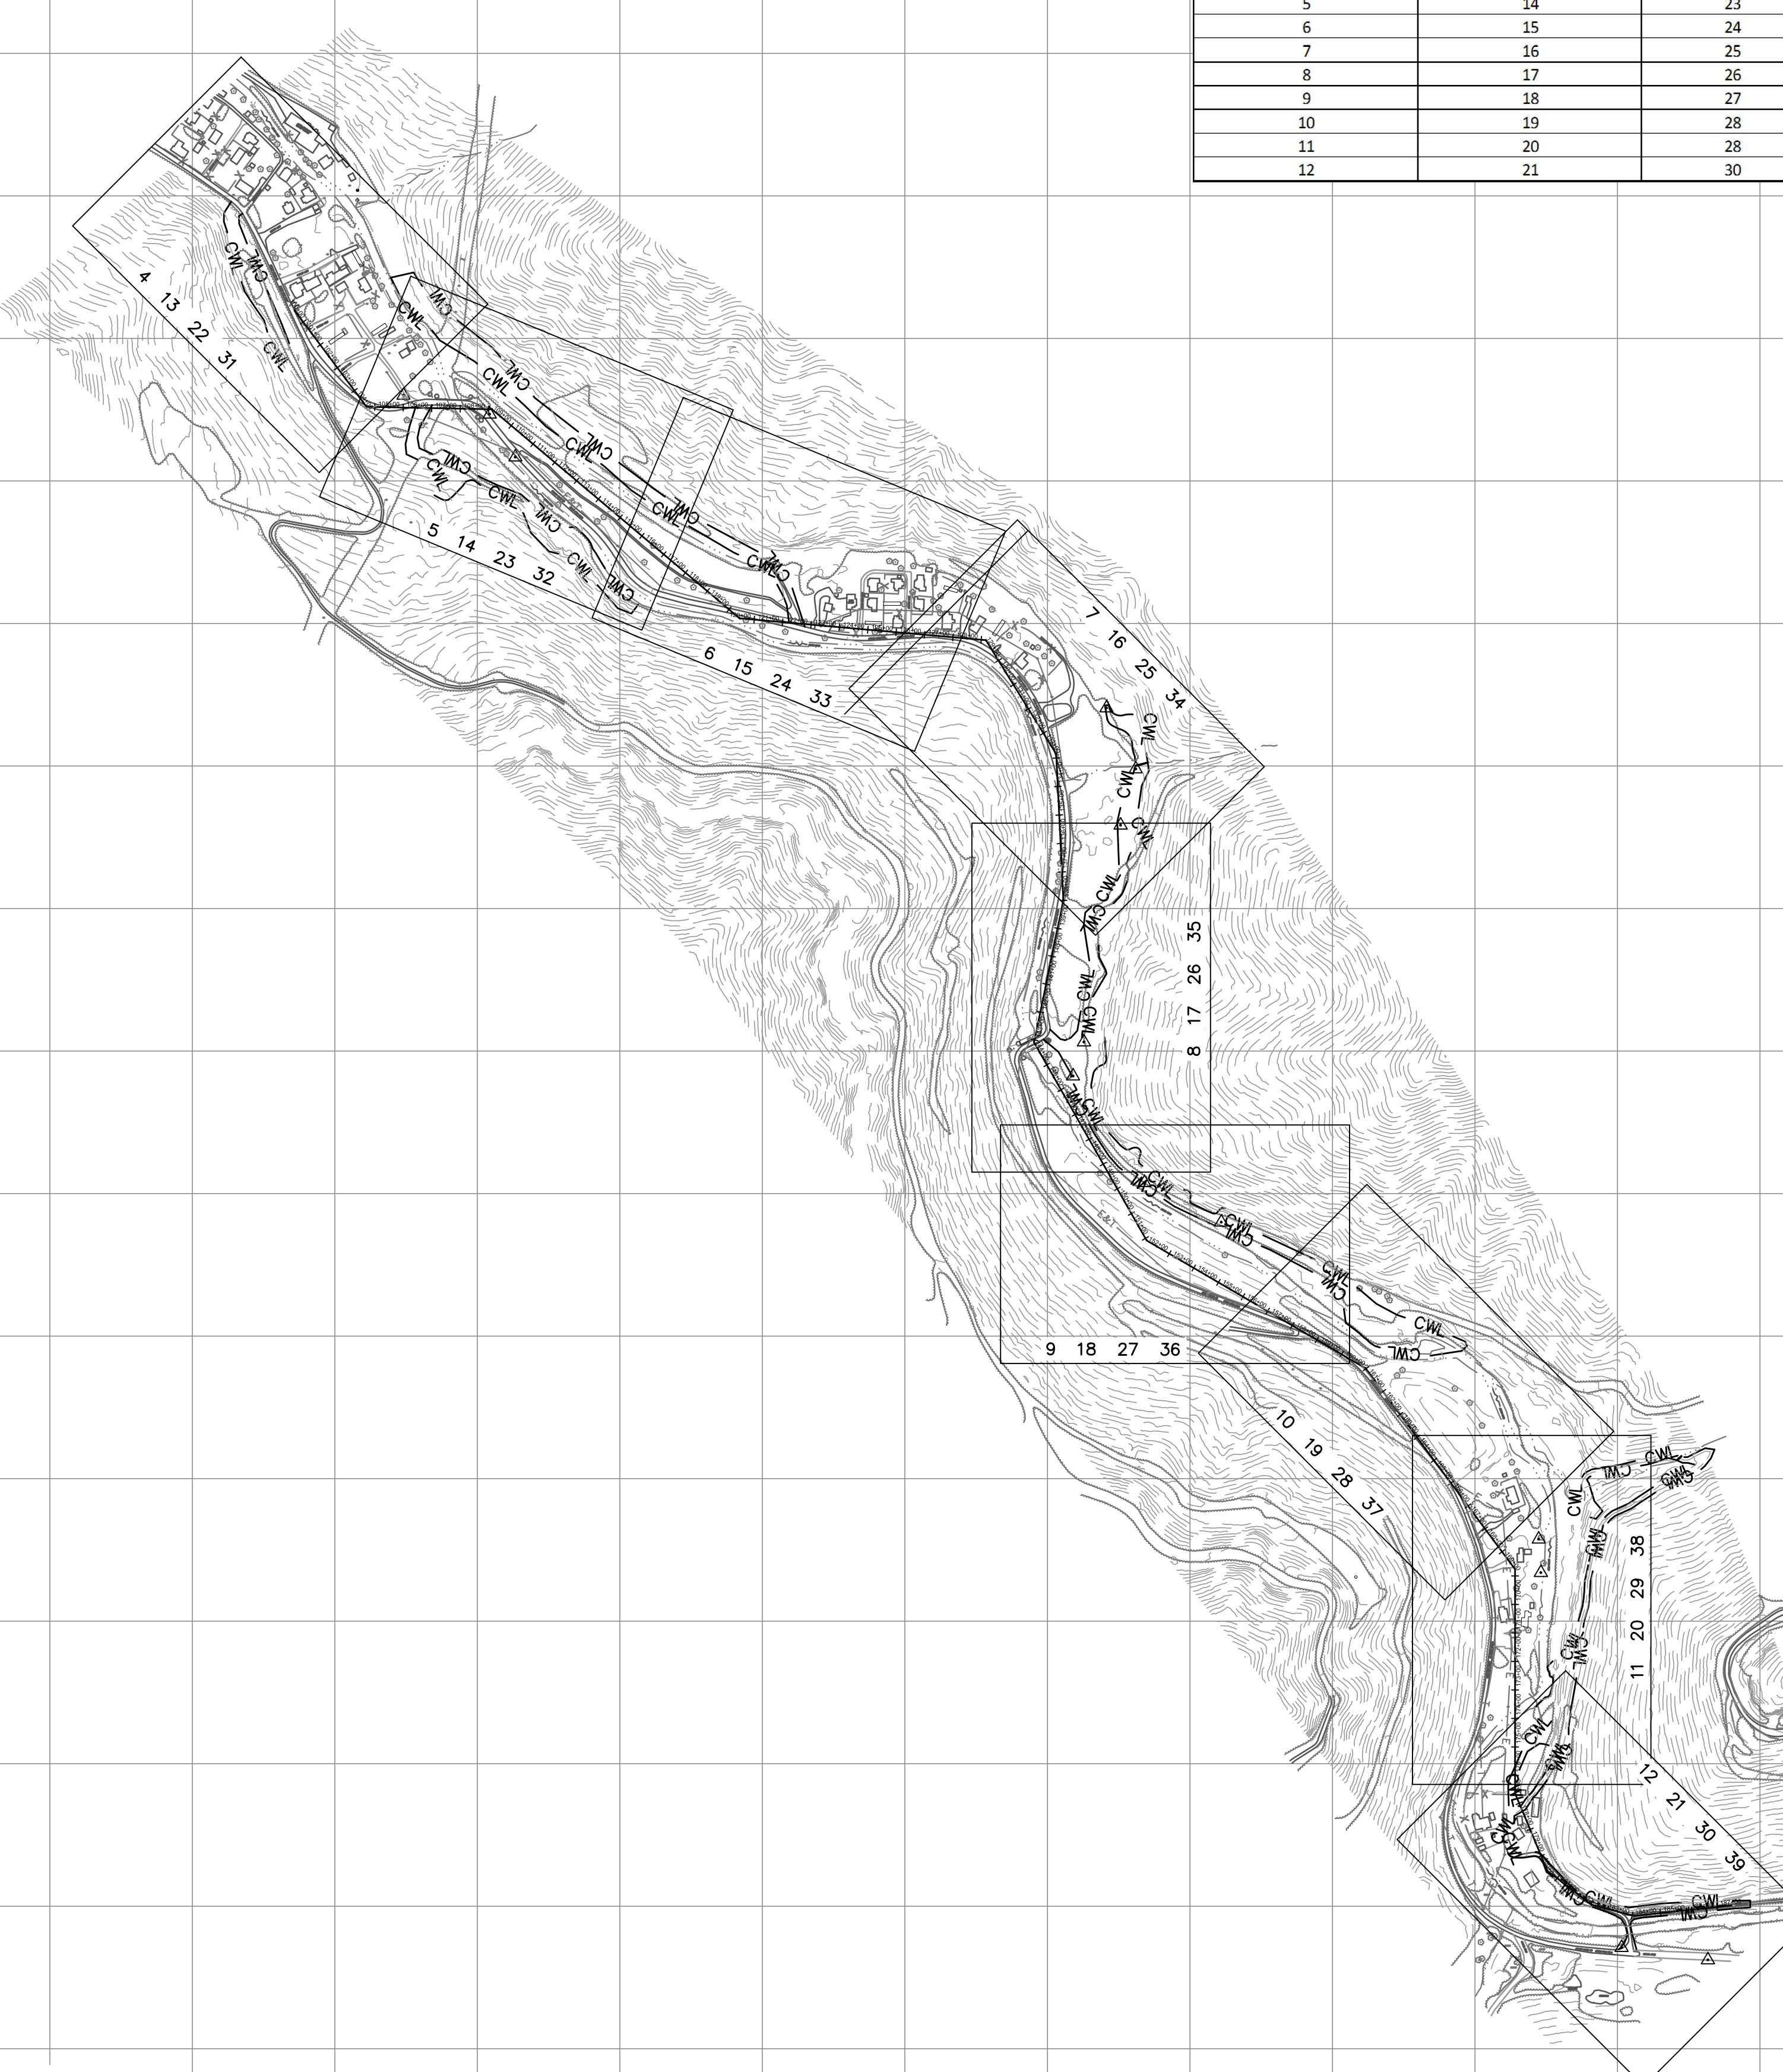


SHEET INDEX			
EXISTING CONDITIONS	EROSION & SEDIMENTATION	PROPOSED	TAX MAP OVERLAY
4	13	22	31
5	14	23	32
6	15	24	33
7	16	25	34
8	17	26	35
9	18	27	36
10	19	28	37
11	20	28	38
12	21	30	39

GAI CONSULTANTS, INC.

300 SUMMERS STREET, SUITE 100
CHARLESTON, WEST VIRGINIA 25301
P: 304. 926. 8100 F: 304. 926. 9180

AMIGO PORTALS

RALEIGH COUNTY, WV

COMPOSITE


PLOT SCALE:
1/1
DESIGNED BY:
TAC
DRAWN BY:
TAC
CHECKED BY:
JTG
APPROVED BY:
CFS
DATE:
January 14, 2014
PROJECT NUMBER:
E130389


REVISED

REV. NO. DATE DESCRIPTION

SCALE
1" = 400'
DRAWING NUMBER
3

MATCHLINE SHEET 5

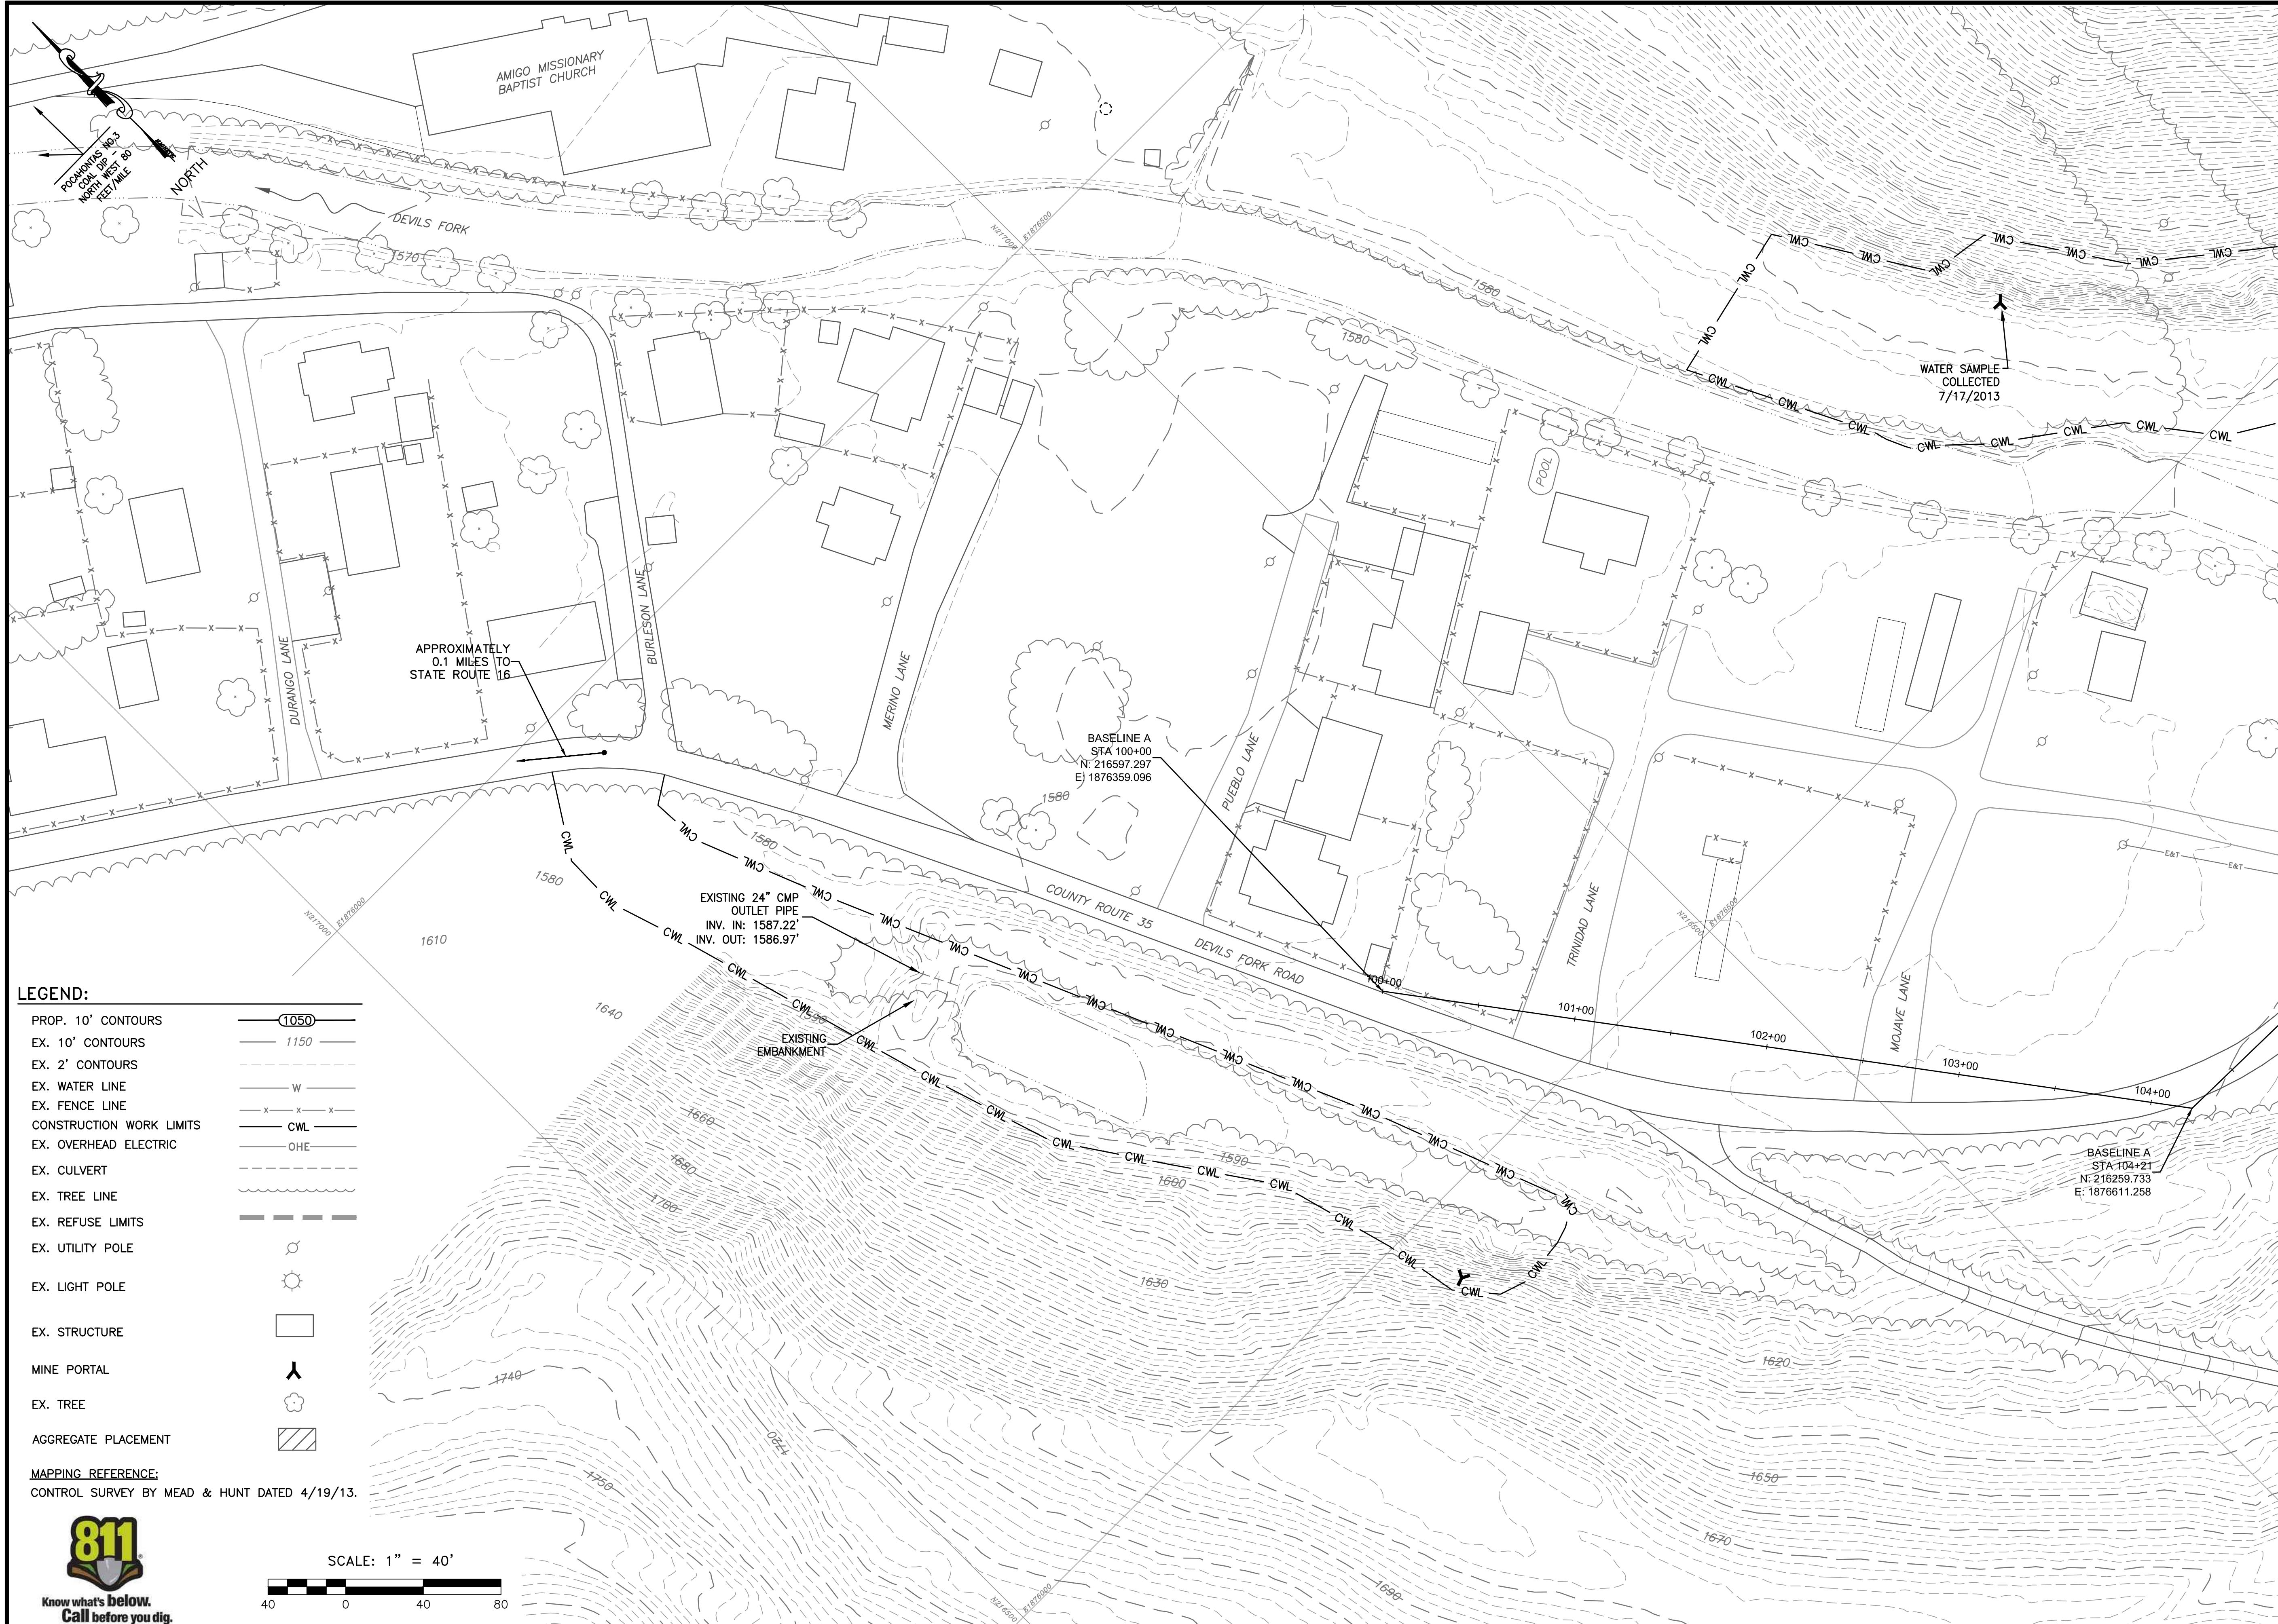

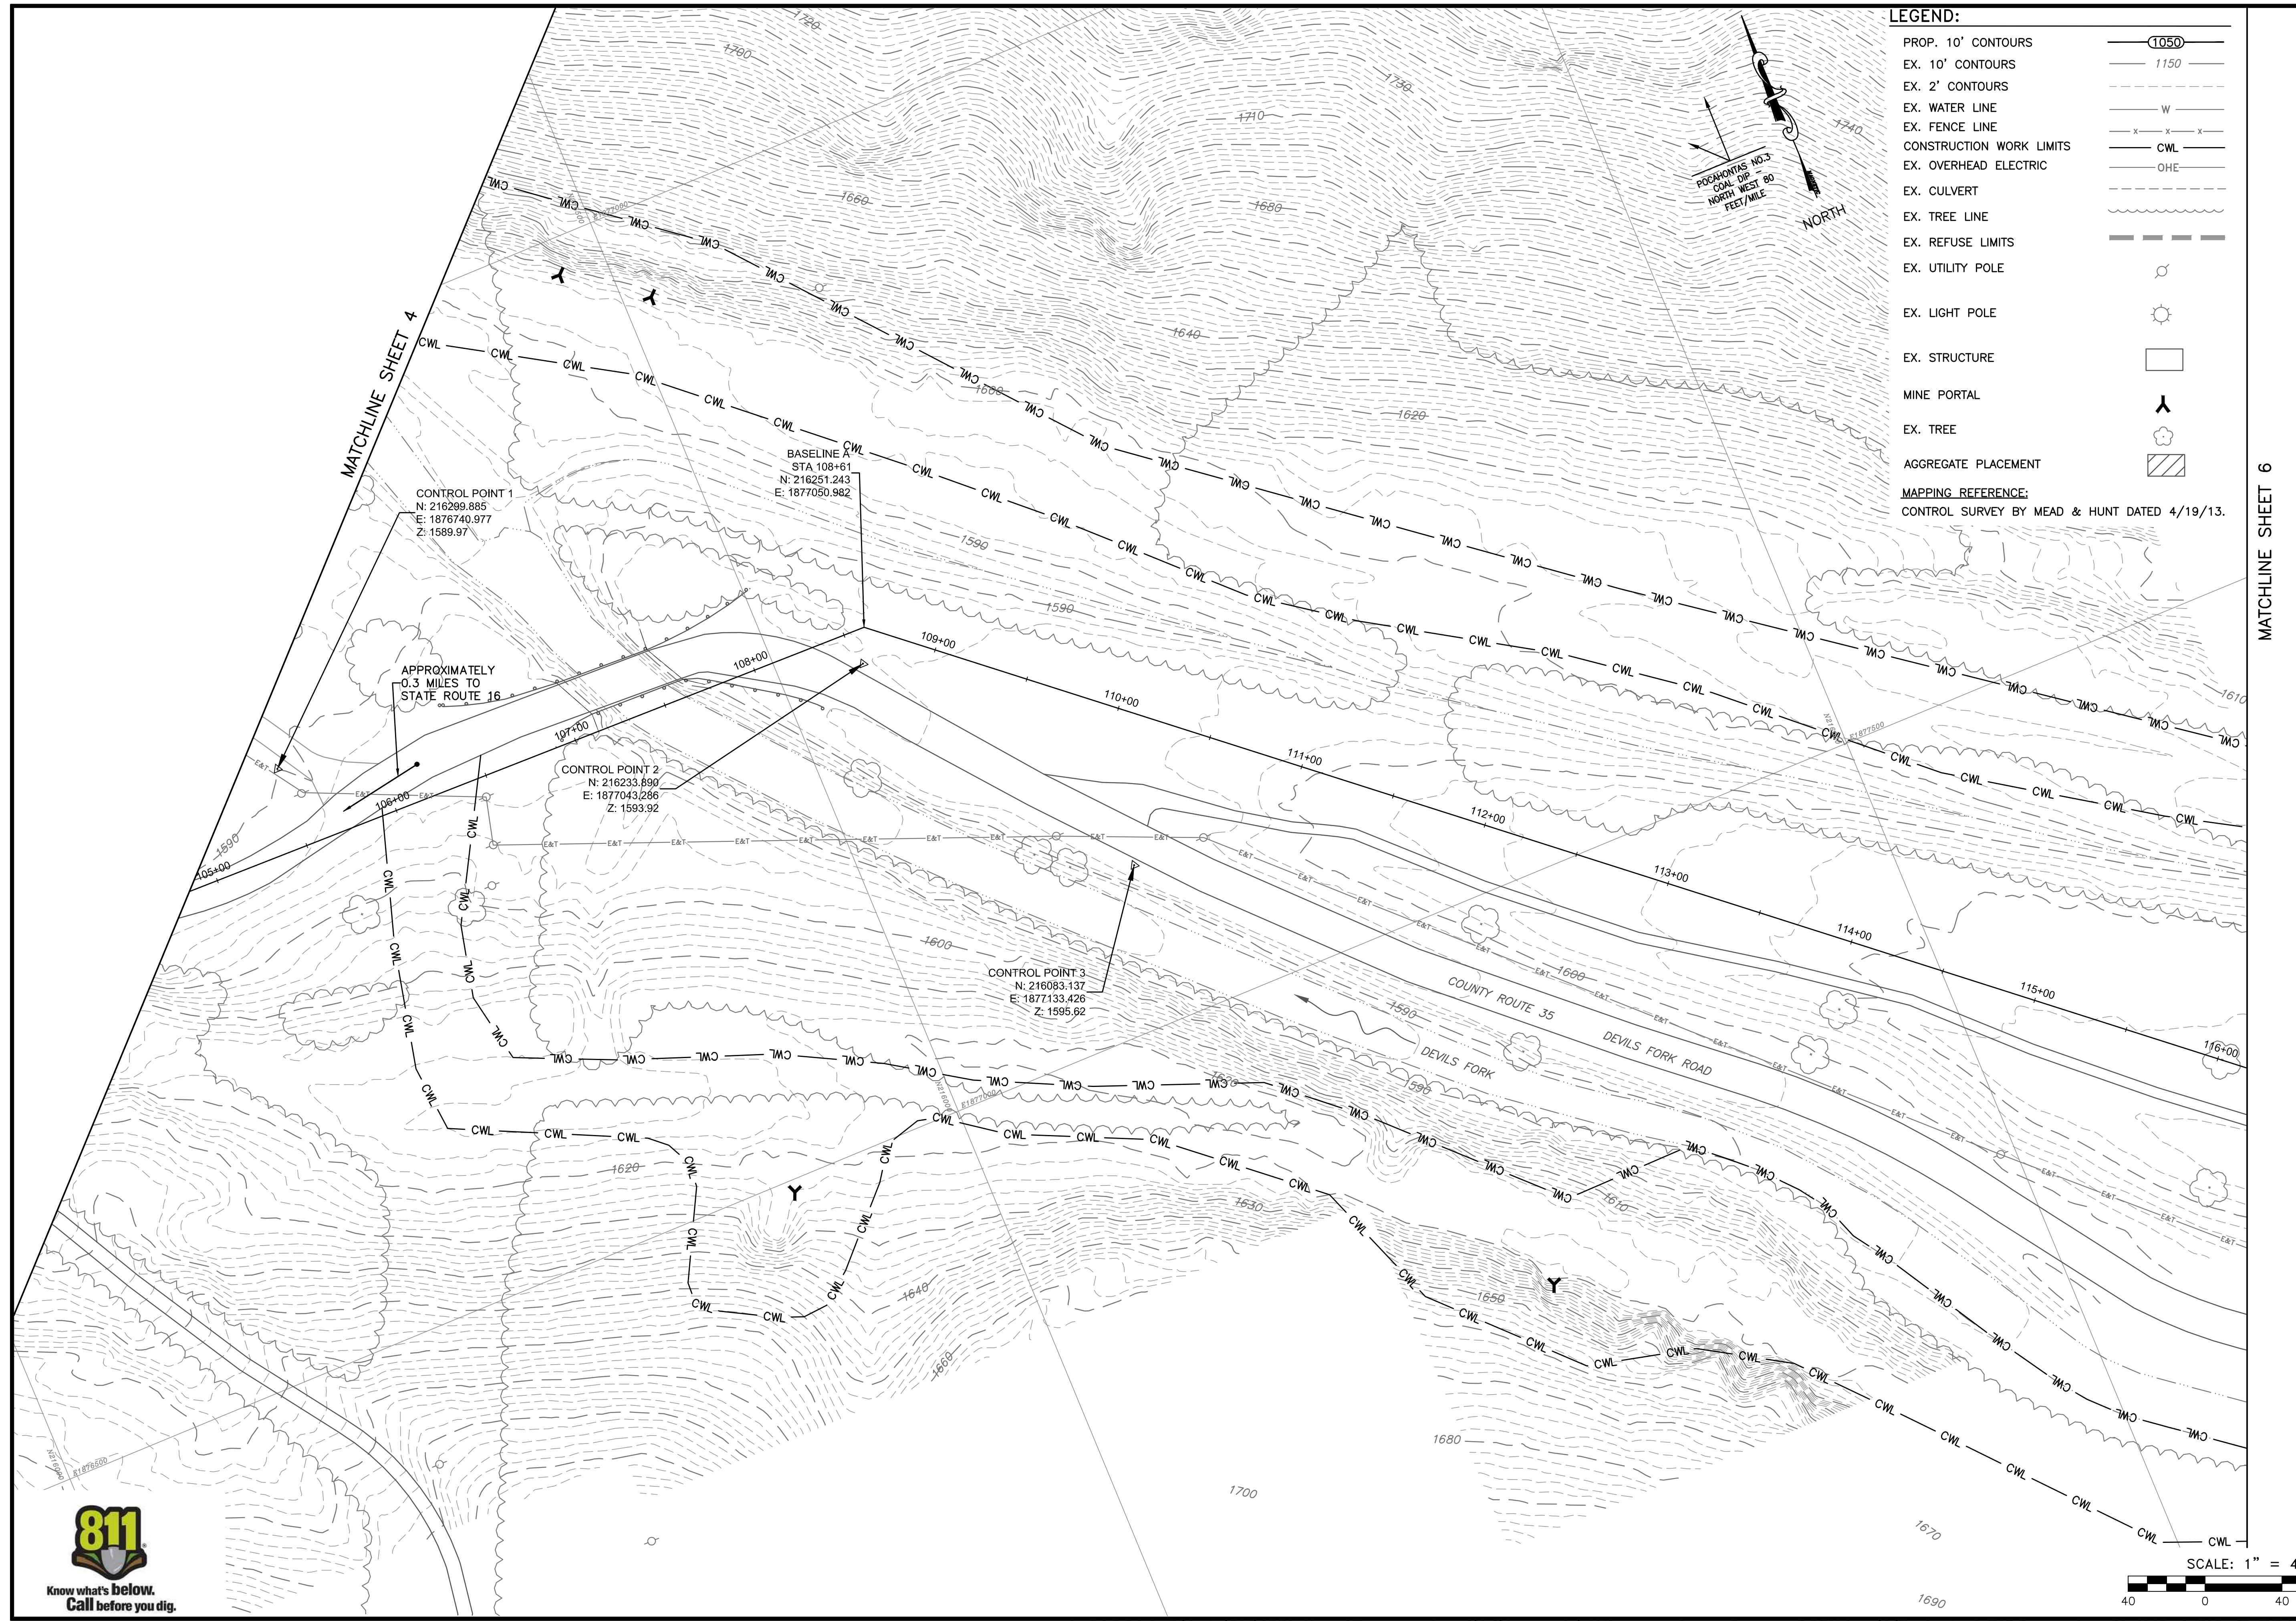

**Know what's below.
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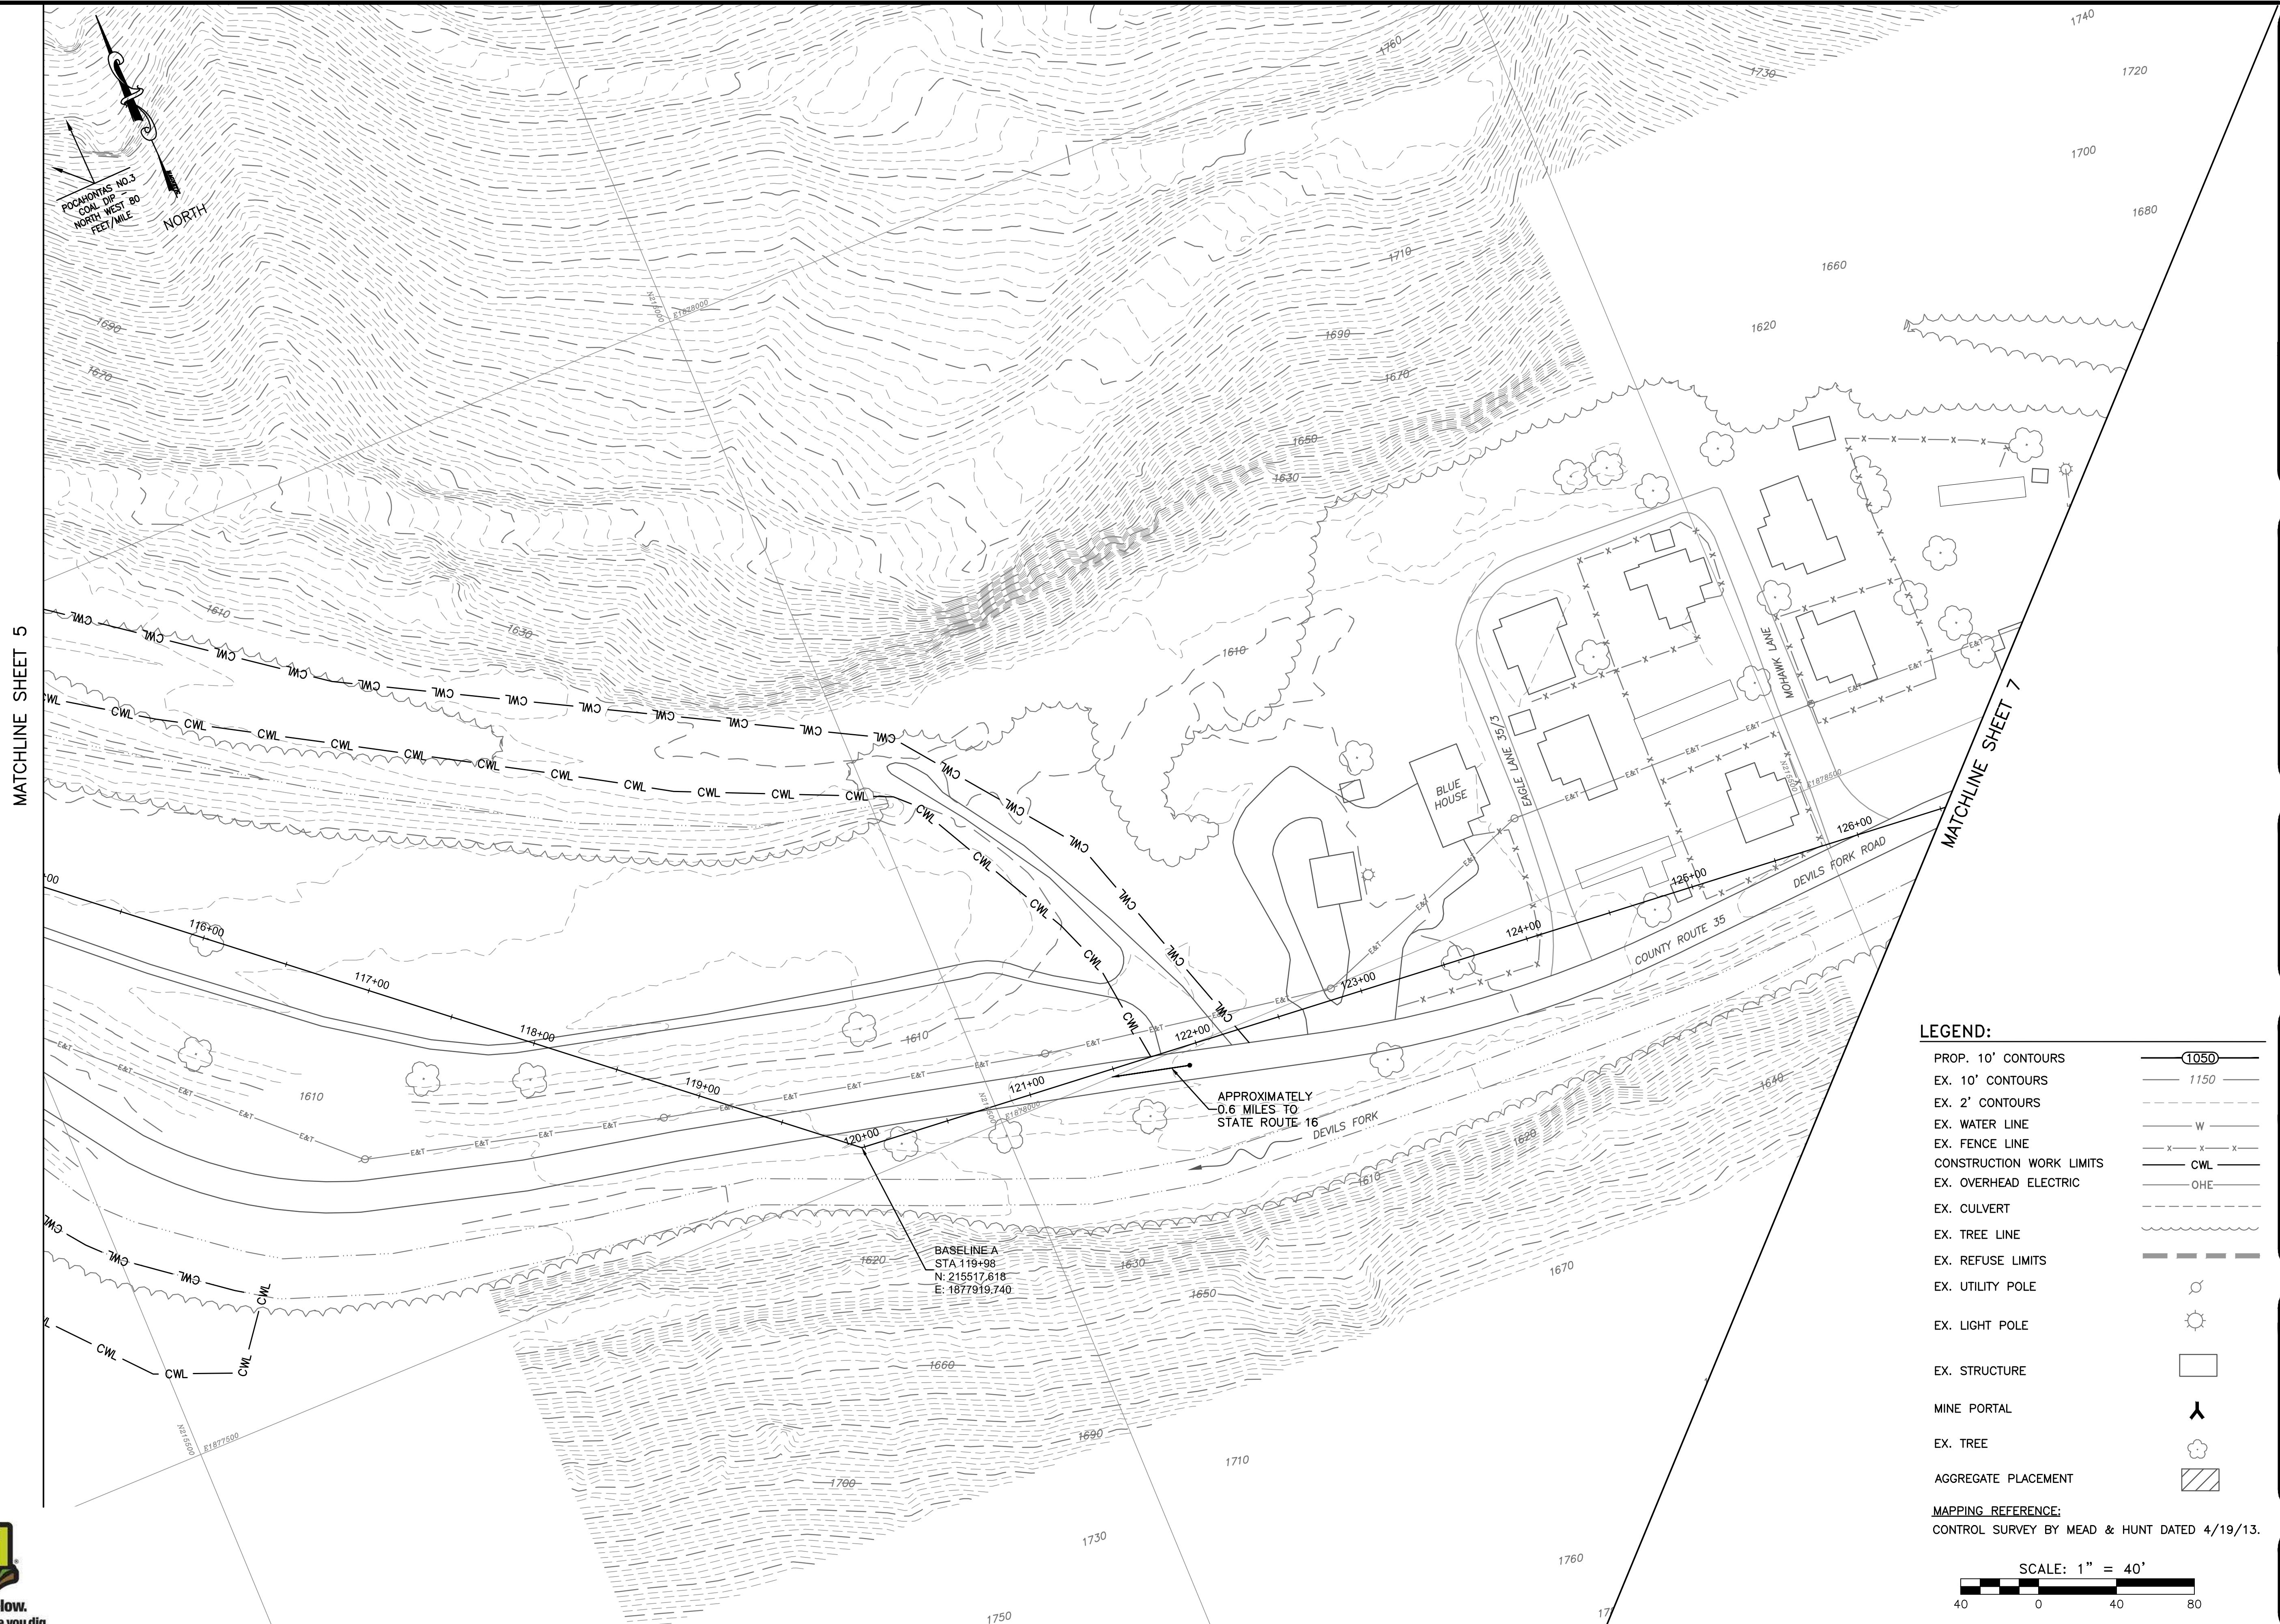
AMIGO PORTALS

RALEIGH COUNTY, WV

EXISTING

REV NO.	DATE	DESCRIPTION
---------	------	-------------

SC
1 " =



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P: 304 . 926 . 8100 F: 304 . 926 . 8

AMIGO PORTALS RALEIGH COUNTY, WV

RALEIGH COUNTY, WV

PLOT SCALE:	1/1
DESIGNED BY:	TAC
DRAWN BY:	TAC
CHECKED BY:	JTG
APPROVED BY:	CFS
DATE:	January 14, 2014
PROJECT NUMBER:	E130389

APPROVED BY: CRS
DATE: January 14, 2014
PROJECT NUMBER: E130389


EXISTING CONDITIONS

SOMMARIO

REV NO.	DATE	DESCRIPTION
---------	------	-------------

SCALE
1" = 40'
DRAWING NUMBER
6

40'
NUMBER

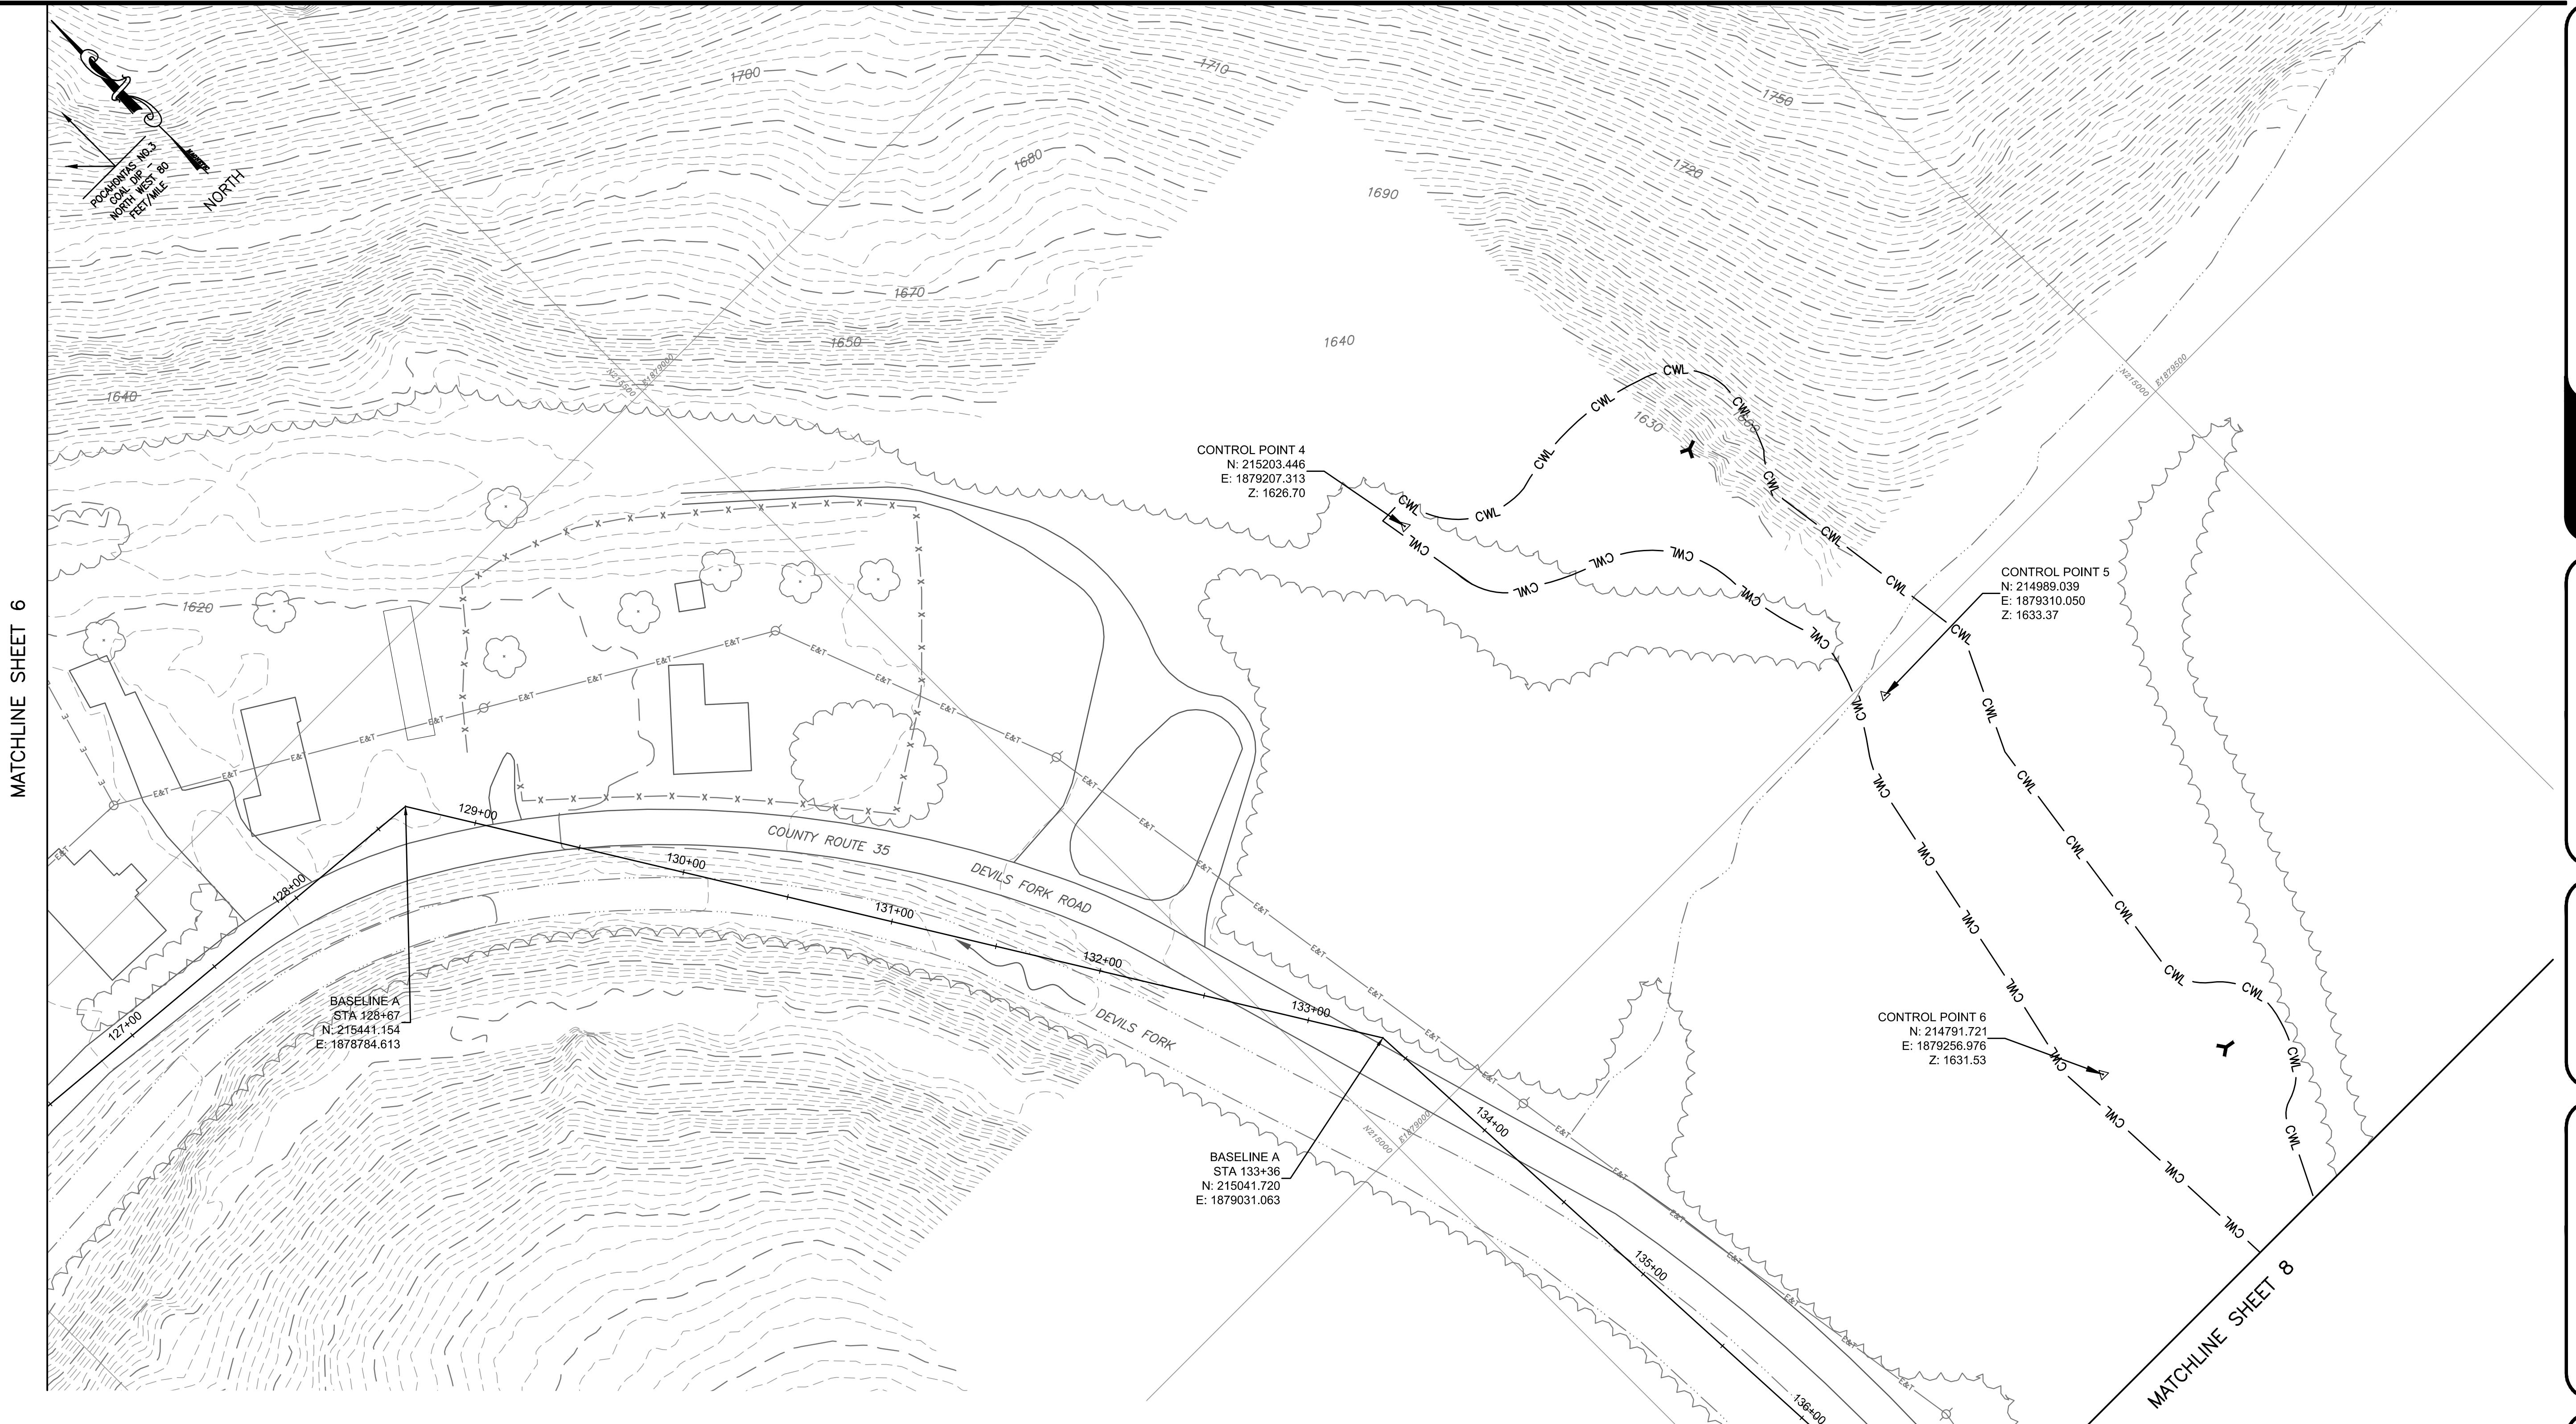

**Know what's below.
Call before you dig.**

LEGEND:

PROP. 10' CONTOURS	 1050	EX. UTILITY POLE	
EX. 10' CONTOURS	 1150		
EX. 2' CONTOURS		EX. LIGHT POLE	
EX. WATER LINE	 W		
EX. FENCE LINE	 X X X	EX. STRUCTURE	
CONSTRUCTION WORK LIMITS	 CWL		
EX. OVERHEAD ELECTRIC	 OHE	MINE PORTAL	
EX. CULVERT		EX. TREE	
EX. TREE LINE			
EX. REFUSE LIMITS		AGGREGATE PLACEMENT	

MAPPING REFERENCE:
CONTROL SURVEY BY MEAD & HUNT DATED 4/19,

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300 SUMMERS STREET, SUITE 1100
CHARLESTON, WEST VIRGINIA 25301
P: 304 . 926 . 8100 F: 304 . 926 . 8

AMIGO PORTALS

RALEIGH COUNTY, WV

1/
TAC
TA
NOT SCALE:
SIGNED BY:
AWN BY:

CHECKED BY: JI
APPROVED BY: CF
DATE: January 14, 2014
PROJECT NUMBER: E13038

EVICTING

CONDITIONS

REVISED

REV NO. D


1 "

CALE
= 40'
NUMBER

SCALE: 1" = 40'

0 40

A scale bar with black and white segments. Below it is a horizontal line with numerical markings at 0 and 40.

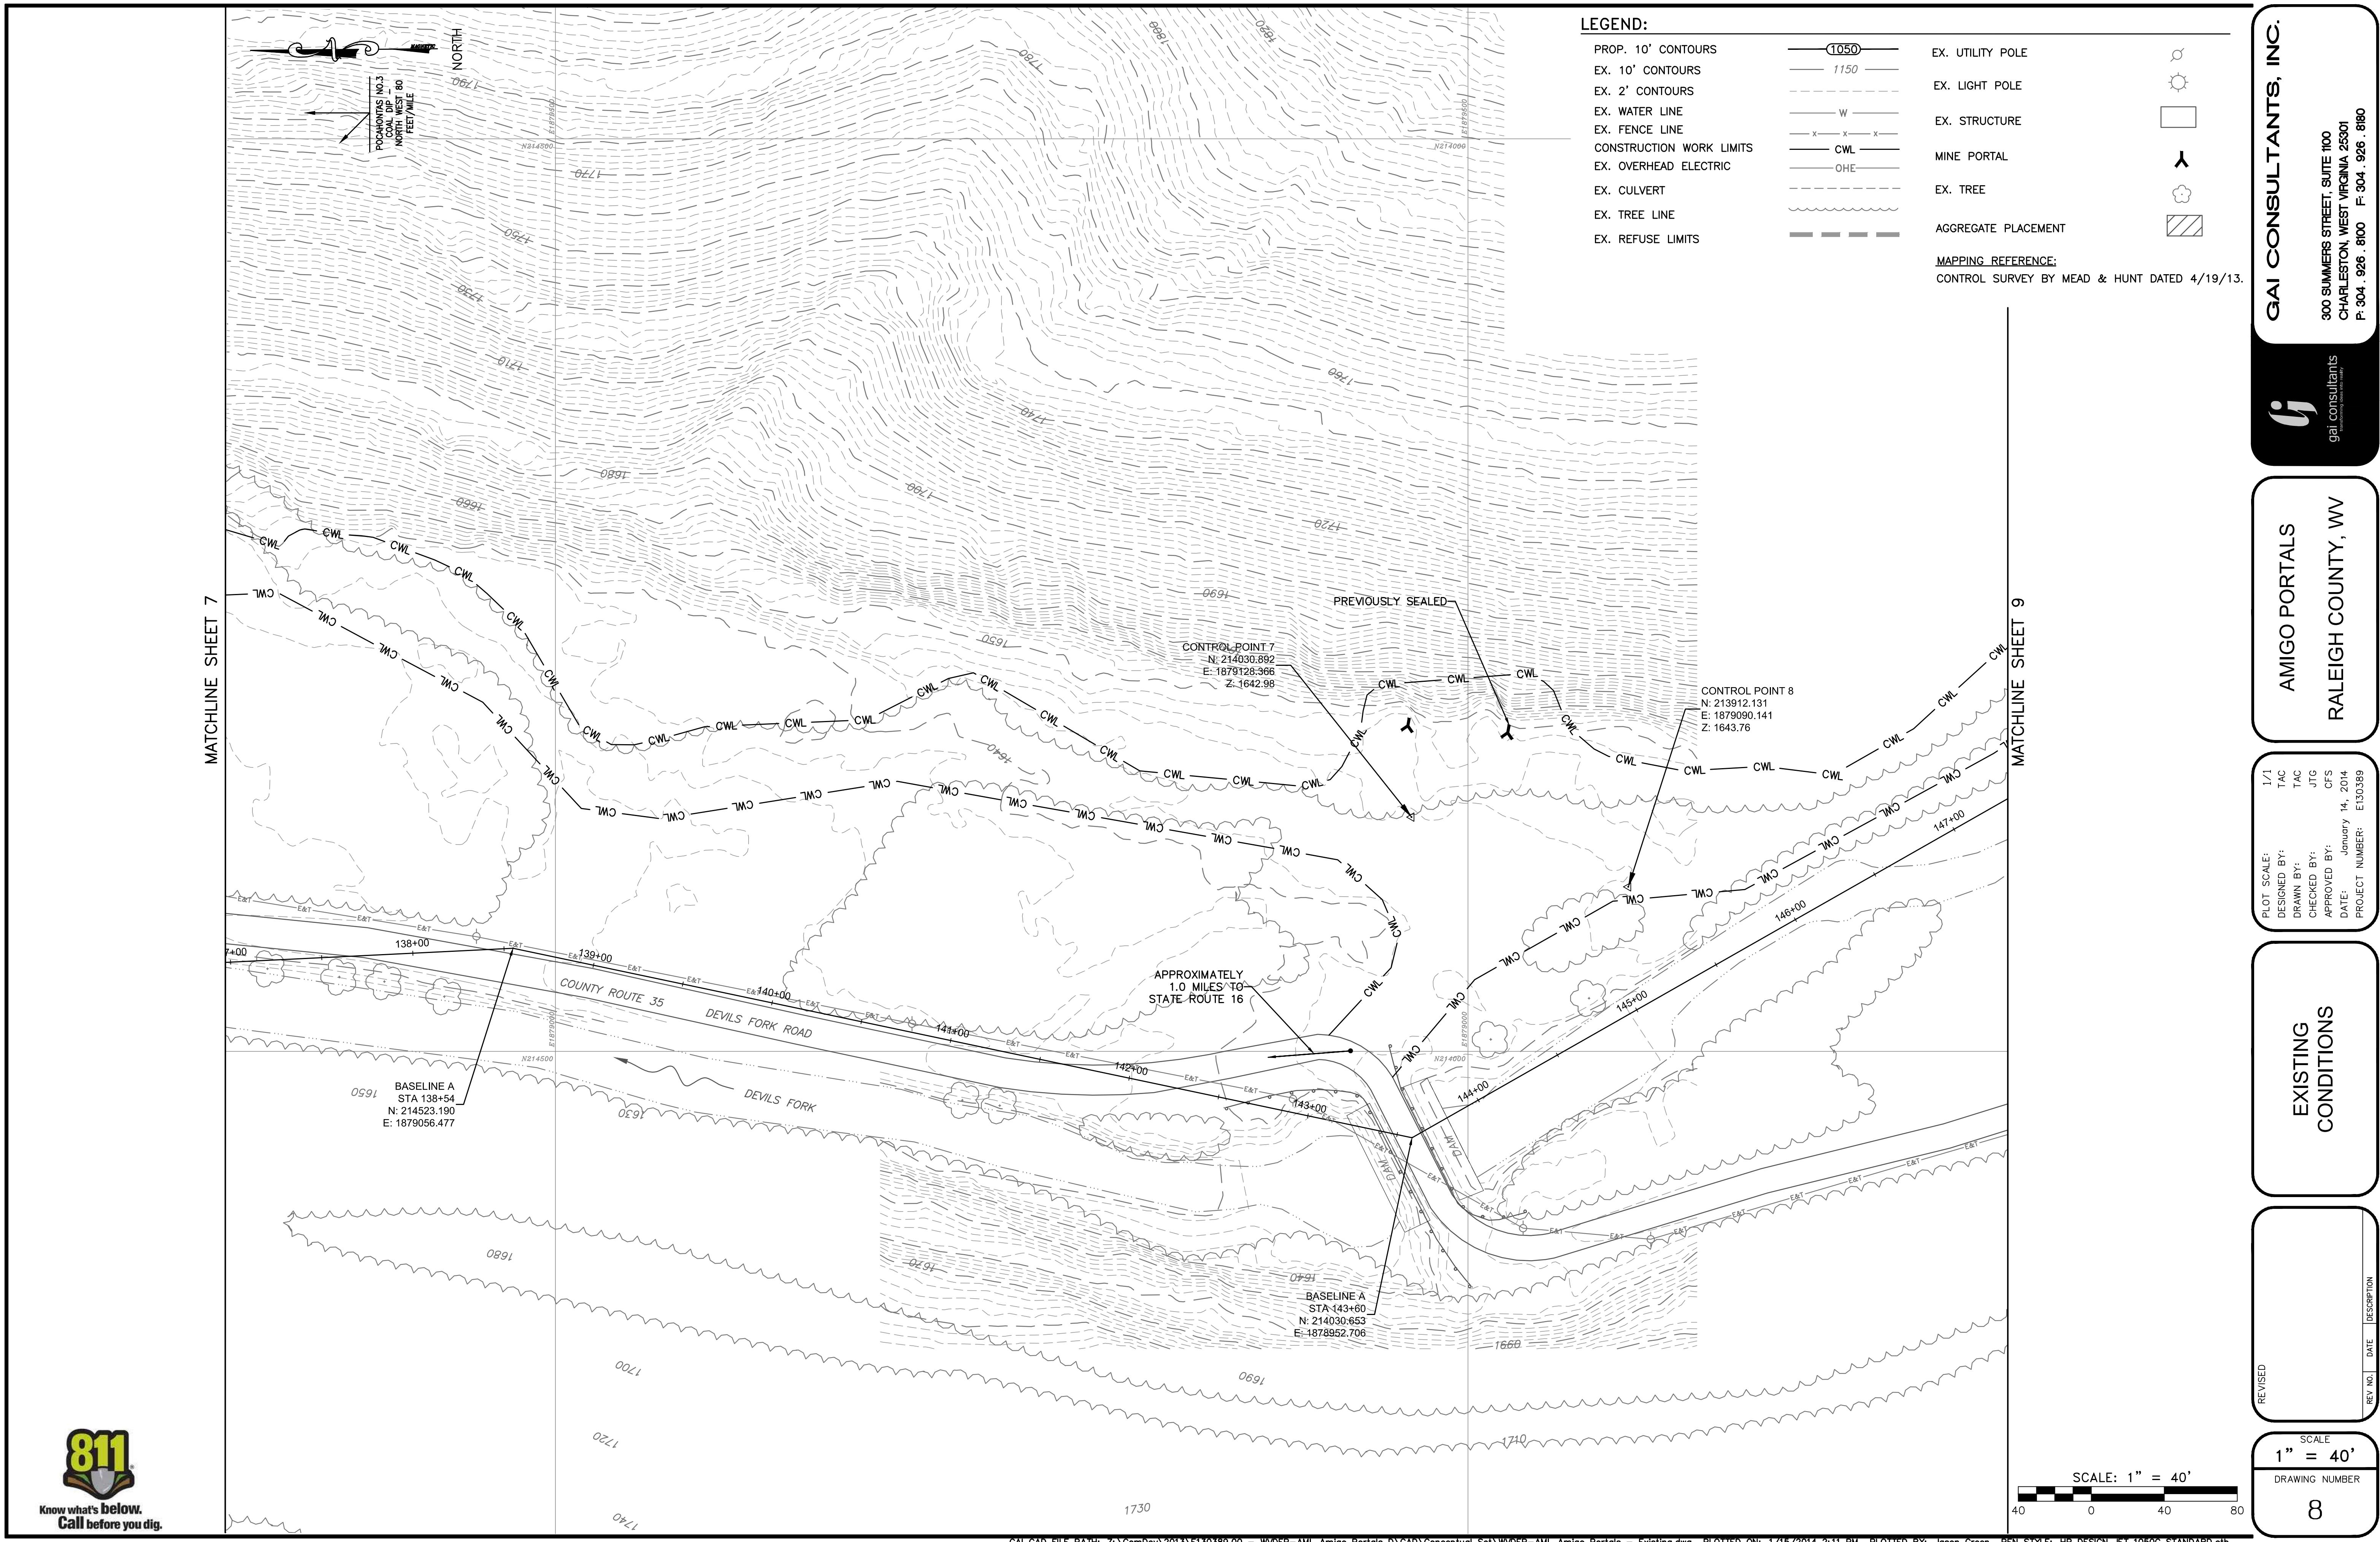

AMIGO PORTALS
RALEIGH COUNTY, WV

PLOT SCALE:
DRAWN BY:
CHECKED BY:
APPROVED BY:
DATE: January 14, 2014
PROJECT NUMBER: E130389


EXISTING CONDITIONS

REVISED
REV. NO.: DATE

SCALE
1" = 40'
DRAWING NUMBER
9

MATCHLINE SHEET 8

MATCHLINE SHEET 10

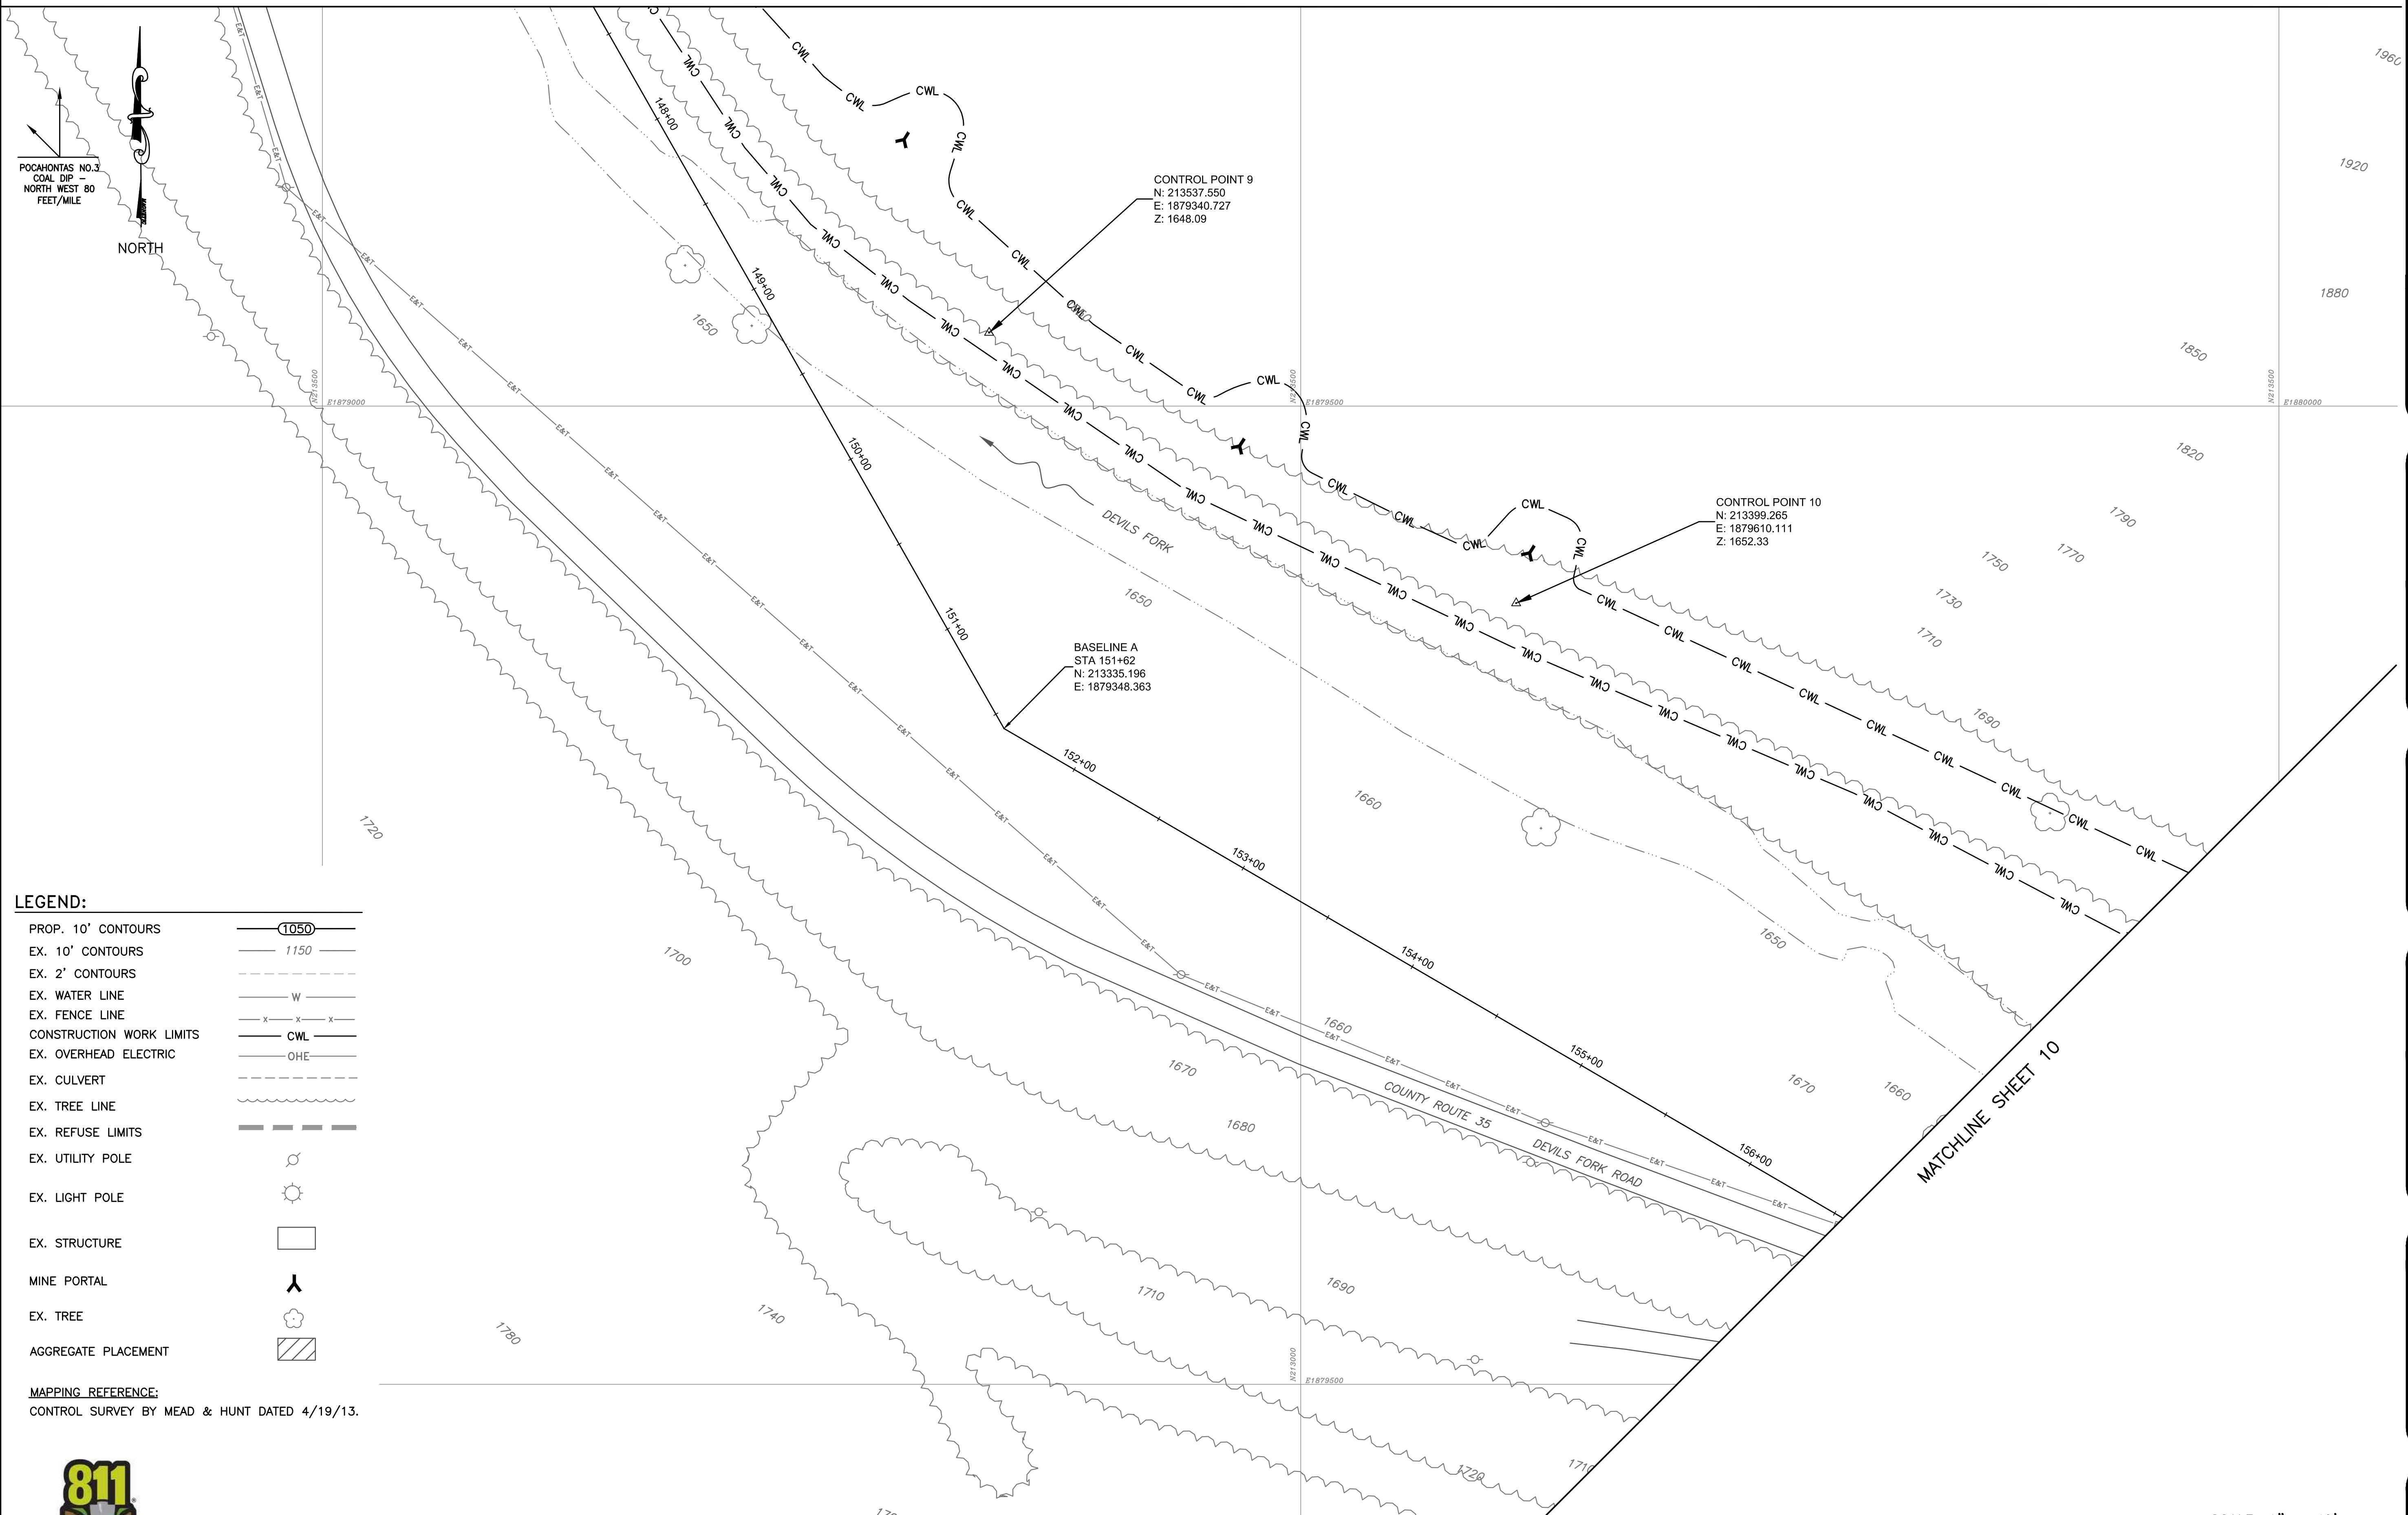



LEGEND:

PROP. 10' CONTOURS	(1050)
EX. 10' CONTOURS	1150
EX. 2' CONTOURS	
EX. WATER LINE	W
EX. FENCE LINE	X-X-X
CONSTRUCTION WORK LIMITS	CWL
EX. OVERHEAD ELECTRIC	OHE
EX. CULVERT	
EX. TREE LINE	
EX. REFUSE LIMITS	
EX. UTILITY POLE	
EX. LIGHT POLE	
EX. STRUCTURE	
MINE PORTAL	Y
EX. TREE	Cloud icon
AGGREGATE PLACEMENT	Diagonal hatching

MAPPING REFERENCE:
CONTROL SURVEY BY MEAD & HUNT DATED 4/19/13.



SCALE: 1" = 40'
DRAWING NUMBER
9

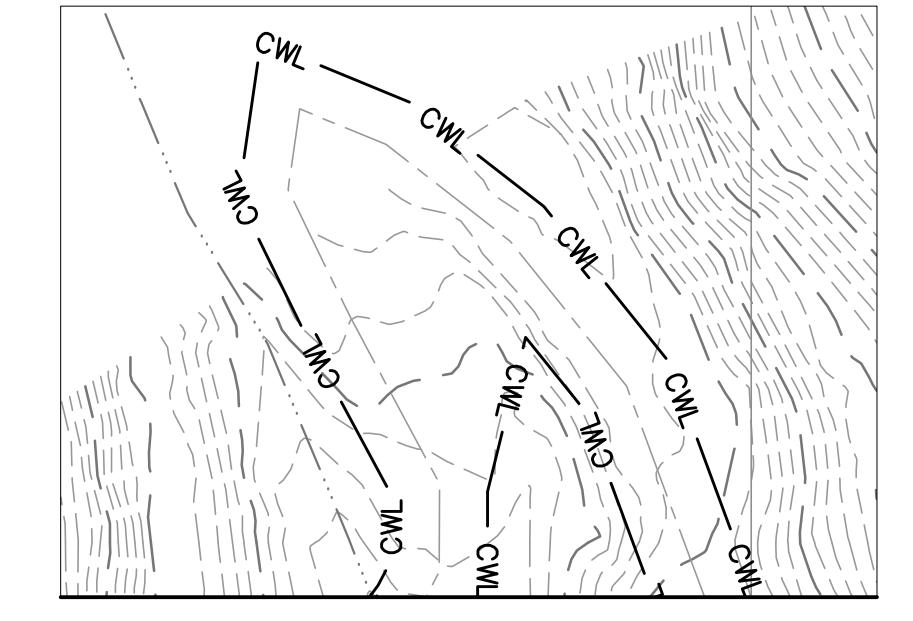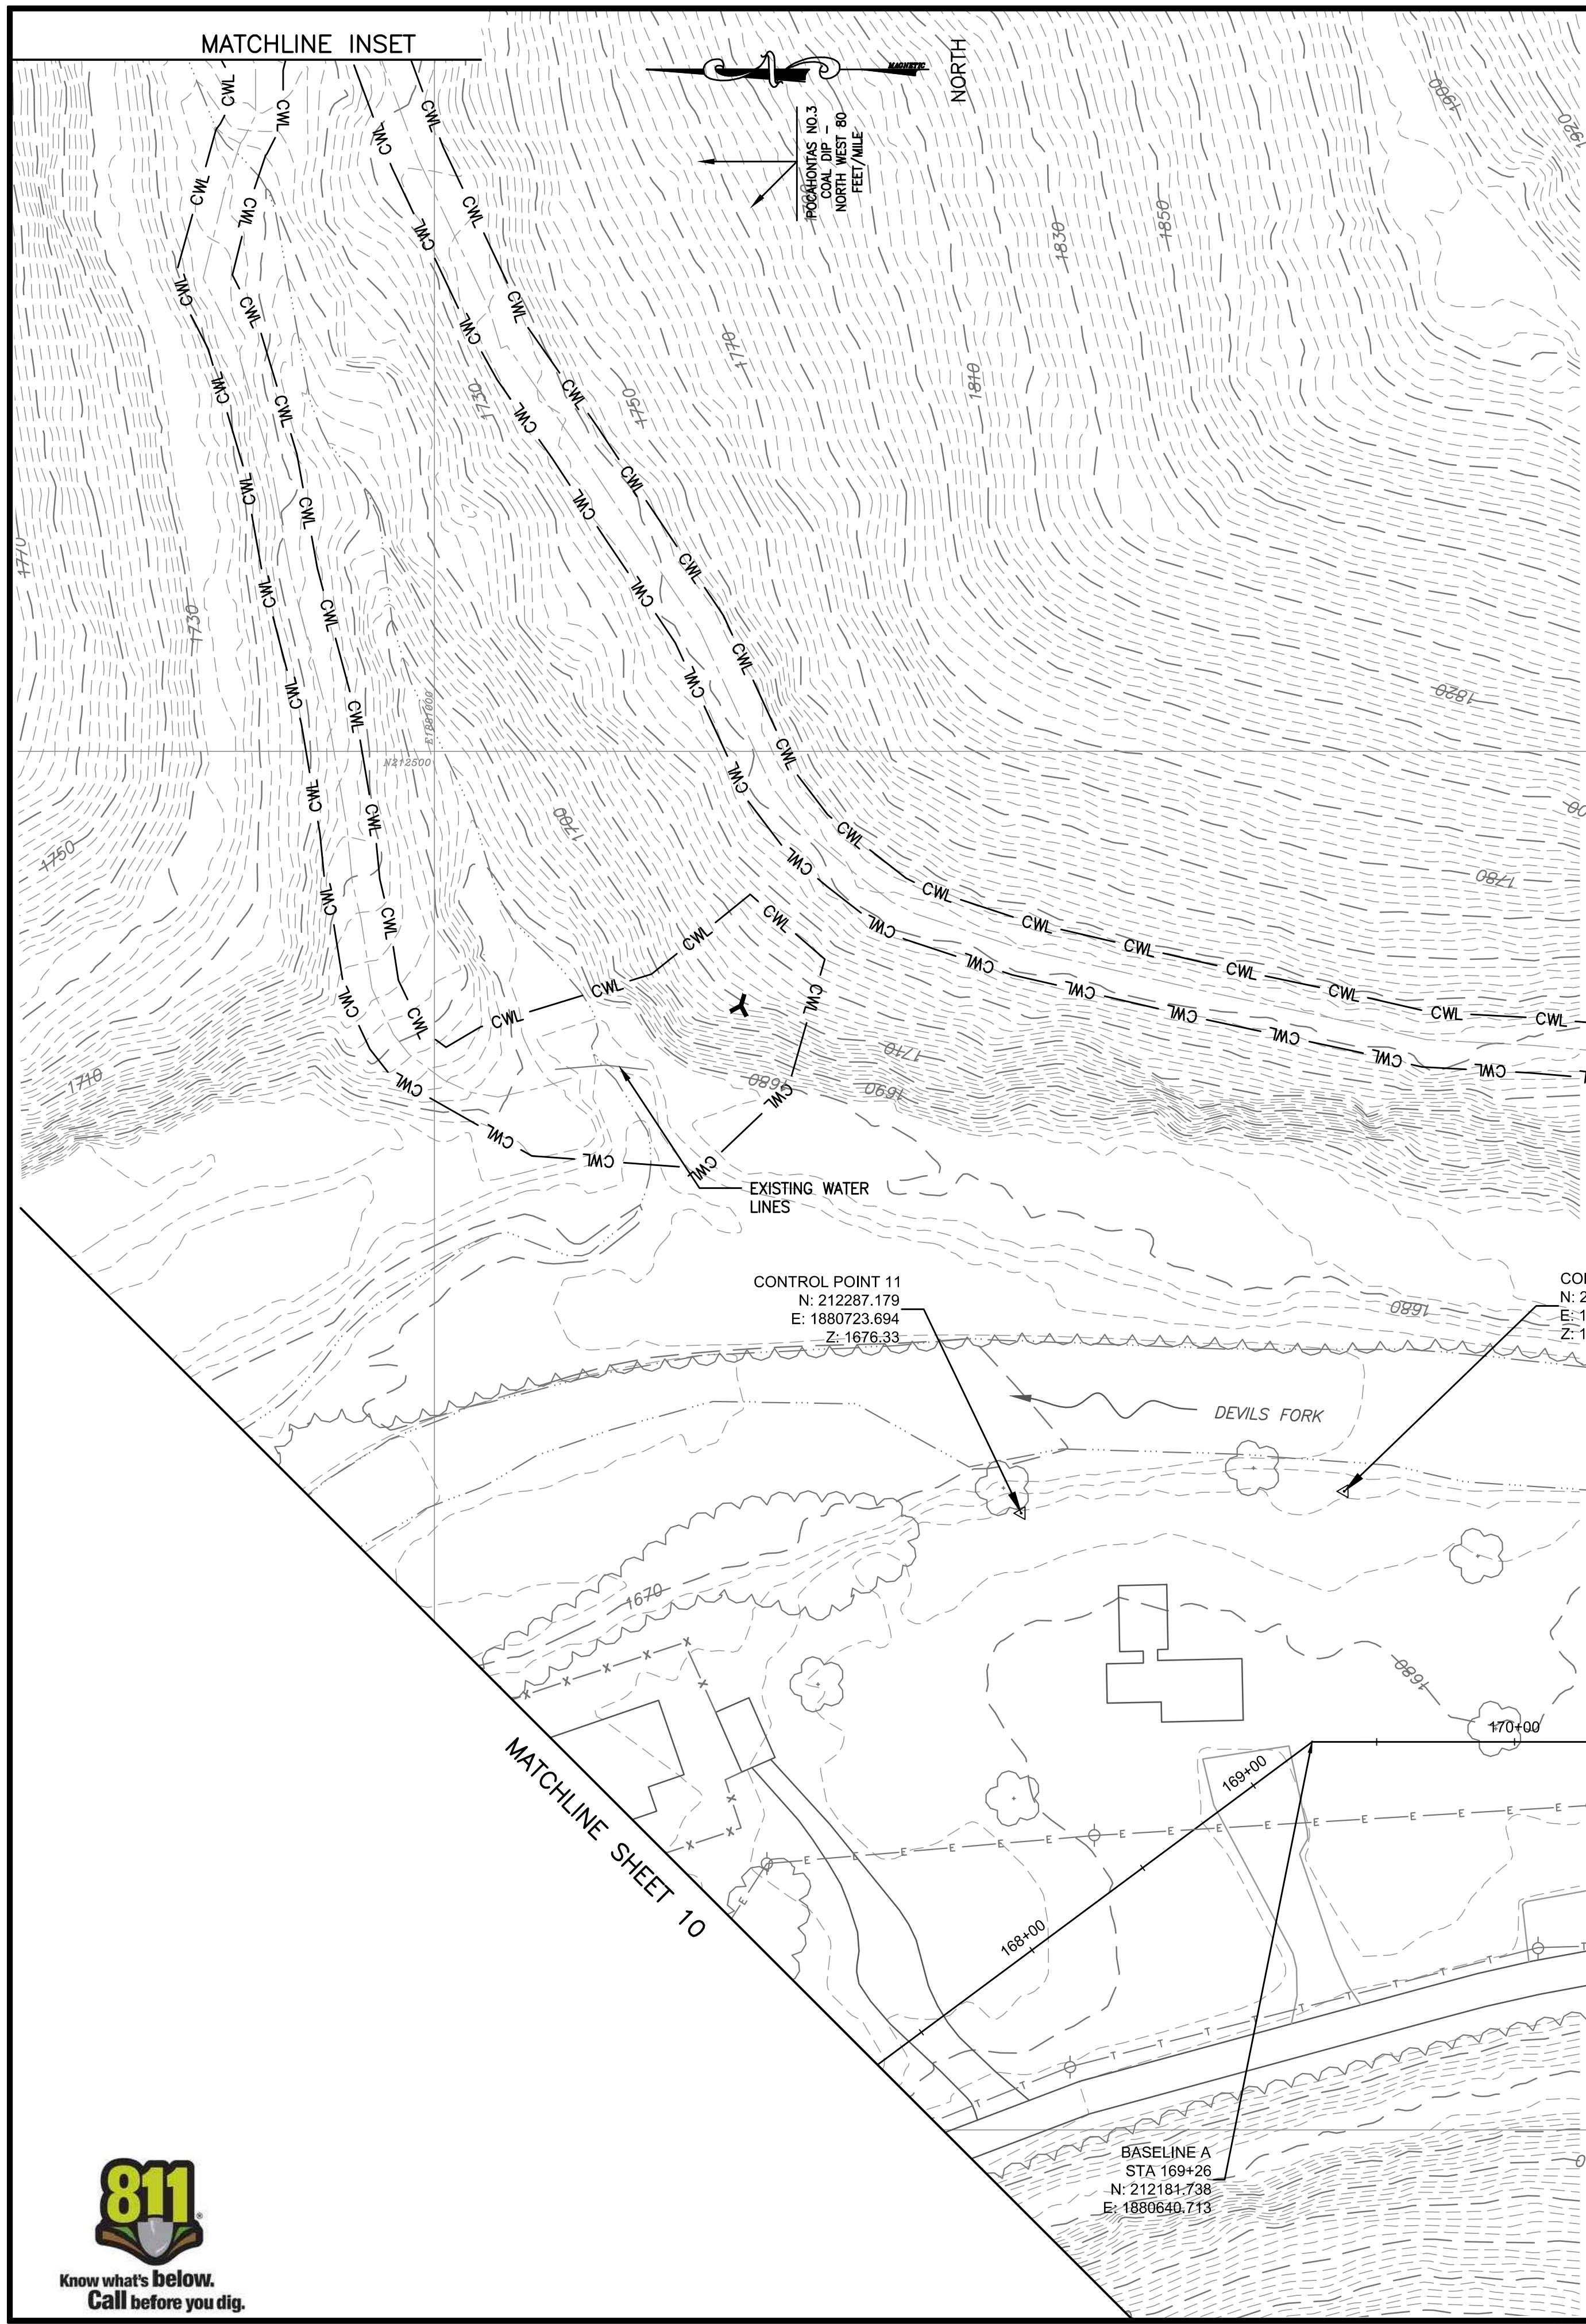

LEGEND:

- PROP. 10' CONTOURS
- EX. 10' CONTOURS
- EX. 2' CONTOURS
- EX. WATER LINE
- EX. FENCE LINE
- CONSTRUCTION WORK LIMITS
- EX. OVERHEAD ELECTRIC
- EX. CULVERT
- EX. TREE LINE
- EX. REFUSE LIMITS
- EX. UTILITY POLE
- EX. LIGHT POLE
- EX. STRUCTURE
- MINE PORTAL
- EX. TREE
- AGGREGATE PLACEMENT

MAPPING REFERENCE:
CONTROL SURVEY BY MEAD & HUNT DATED 4/19/13.



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AMIGO PORTALS

RALEIGH COUNTY, WV

PLOT SCALE:
DESIGNED BY:
DRAWN BY:
CHECKED BY:
APPROVED BY:
DATE: January 14, 2014
PROJECT NUMBER: E130389

EXISTING CONDITIONS

REV'D DATE DESCRIPTION

SCALE
1" = 40'
DRAWING NUMBER
12

BASELINE A
STA 187+00
N: 211002.597
E: 1881399.429

CONTROL POINT 14
N: 210811.291
E: 1881317.494
Z: 1713.33

LEGEND:

- PROP. 10' CONTOURS
- EX. 10' CONTOURS
- EX. 2' CONTOURS
- EX. WATER LINE
- EX. FENCE LINE
- CONSTRUCTION WORK LIMITS
- EX. OVERHEAD ELECTRIC
- EX. CULVERT
- EX. TREE LINE
- EX. REFUSE LIMITS
- EX. UTILITY POLE
- EX. LIGHT POLE
- EX. STRUCTURE
- MINE PORTAL
- EX. TREE
- AGGREGATE PLACEMENT

MAPPING REFERENCE:
CONTROL SURVEY BY MEAD & HUNT DATED 4/19/13.

SCALE: 1" = 40'
40 0 40 80

MATCHLINE SHEET 11

AMIGO PORTALS
RALEIGH COUNTY, WV

PLOT SCALE: 1/1
DESIGNED BY: TAC
DRAWN BY: TAC
CHECKED BY: JTG
APPROVED BY: CFS
DATE: January 14, 2014
PROJECT NUMBER: E130383

EROSION & SEDIMENTATION

REVISED

REV. NO. DATE DESCRIPTION


SCALE
1" = 40'
DRAWING NUMBER
13

MATCHLINE SHEET 14



SCALE: 1" = 40'
40 0 40 80



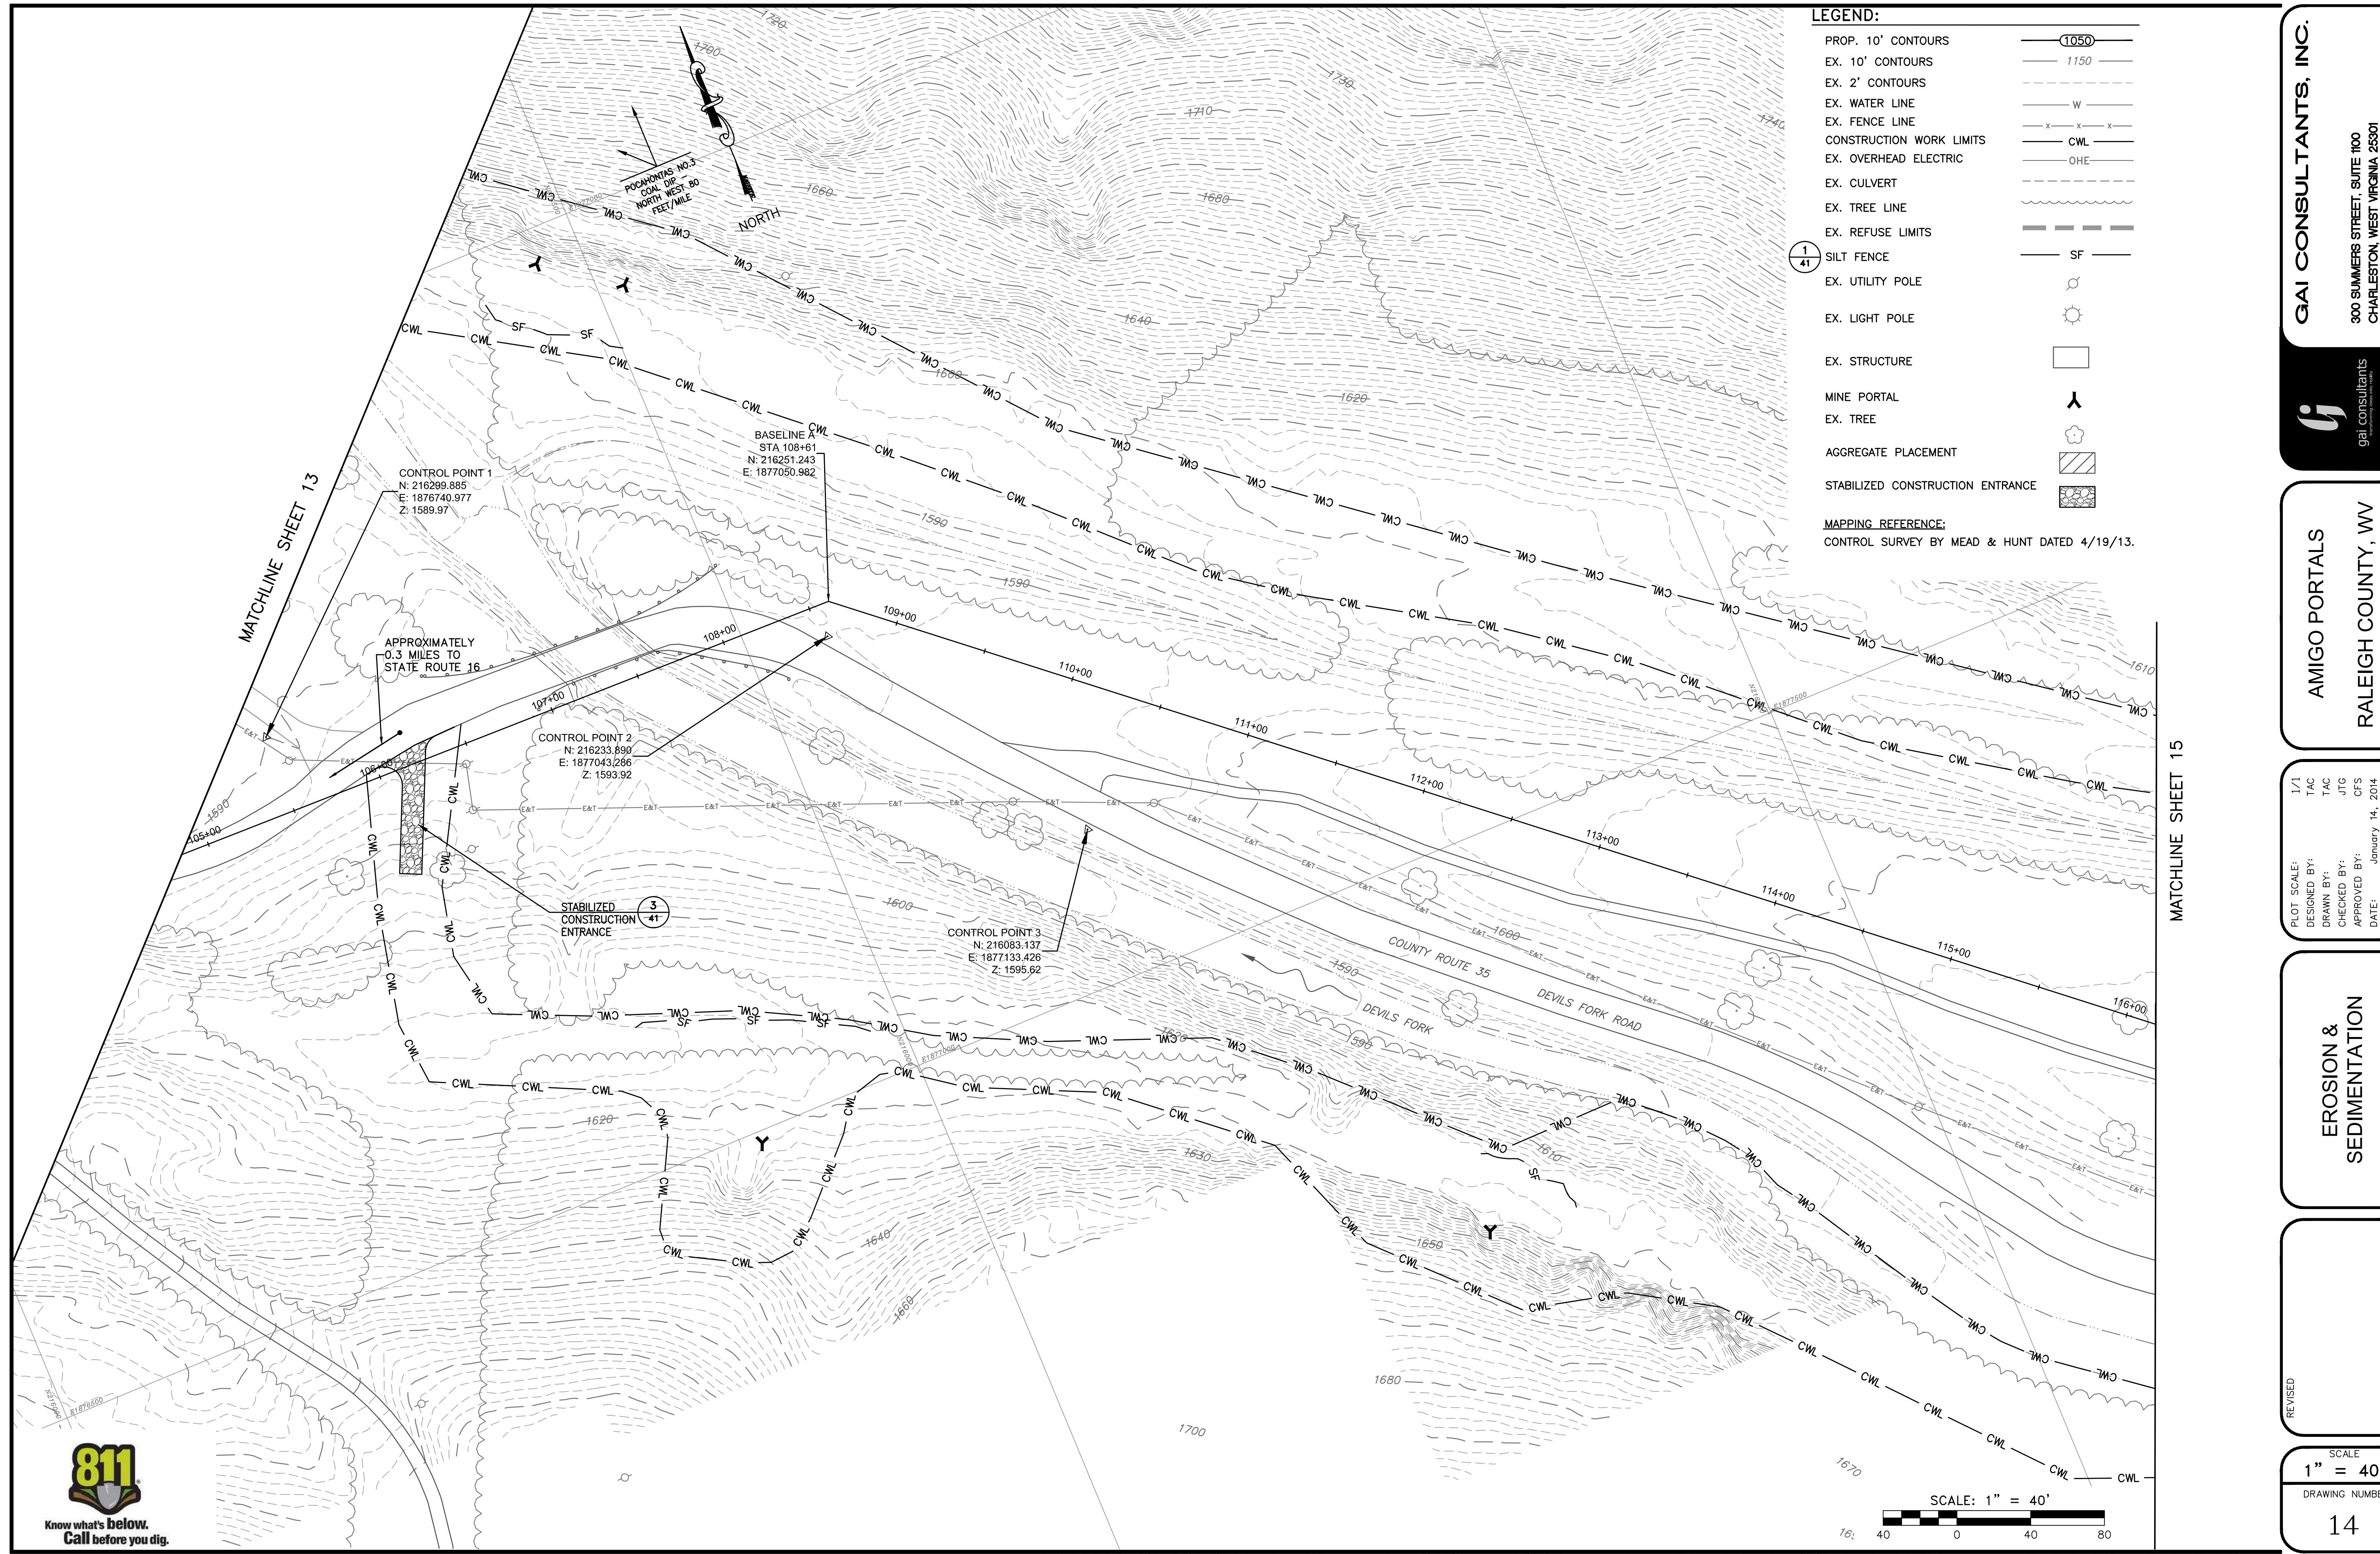

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CHARLESTON, WEST VIRGINIA 25301
P: 304 . 926 . 8100 F: 304 . 926 . 8101

AMIGO PORTALS

RALEIGH COUNTY, WV

EROSION & SEDIMENTATION

SEDIMENTATION

1

S

E

DRAWIN

40


1

1

-

1

100

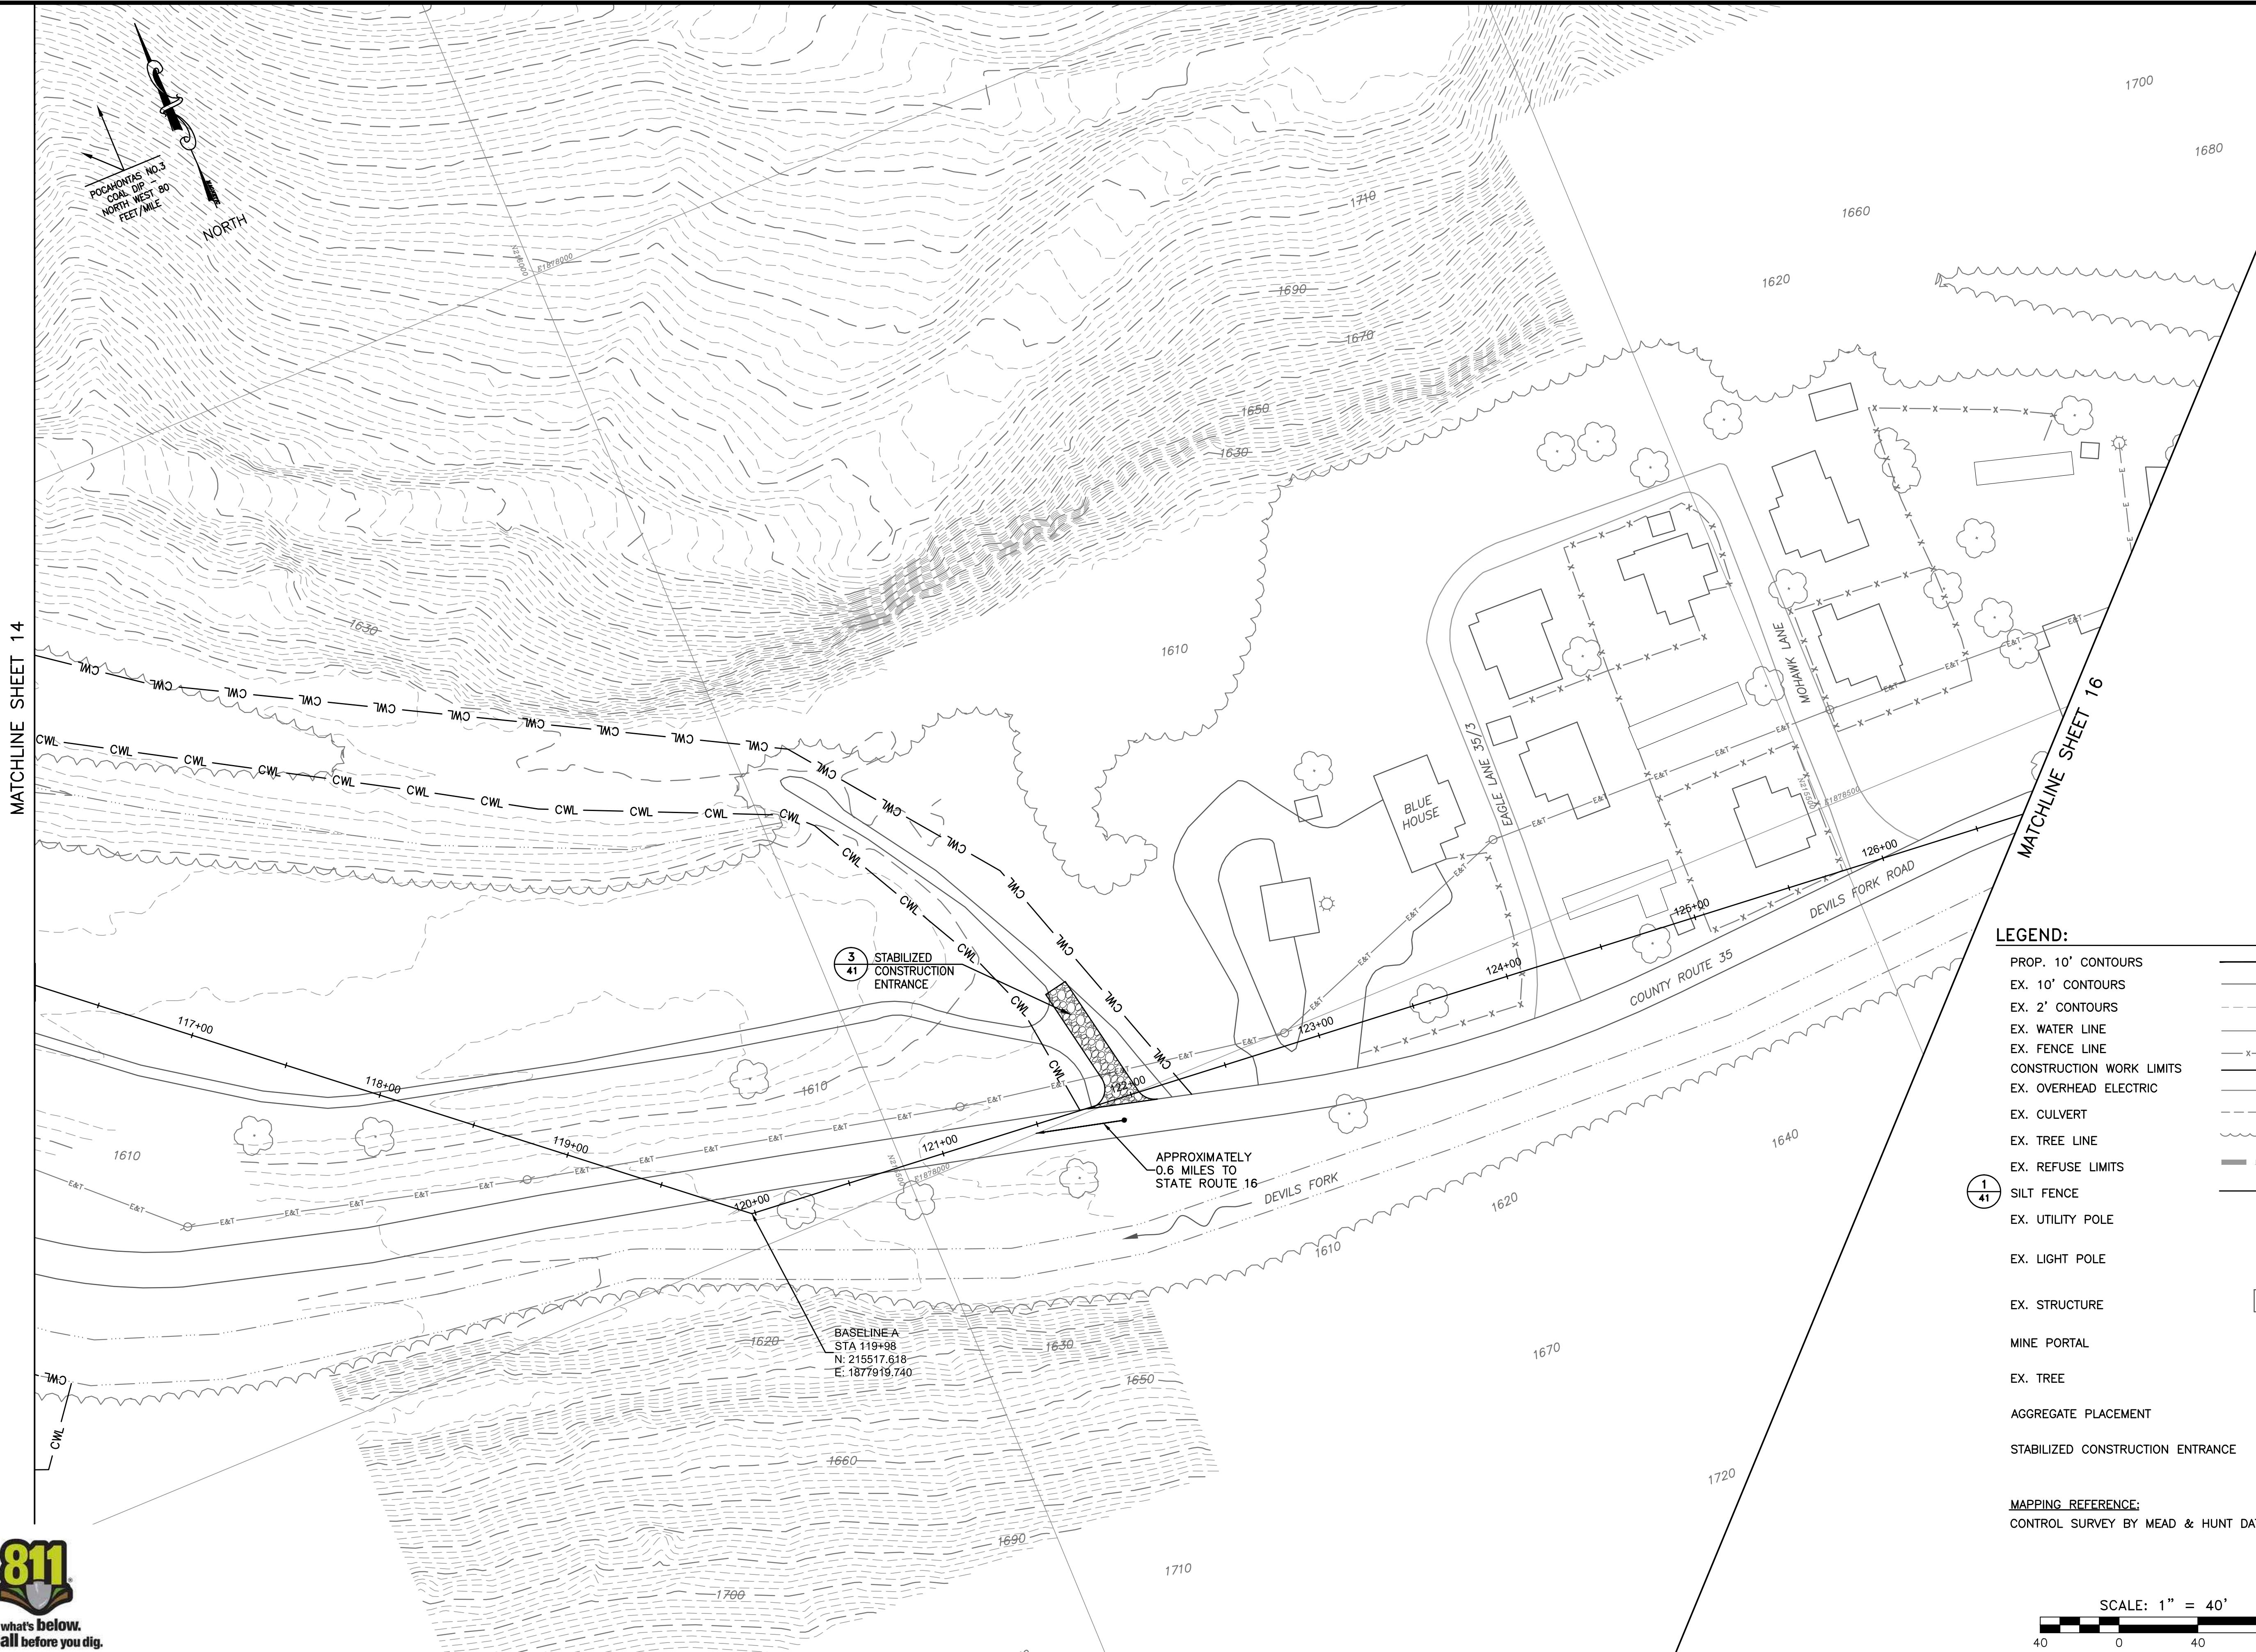

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Call before you dig.**

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CHARLESTON, WEST VIRGINIA 25301
P: 304 . 926 . 8100 F: 304 . 926 . 8180

AMIGO PORTALS

RALEIGH COUNTY, WV

EDUCTION 8

EROSION & SEDIMENTATION


REVISED

DEV NO. D

1 "
DRAW


SCALE
= 40'
ING NUMBER
15

MATCHLINE SHEET 15

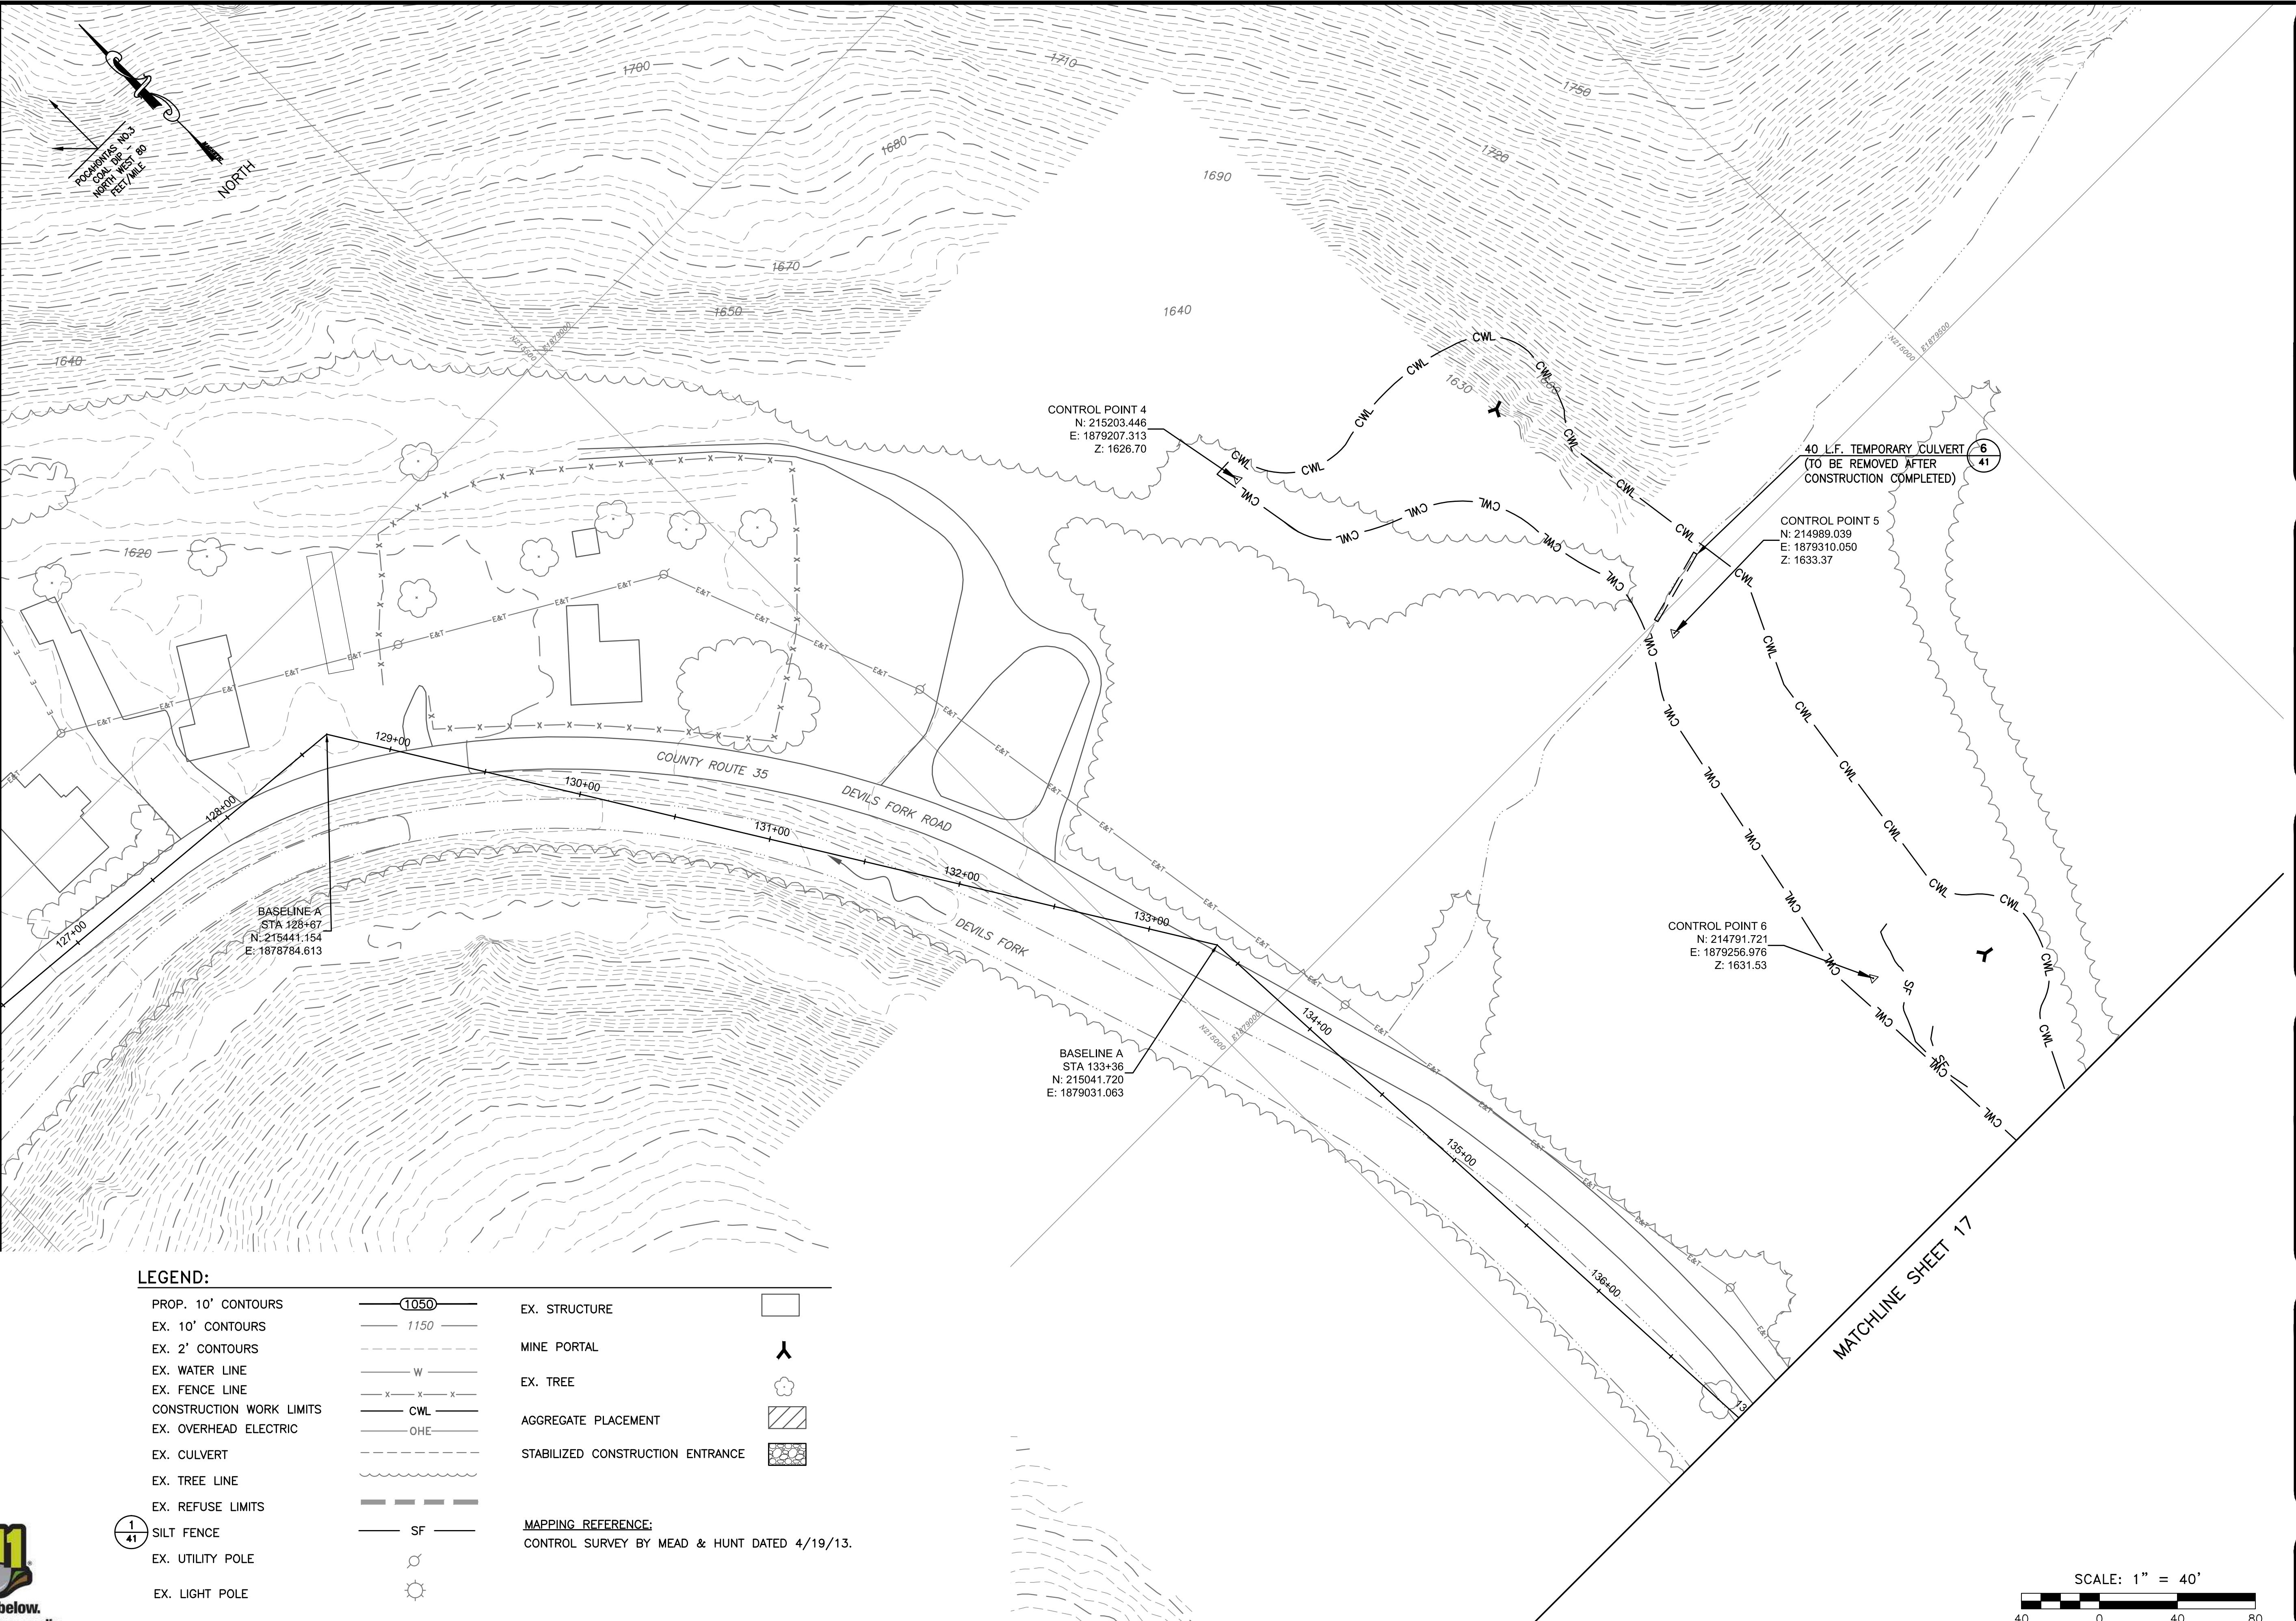


**Know what's below.
Call before you dig.**

LEGEND:

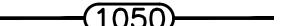- | | | |
|--------------------------|---|----------------------------------|
| PROP. 10' CONTOURS |  | |
| EX. 10' CONTOURS |  | |
| EX. 2' CONTOURS |  | MINE PORTAL |
| EX. WATER LINE |  | |
| EX. FENCE LINE |  | |
| CONSTRUCTION WORK LIMITS |  | |
| EX. OVERHEAD ELECTRIC |  | AGGREGATE PLACEMENT |
| EX. CULVERT |  | |
| EX. TREE LINE |  | STABILIZED CONSTRUCTION ENTRANCE |
| EX. REFUSE LIMITS |  | |
| SILT FENCE |  | |
| EX. UTILITY POLE |  | |
| EX. LIGHT POLE |  | |

MAPPING REFERENCE:

GAI CAD FILE PATH: Z:\ComDev\2013\E130389.00 - WVDEP-AML Amigo Portals D\CAD\Conceptual Set\WVDEP-AML Amigo Portals - E&S.dwg PLOTTED ON: 1/15/2014 2:12 PM PLOTTED BY: Jason Green PEN STYLE: HP DESIGN JET 1050C STANDARD.ctb

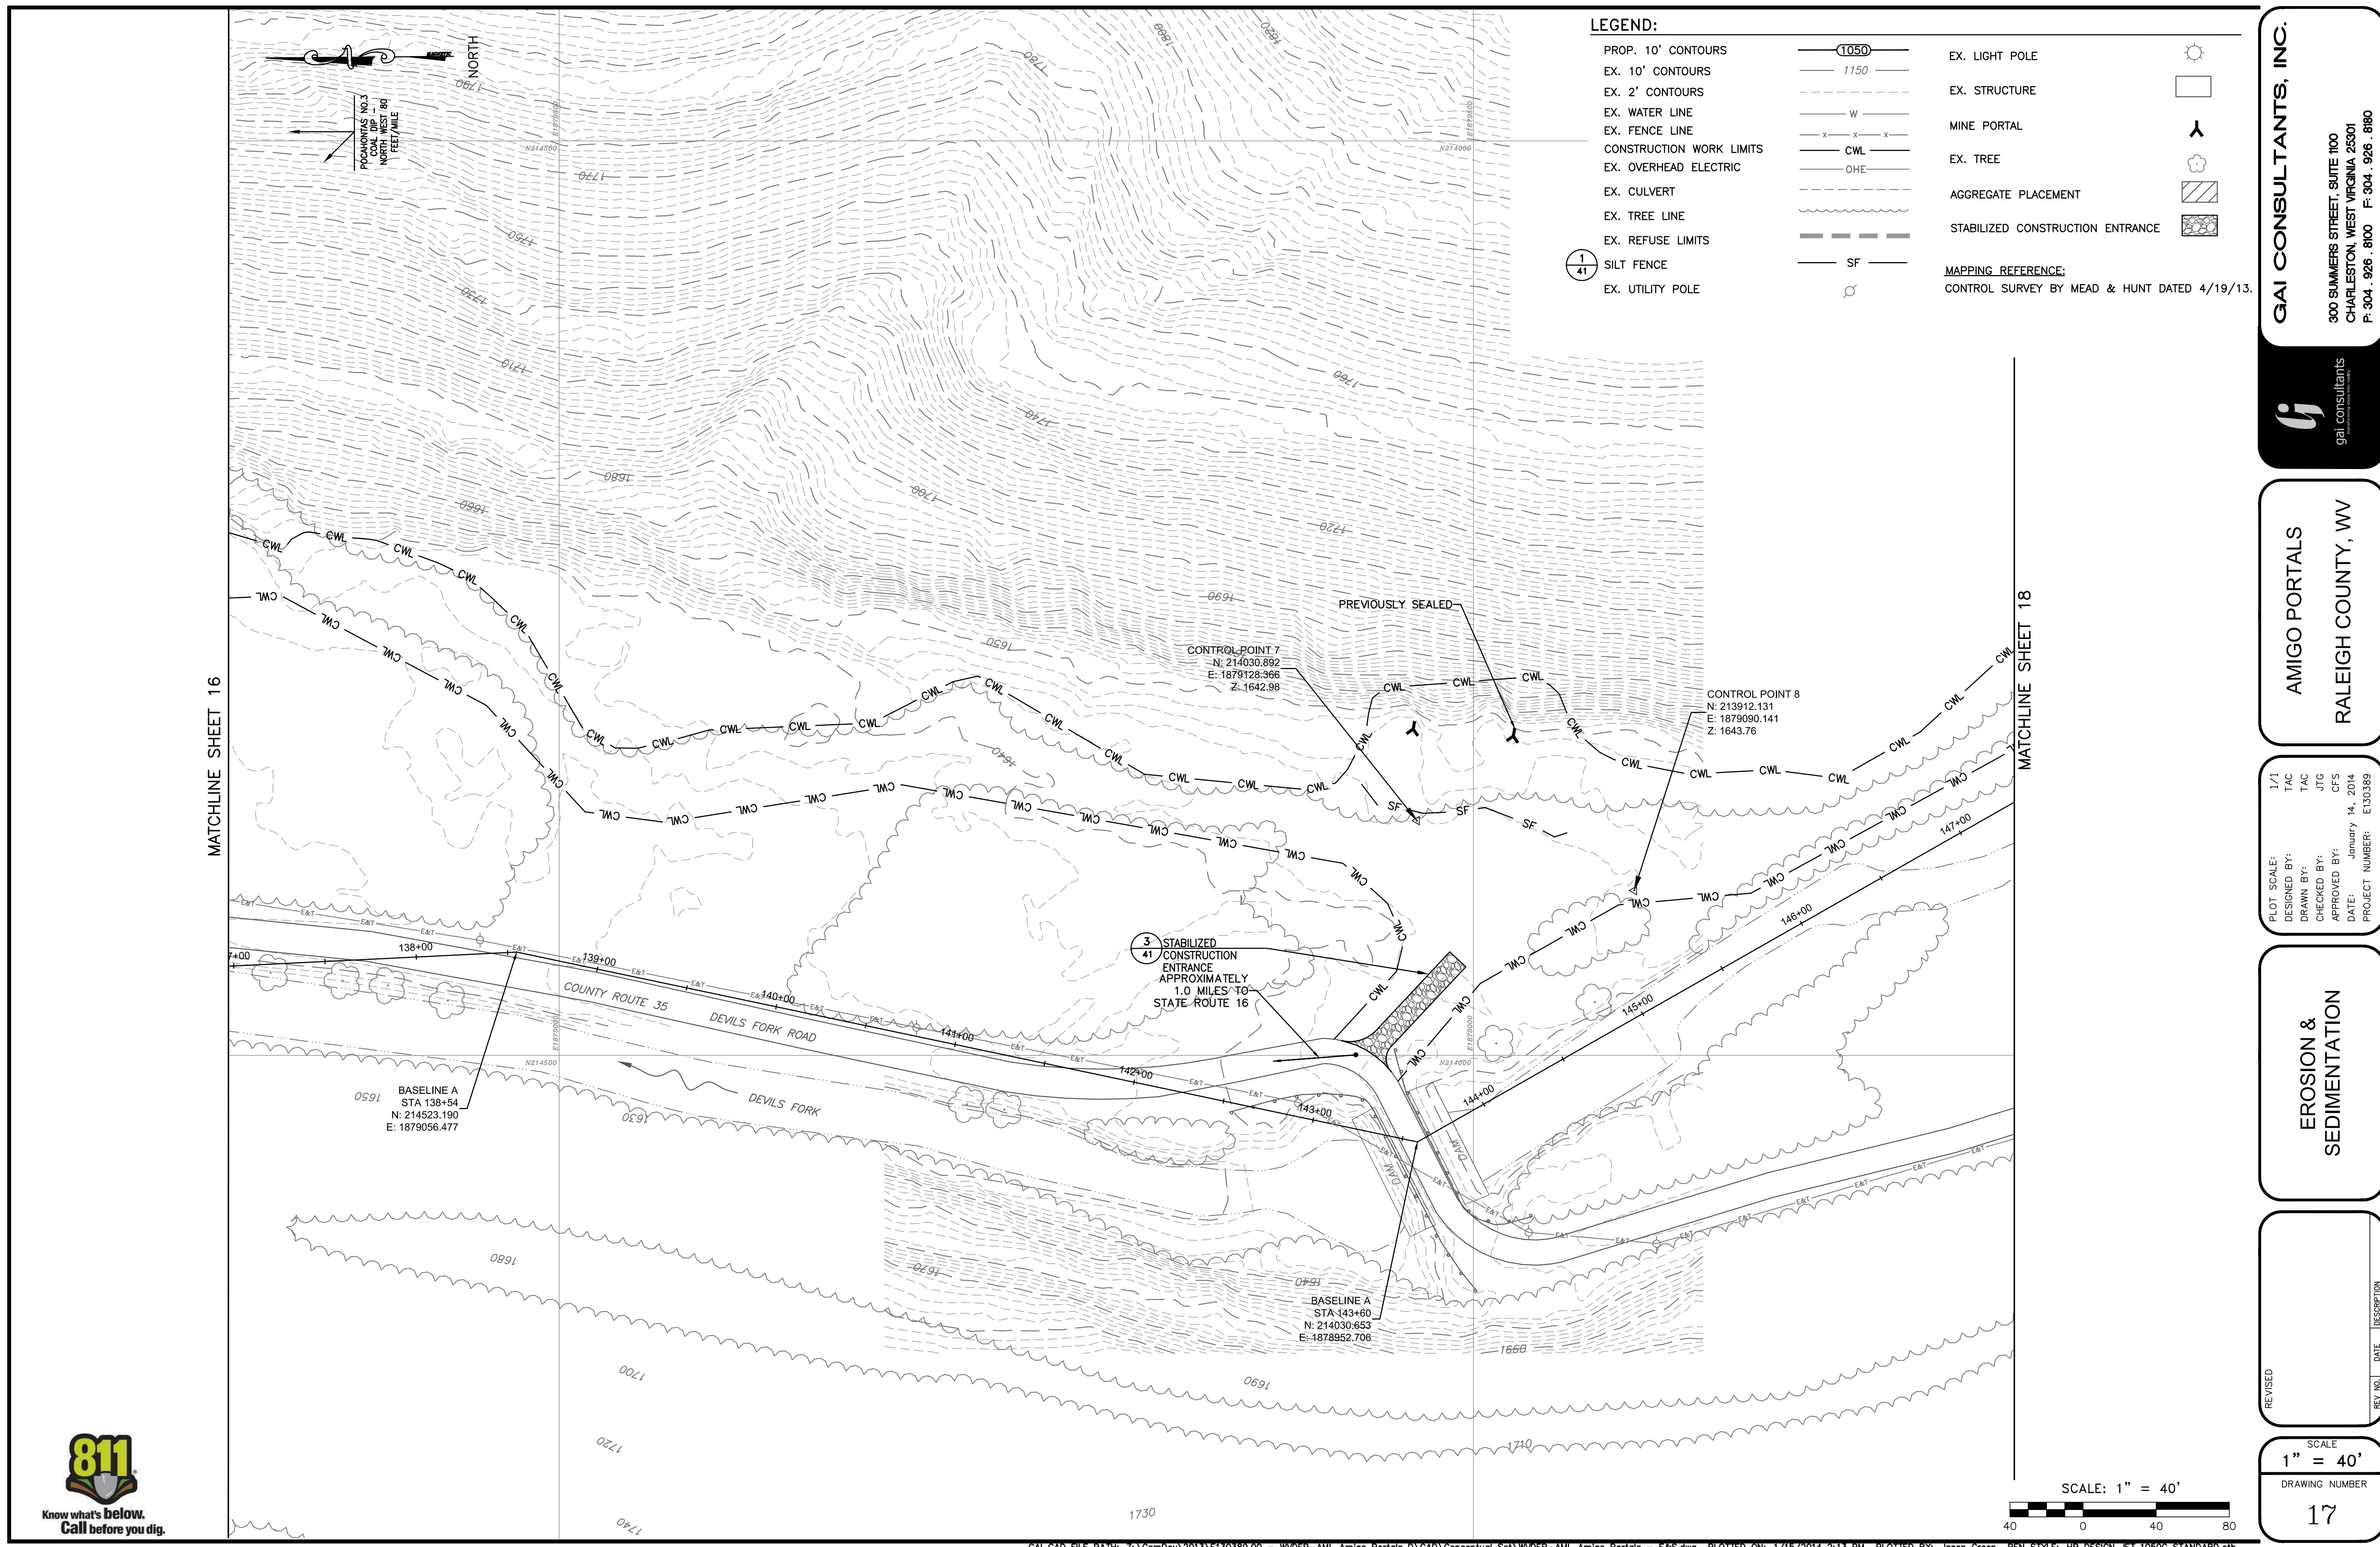

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AMIGO PORTALS

RALEIGH COUNTY, WV

EROSION & SEDIMENTATION

REVISED

REV. NO. DATE DESCRIPTION


AMIGO PORTALS
RALEIGH COUNTY, WVPLOT SCALE:
DRAWN BY:
CHECKED BY:
APPROVED BY:
DATE: January 14, 2014
PROJECT NUMBER: E1303839EROSION &
SEDIMENTATION

REVISED


REV. NO. DATE DESCRIPTION

SCALE
1" = 40'
DRAWING NUMBER
18

MATCHLINE SHEET 17

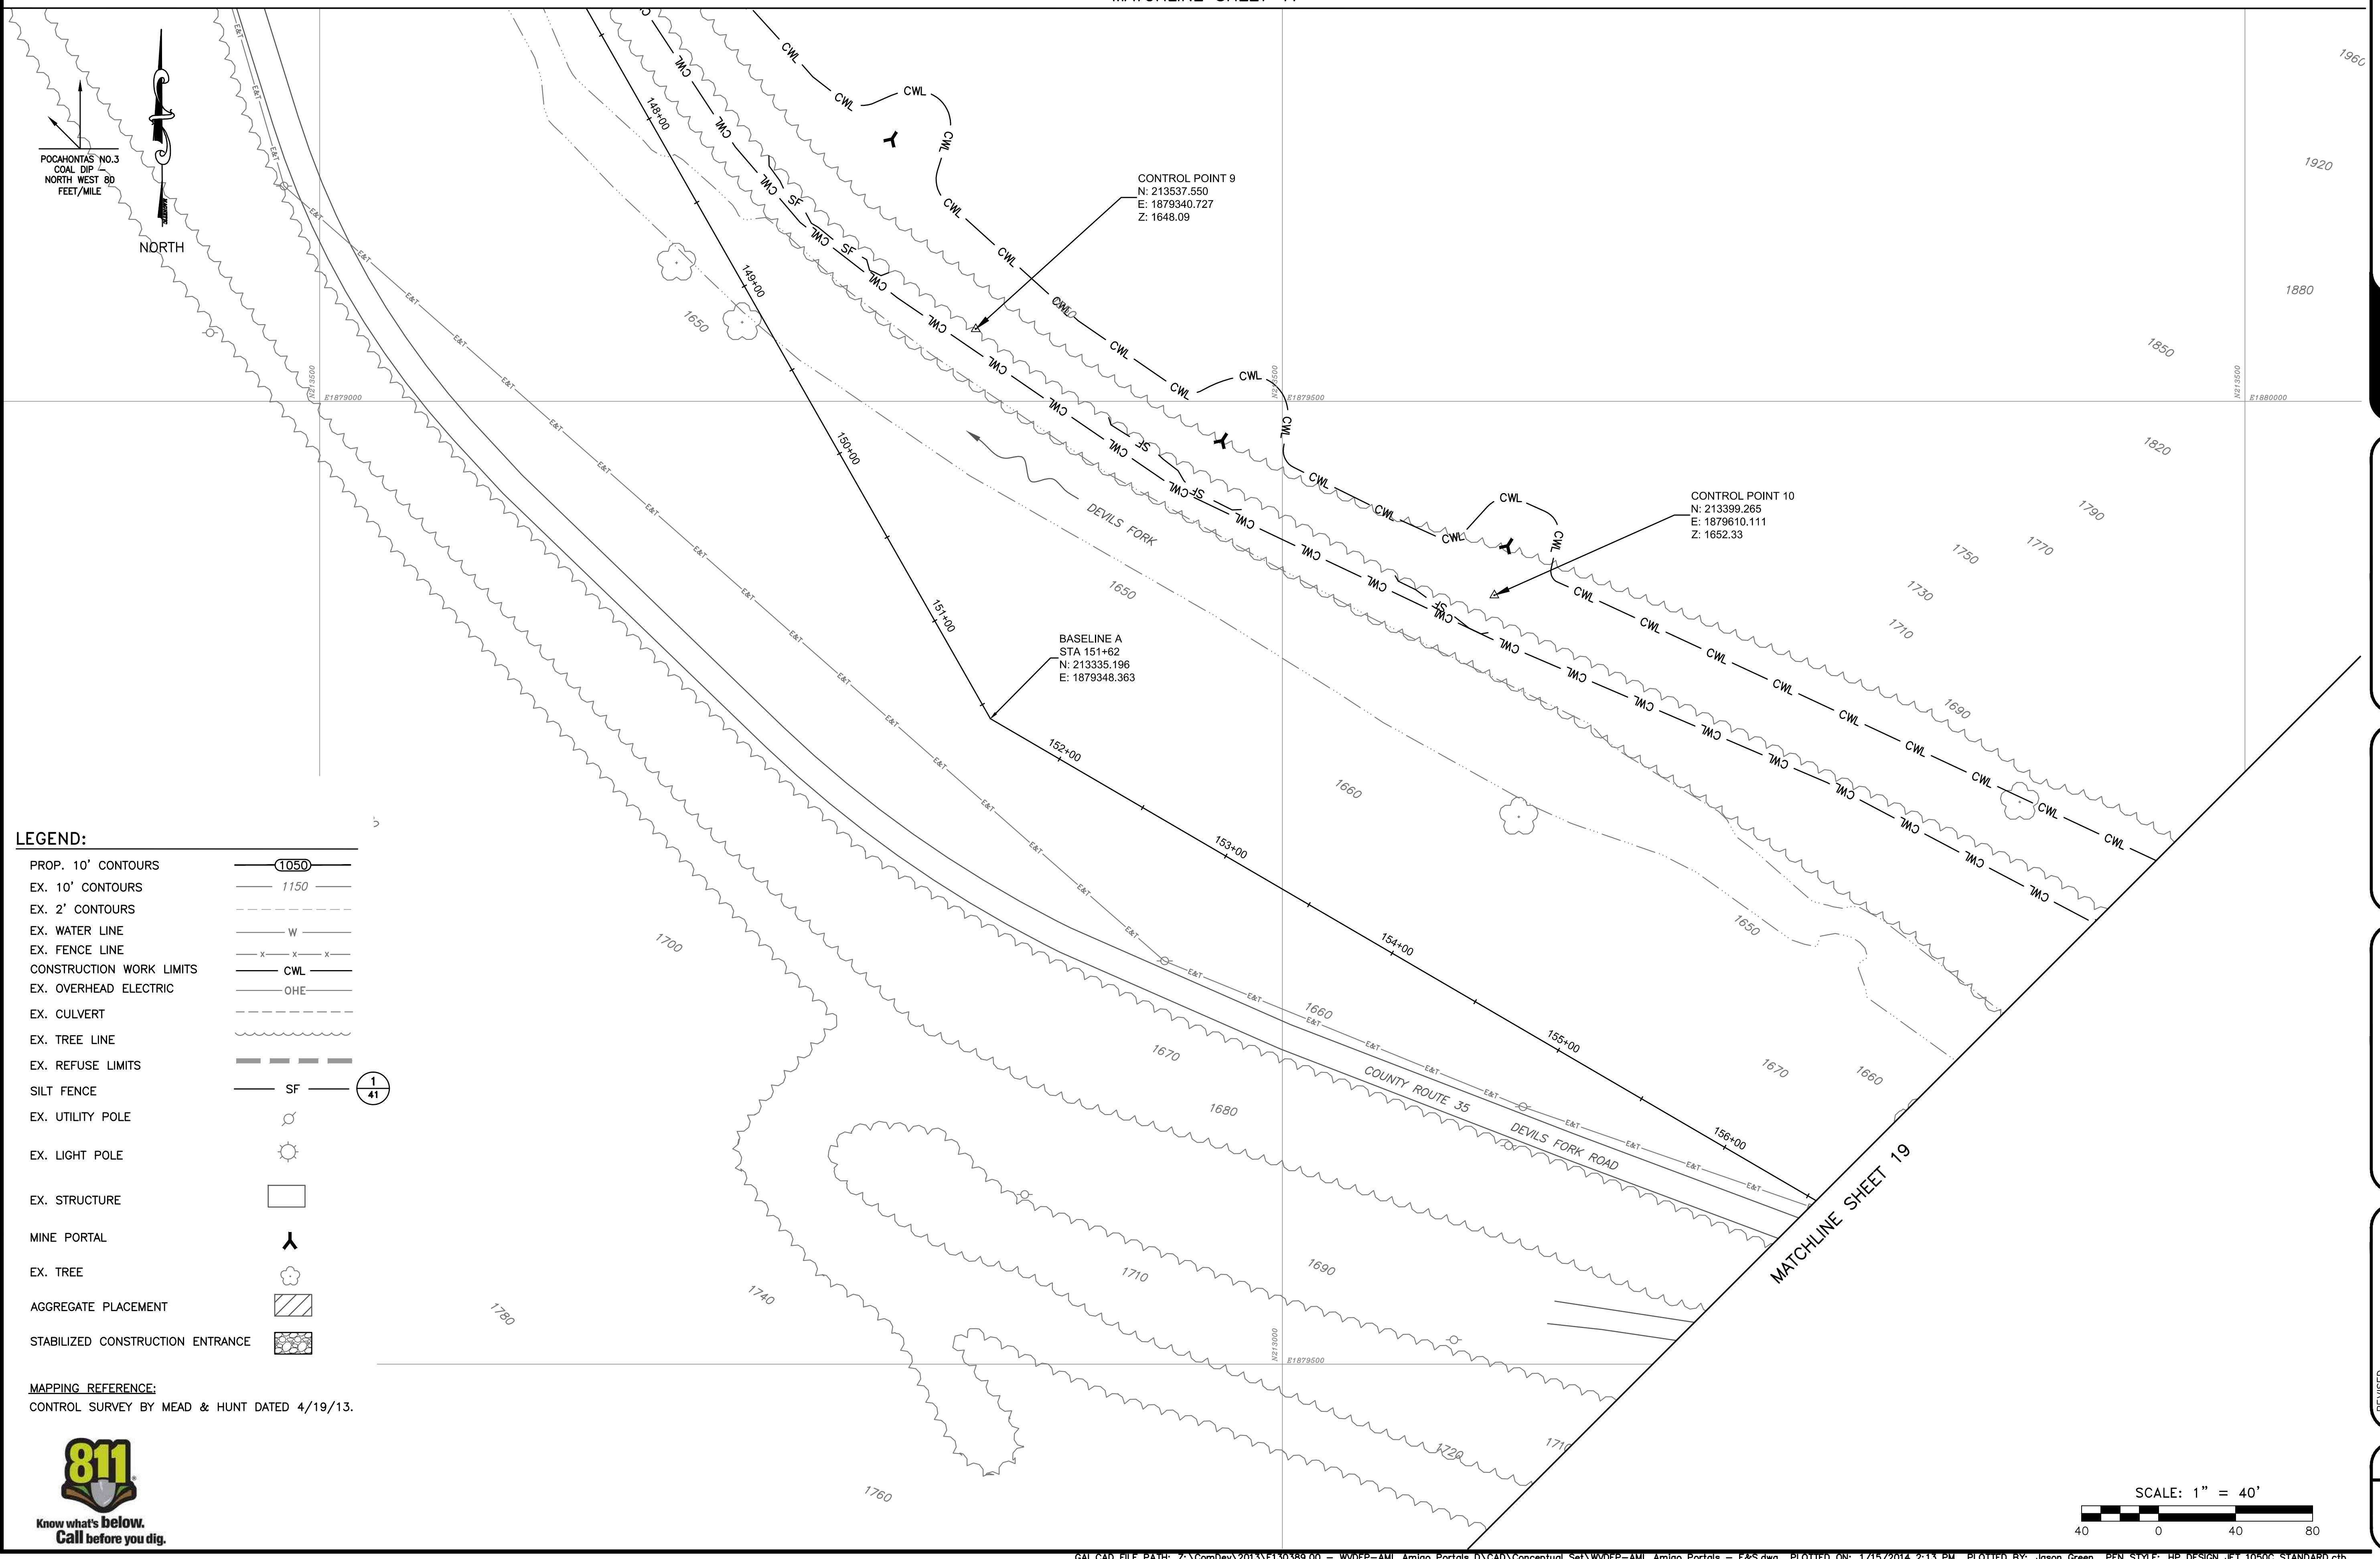

MATCHLINE SHEET 18

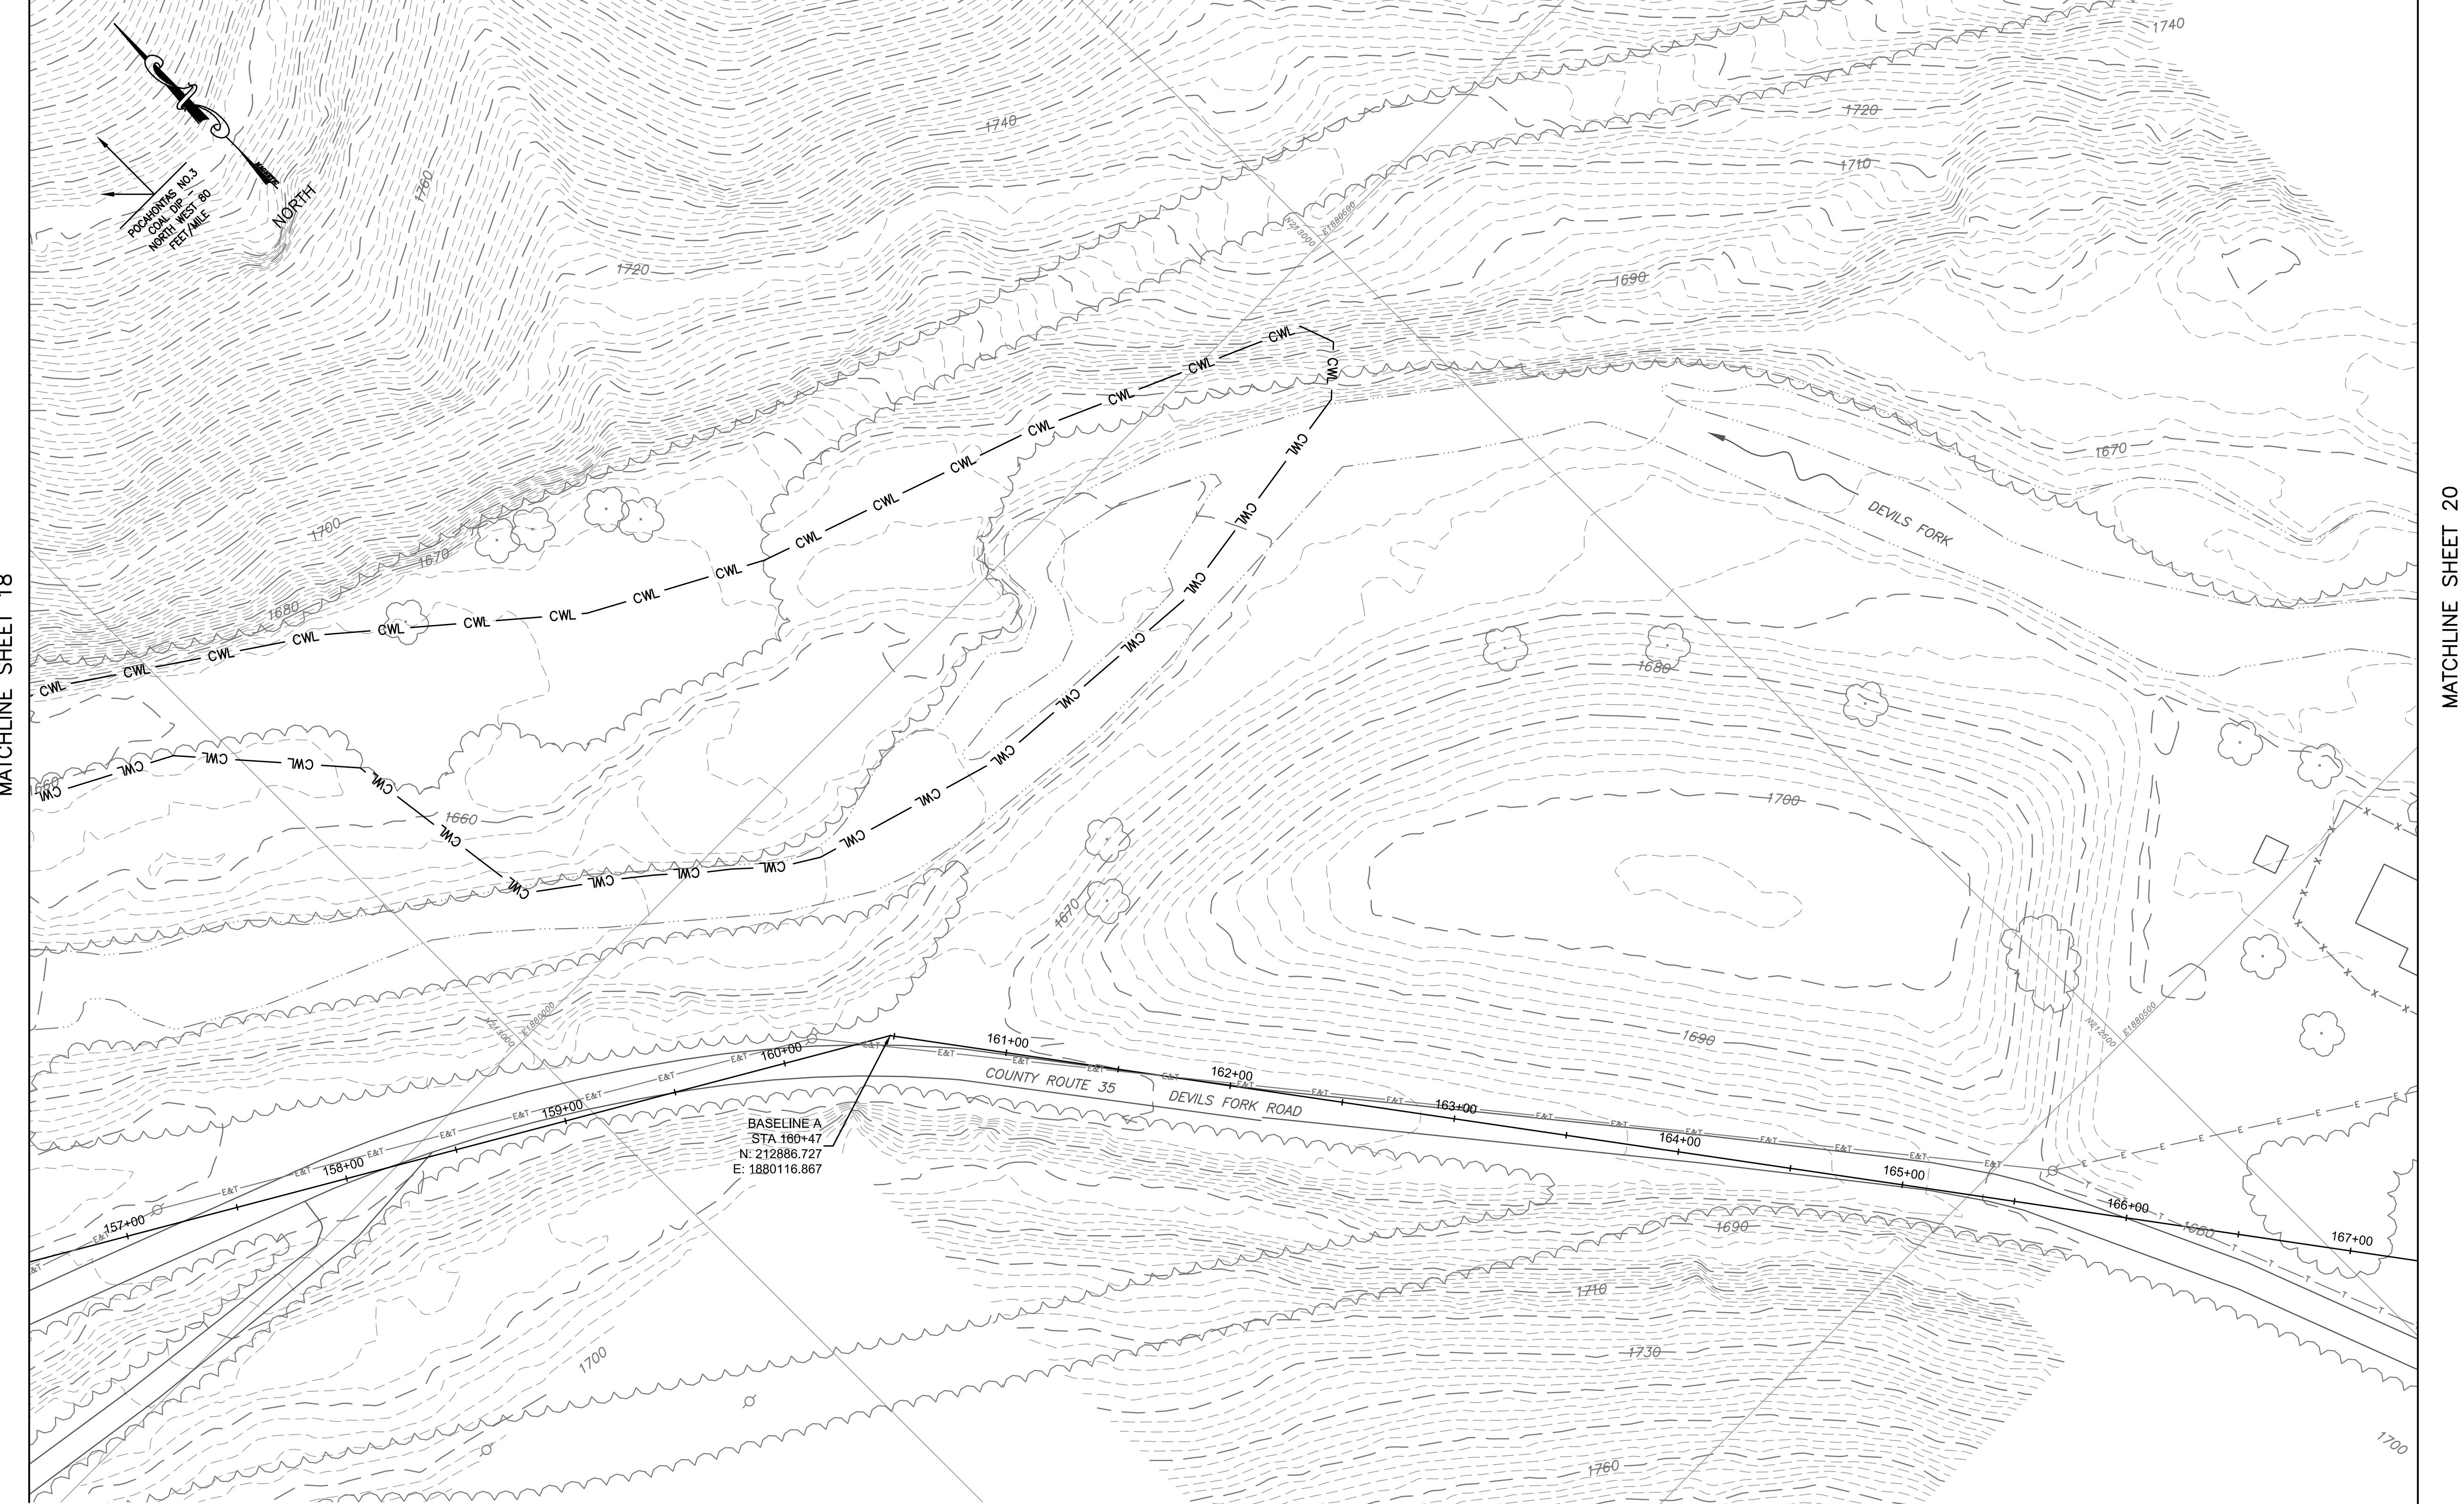

LEGEND:

PROP. 10' CONTOURS	1050	EX. LIGHT POLE
EX. 10' CONTOURS	1150	EX. STRUCTURE
EX. 2' CONTOURS	W	MINE PORTAL
EX. WATER LINE	x-x-x	EX. TREE
EX. FENCE LINE	CWL	AGGREGATE PLACEMENT
CONSTRUCTION WORK LIMITS	OHE	STABILIZED CONSTRUCTION ENTRANCE
EX. OVERHEAD ELECTRIC		
EX. CULVERT		
EX. TREE LINE		
EX. REFUSE LIMITS		
SILT FENCE	SF	
EX. UTILITY POLE		

MAPPING REFERENCE:
CONTROL SURVEY BY MEAD & HUNT DATED 4/19/13.

SCALE: 1" = 40'

DRAWING NUMBER
19

REV. NO.

DATE

DESCRIPTION

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AMIGO PORTALS

RALEIGH COUNTY, WV

PLOT SCALE:
1/1

TAC

JTG

CS

DESIGNED BY:
DRAWN BY:
CHECKED BY:
APPROVED BY:

TAC

JTG

CS

DATE:
January 14, 2014


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RALEIGH COUNTY, WV

EROSION & SEDIMENTATION

SCALE
= 40'
ING NUMBER
20

AMIGO PORTALS
RALEIGH COUNTY, WV

PLOT SCALE: 1/1
DESIGNED BY: TAC
DRAWN BY: TAC
CHECKED BY: JTG
APPROVED BY: CS
DATE: January 14, 2014
PROJECT NUMBER: E1303839

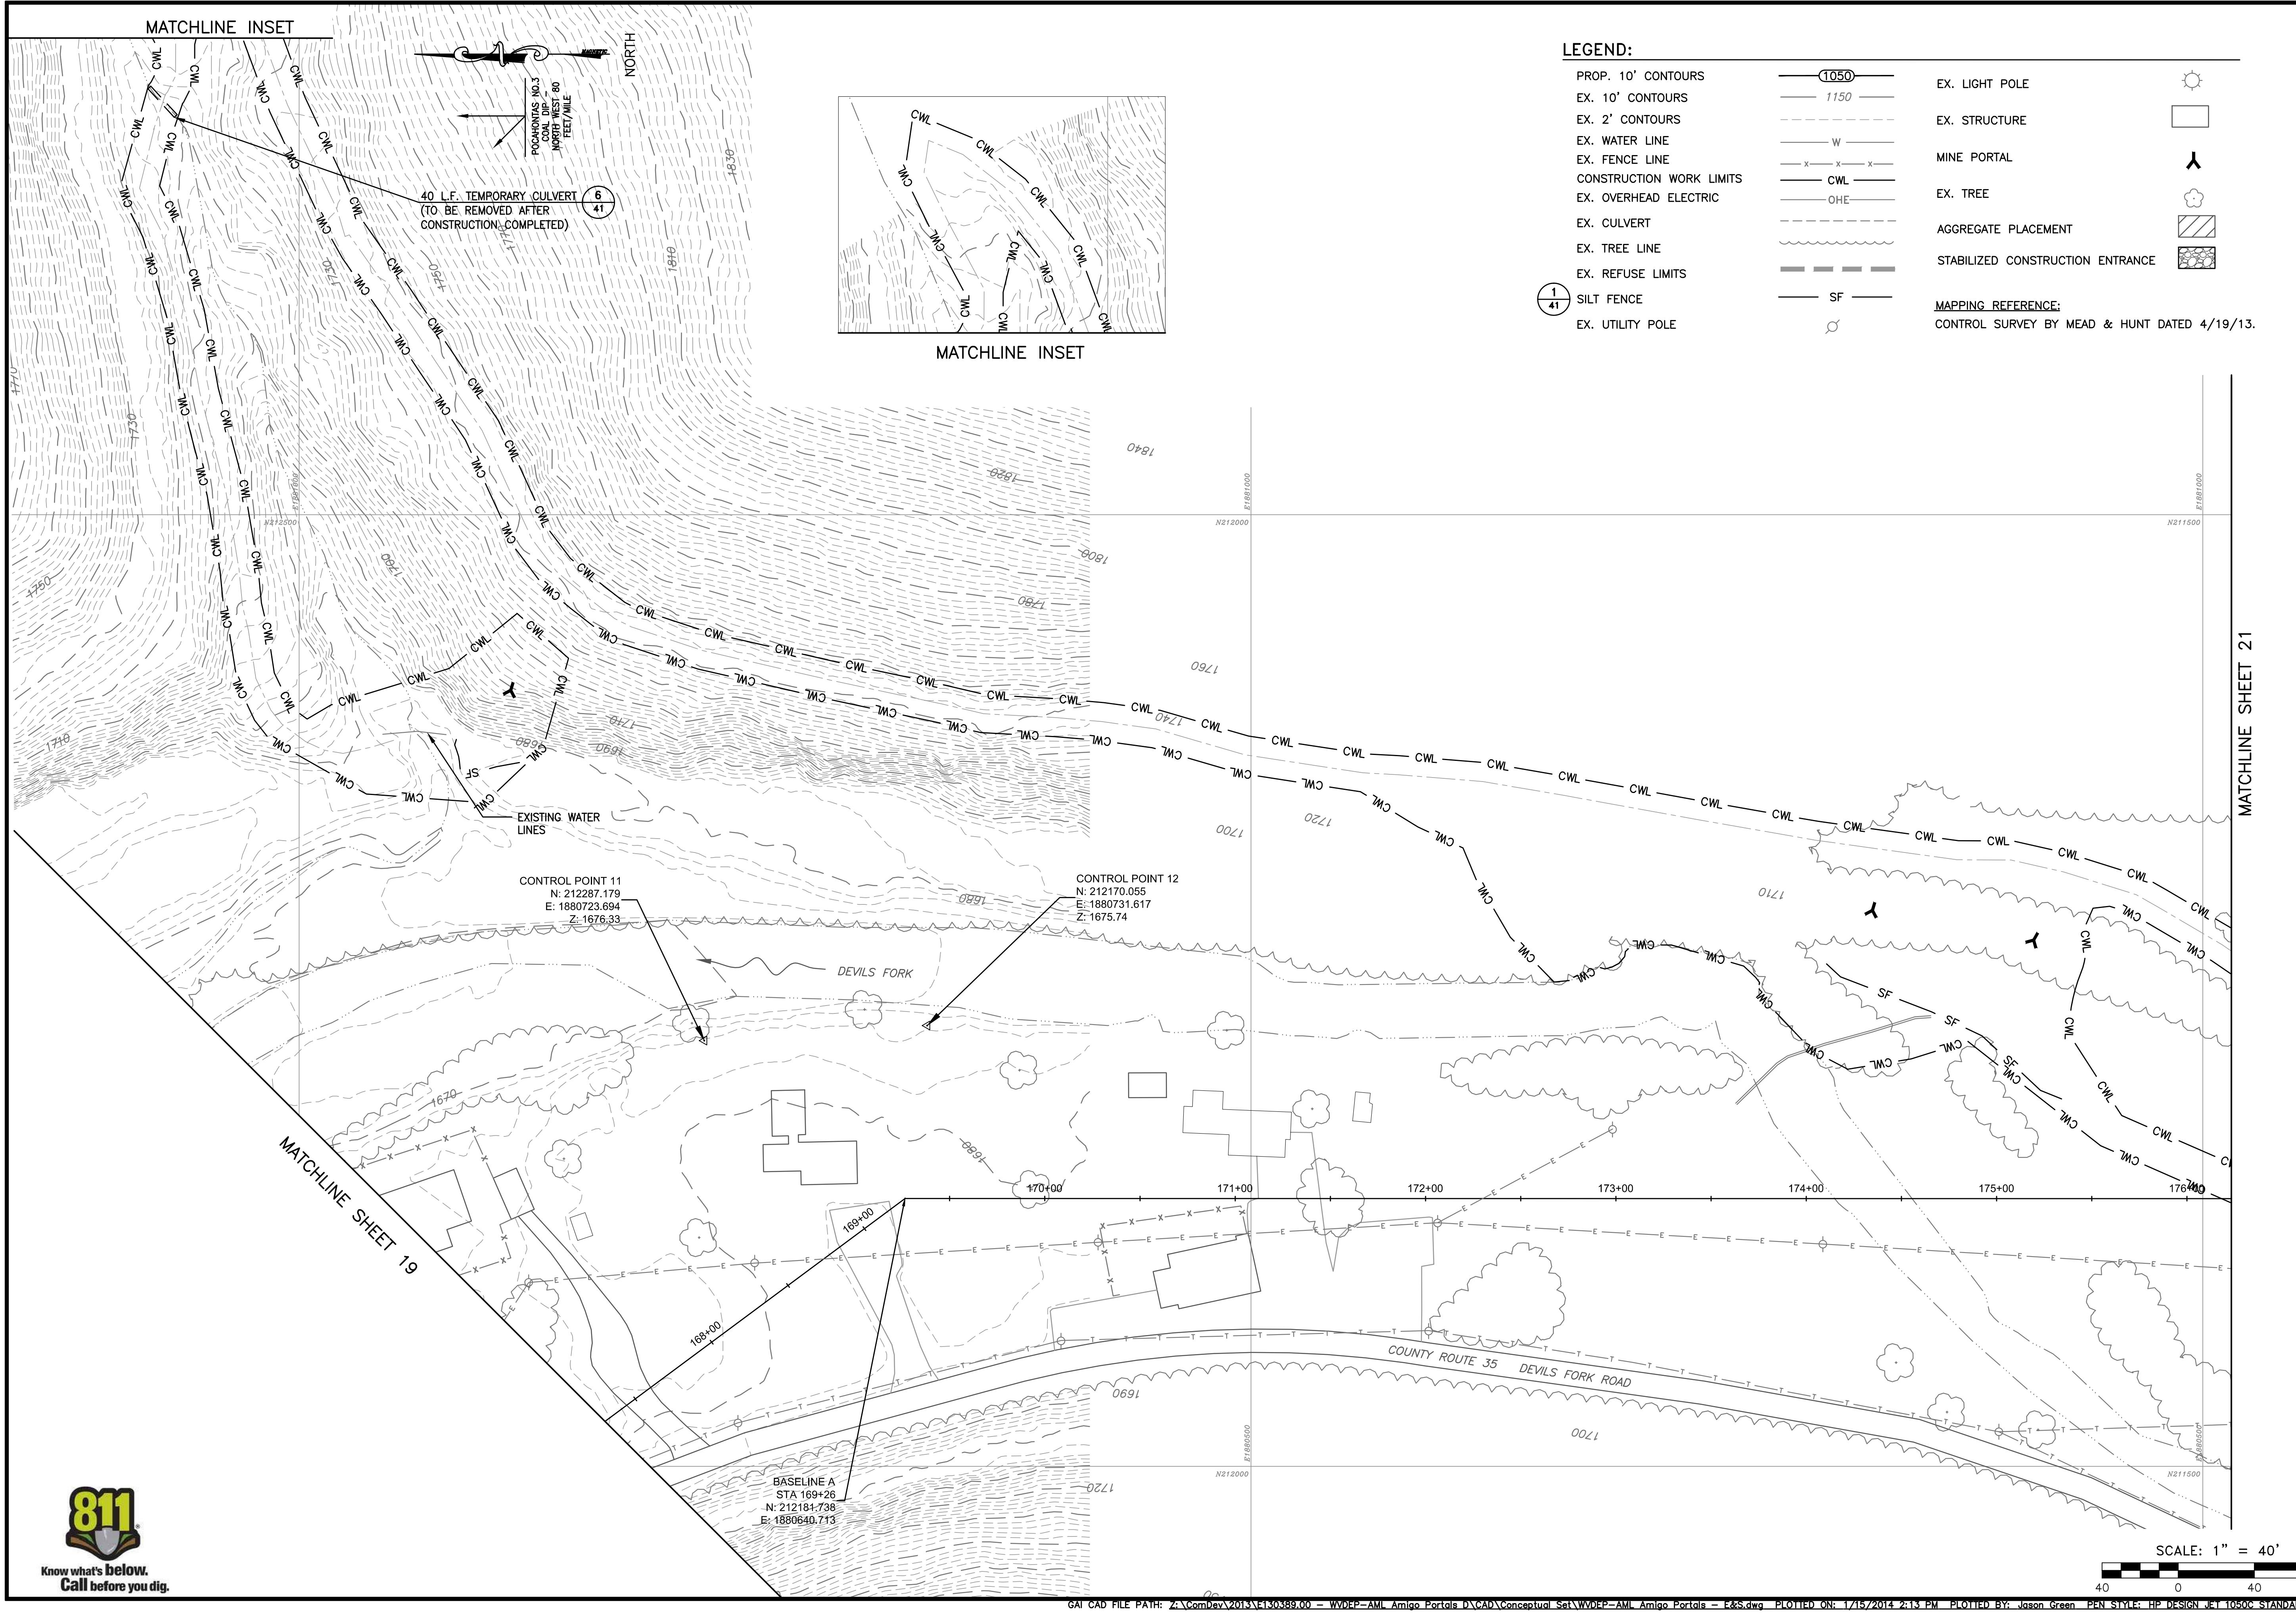EROSION & SEDIMENTATION

REV. NO.: DATE: DESCRIPTION

SCALE: 1" = 40'
DRAWING NUMBER: 21

BASELINE A
STA 187+00
N: 211002.597
E: 1881399.429

CONTROL POINT 14
N: 210811.291
E: 1881317.494
Z: 1713.33

LEGEND:

- PROP. 10' CONTOURS
- EX. 10' CONTOURS
- EX. 2' CONTOURS
- EX. WATER LINE
- EX. FENCE LINE
- CONSTRUCTION WORK LIMITS
- EX. OVERHEAD ELECTRIC
- EX. CULVERT
- EX. TREE LINE
- EX. REFUSE LIMITS
- SILT FENCE
- EX. UTILITY POLE
- EX. LIGHT POLE
- EX. STRUCTURE
- MINE PORTAL
- EX. TREE
- AGGREGATE PLACEMENT
- STABILIZED CONSTRUCTION ENTRANCE

MAPPING REFERENCE:
CONTROL SURVEY BY MEAD & HUNT DATED 4/19/13.

SCALE: 1" = 40'
40 0 40 80



AMIGO PORTALS

RALEIGH COUNTY, WV

PROPOSED

REVISED

SCALE
1" = 40'DRAWING NUMBER
22

REV. NO. DATE DESCRIPTION


REvised

SCALE
1" = 40'DRAWING NUMBER
22

MATCHLINE SHEET 23

SCALE: 1" = 40'
40 0 40 80DRAWING NUMBER
22

PORTAL SEAL TABLE			
PORTAL	TYPE	ELEVATION (FT)	CULVERT
1	BAT GATE	1593.6	48"
4	BAT GATE	-	48"

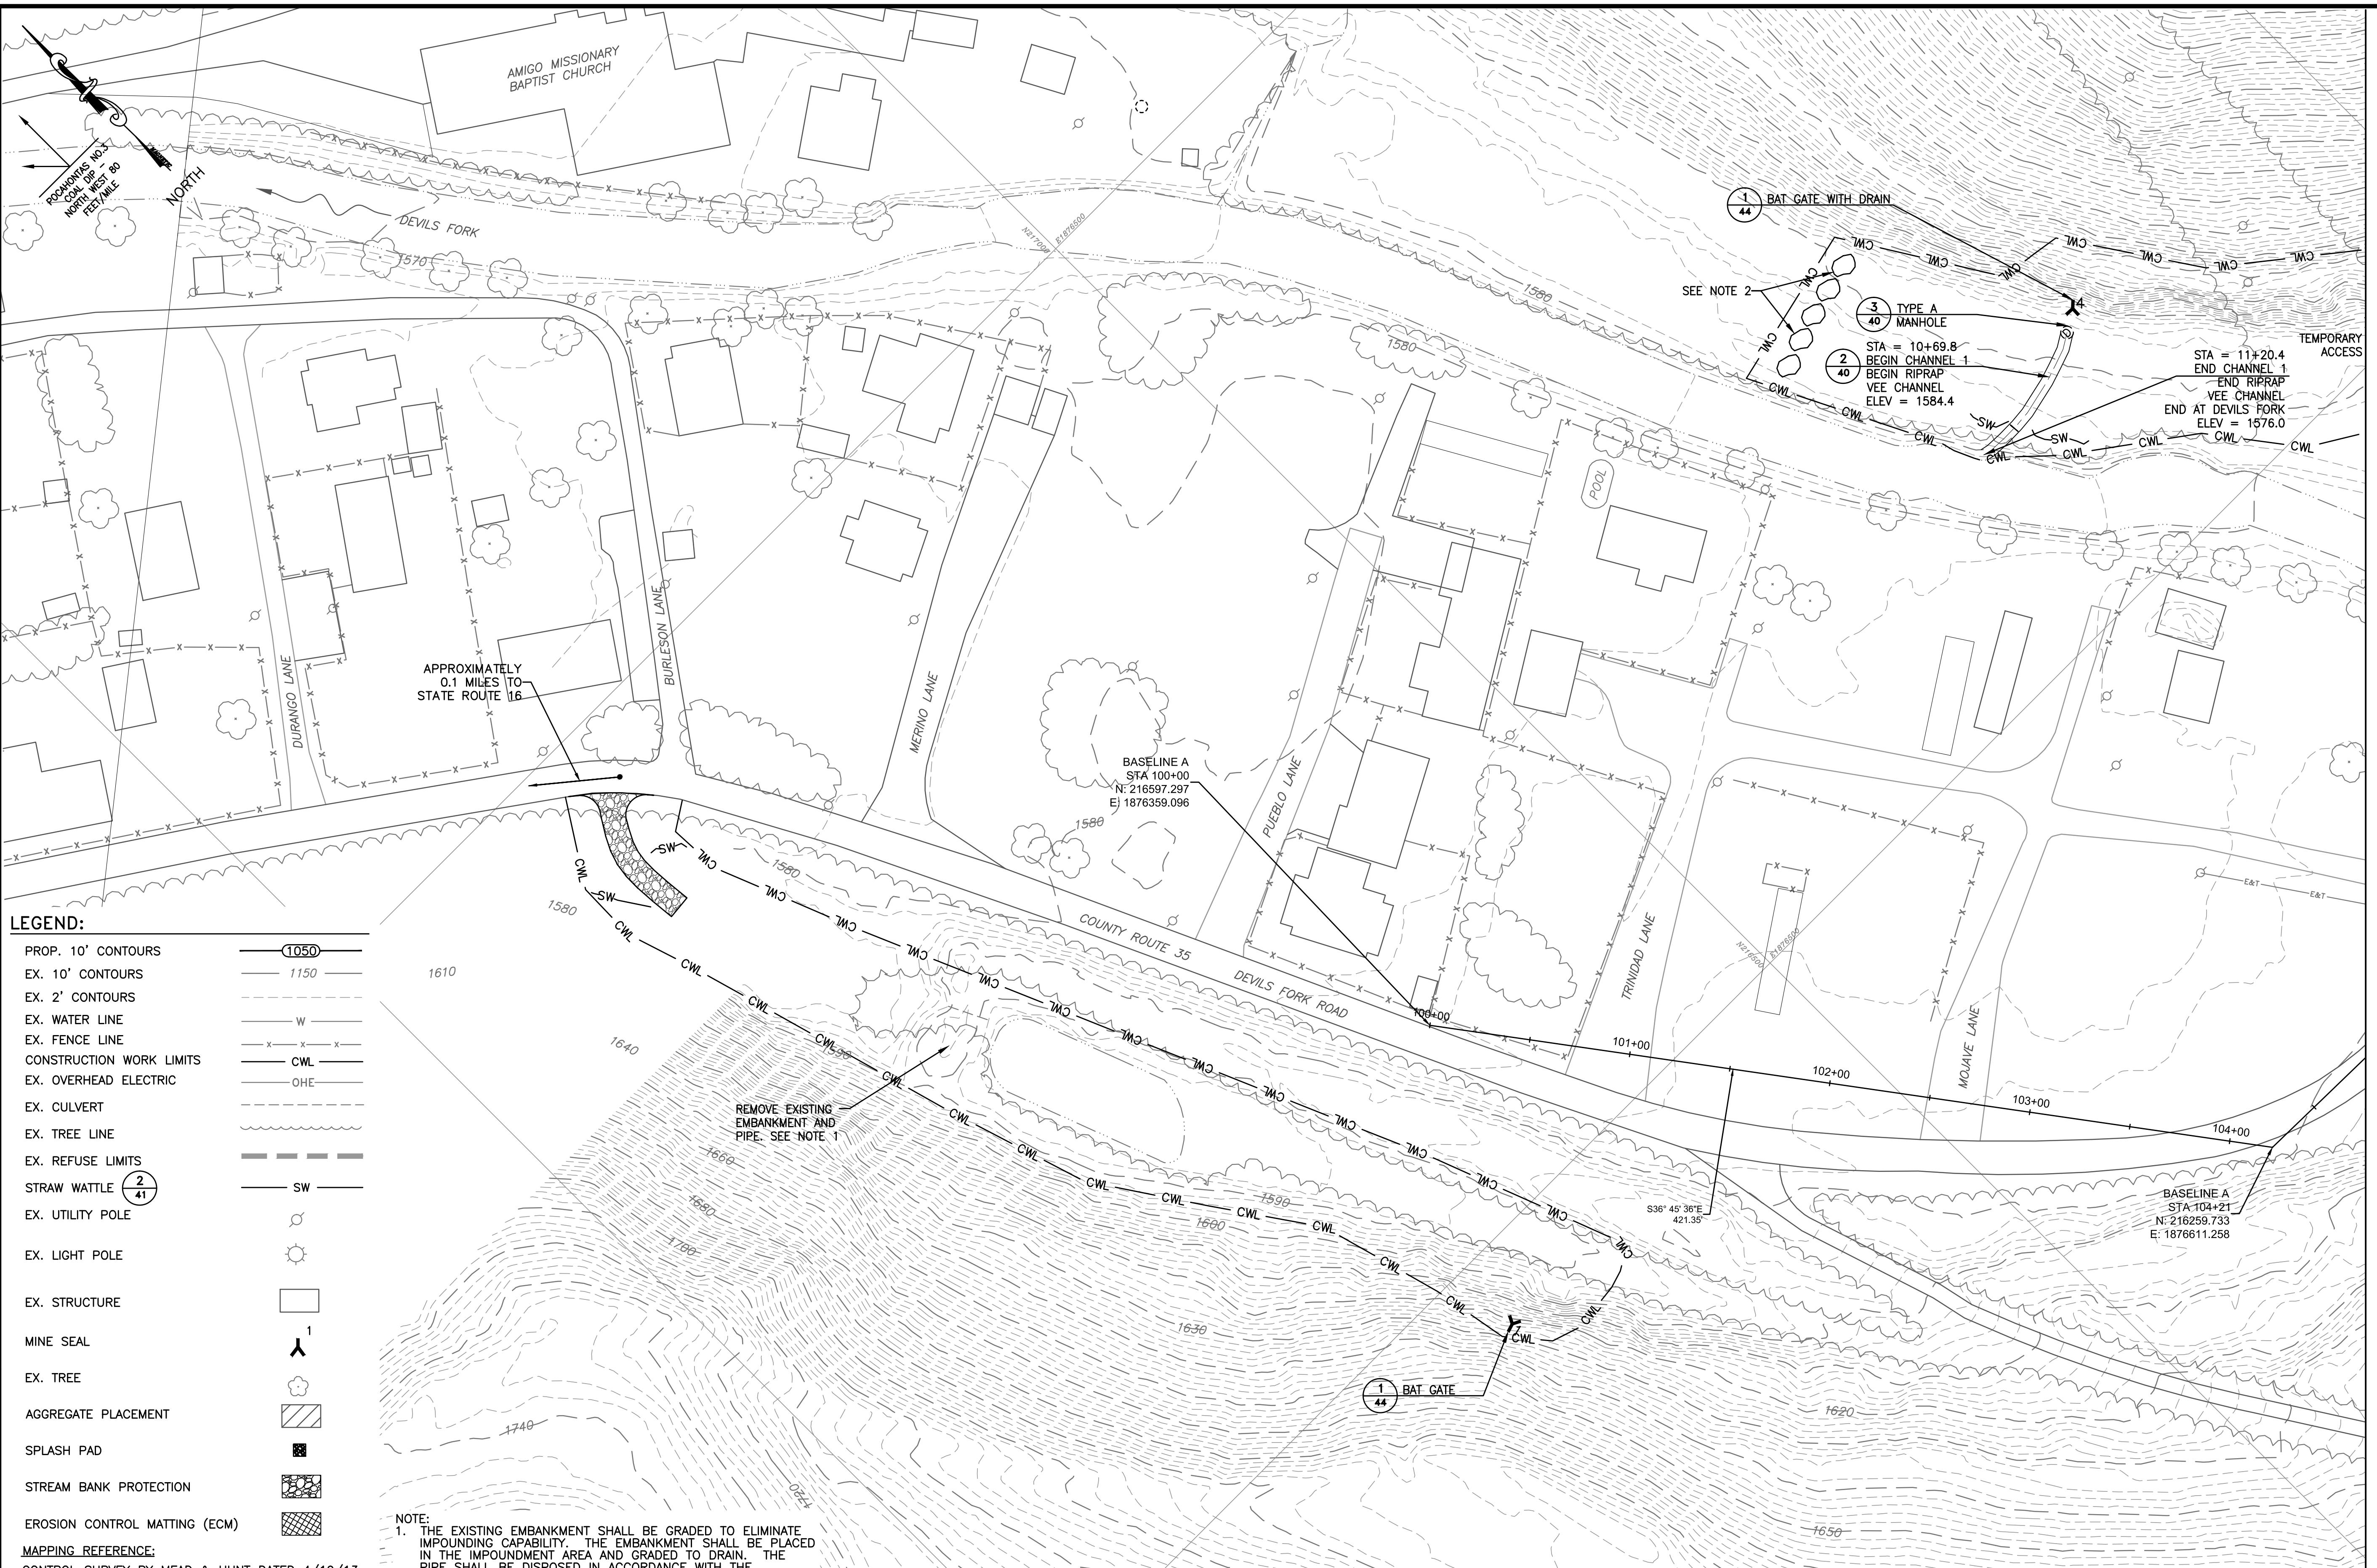

AMIGO PORTALS

RALEIGH COUNTY, WV

PROPOSED

REVISED

REVISION

REV. NO. DATE DESCRIPTION

SCALE
1" = 40'
DRAWING NUMBER

23

LEGEND:

PROP. 10' CONTOURS	1050
EX. 10' CONTOURS	1150
EX. 2' CONTOURS	
EX. WATER LINE	W
EX. FENCE LINE	x x x
CONSTRUCTION WORK LIMITS	CWL
EX. OVERHEAD ELECTRIC	OHE
EX. CULVERT	
EX. TREE LINE	
EX. REFUSE LIMITS	
STRAW WATTLE	
EX. UTILITY POLE	
EX. LIGHT POLE	
EX. STRUCTURE	
MINE SEAL	1
EX. TREE	
AGGREGATE PLACEMENT	
SPLASH PAD	
STREAM BANK PROTECTION	
EROSION CONTROL MATTING (ECM)	
MAPPING REFERENCE:	
CONTROL SURVEY BY MEAD & HUNT DATED 4/19/13.	


PLOT SCALE: 1/1
DRAWN BY: TAC
TAC
JTG
CS
APPROVED BY:
DATE: January 14, 2014
PROJECT NUMBER: E130389

MATCHLINE SHEET 22

MATCHLINE SHEET 24

MATCHLINE SHEET 24</p


MATCHLINE SHEET 23

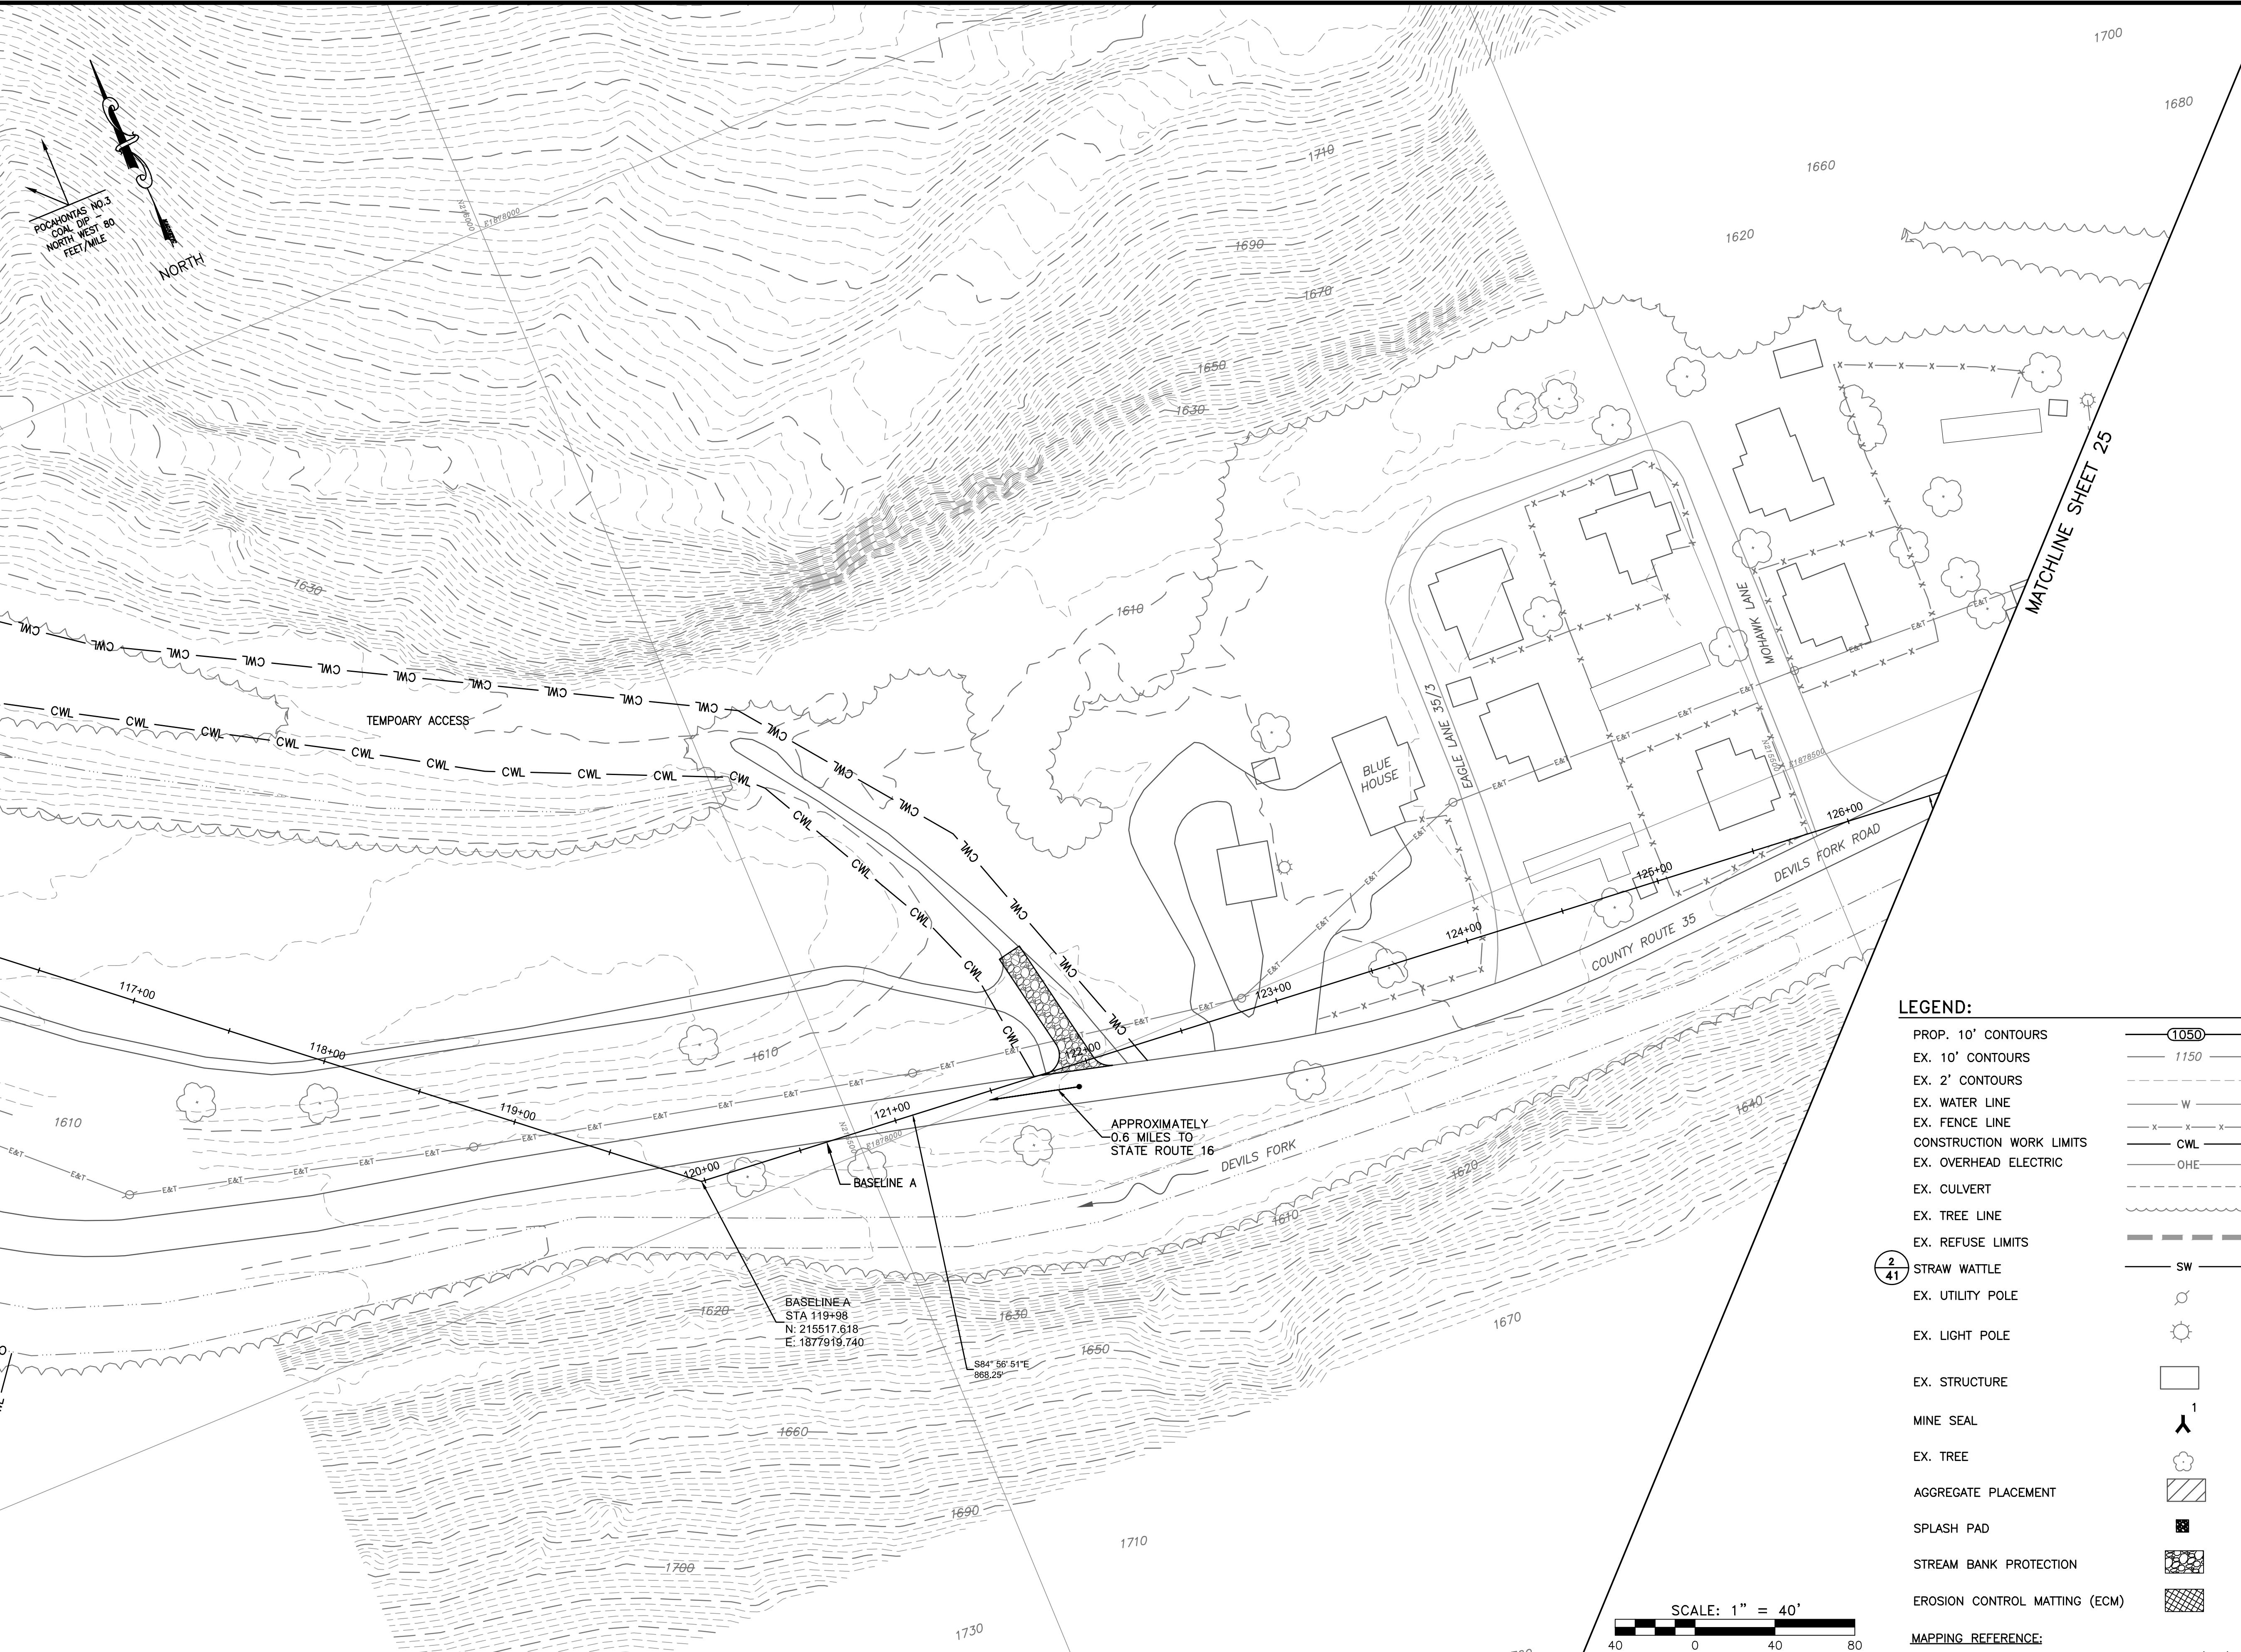


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MATCHLINE SHEET 24



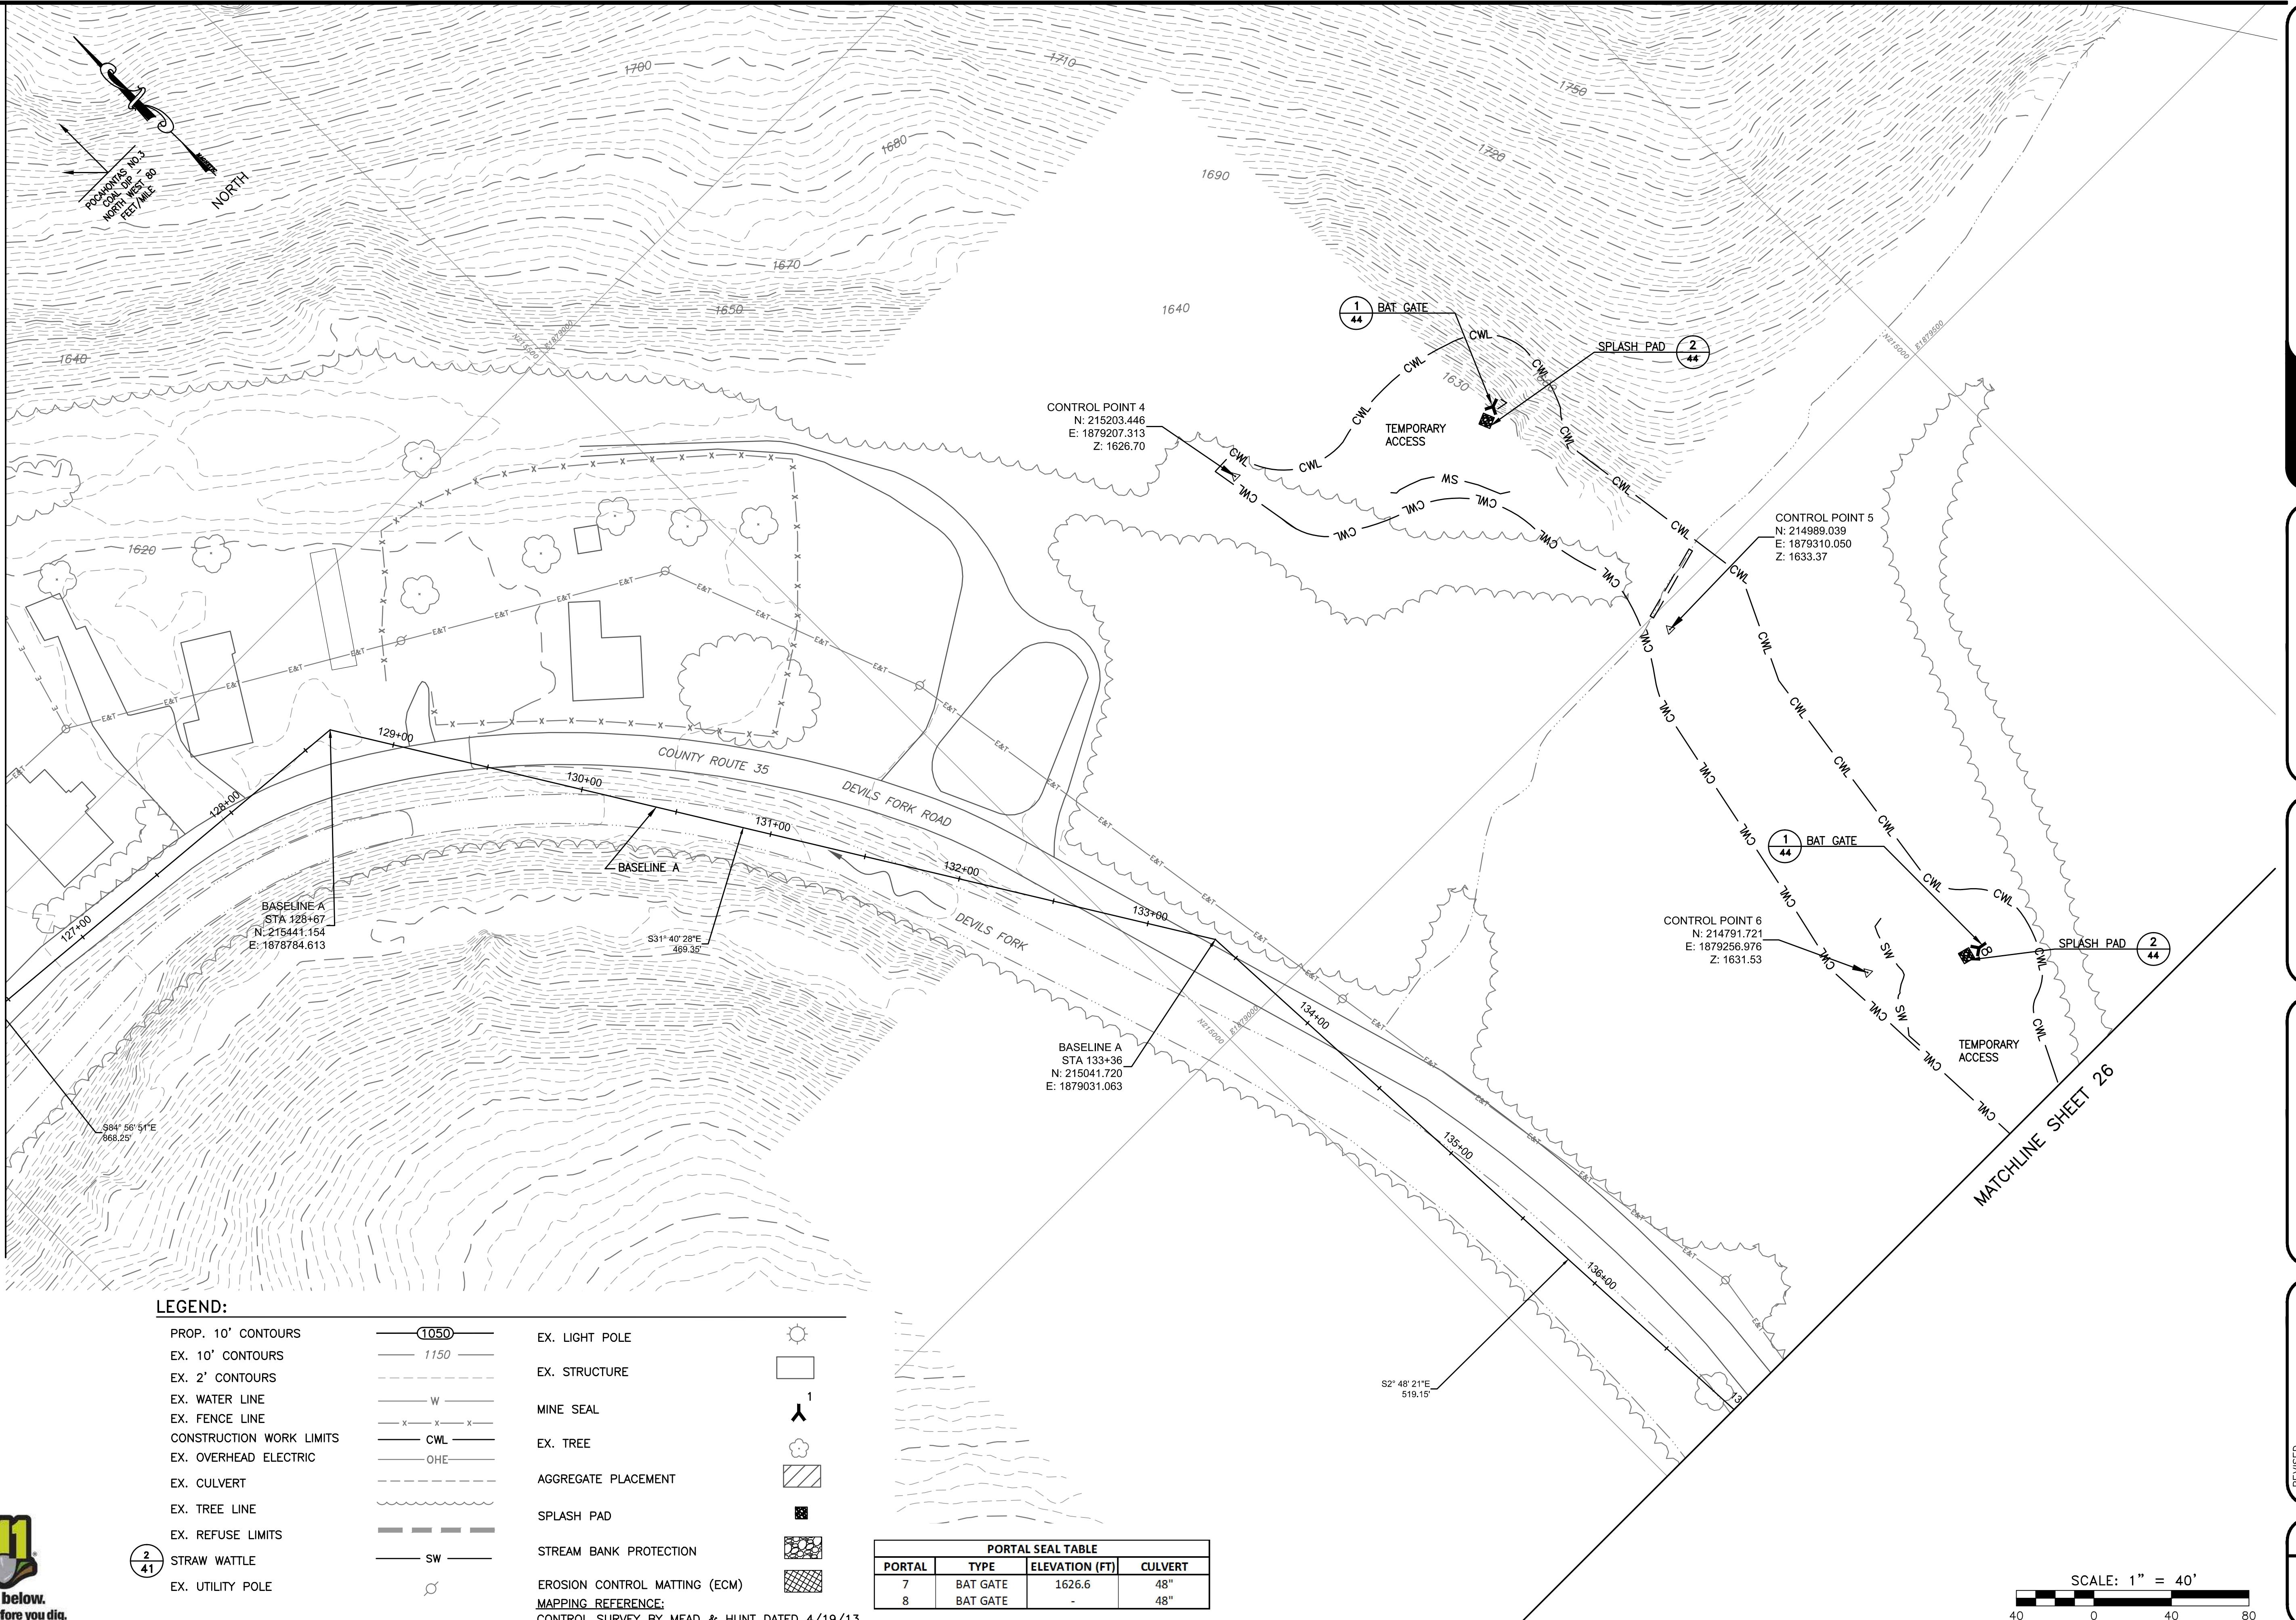


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RALEIGH COUNTY, WVPLOT SCALE:
DRAWN BY:
CHECKED BY:
APPROVED BY:
DATE: January 14, 2014
PROJECT NUMBER: E130389

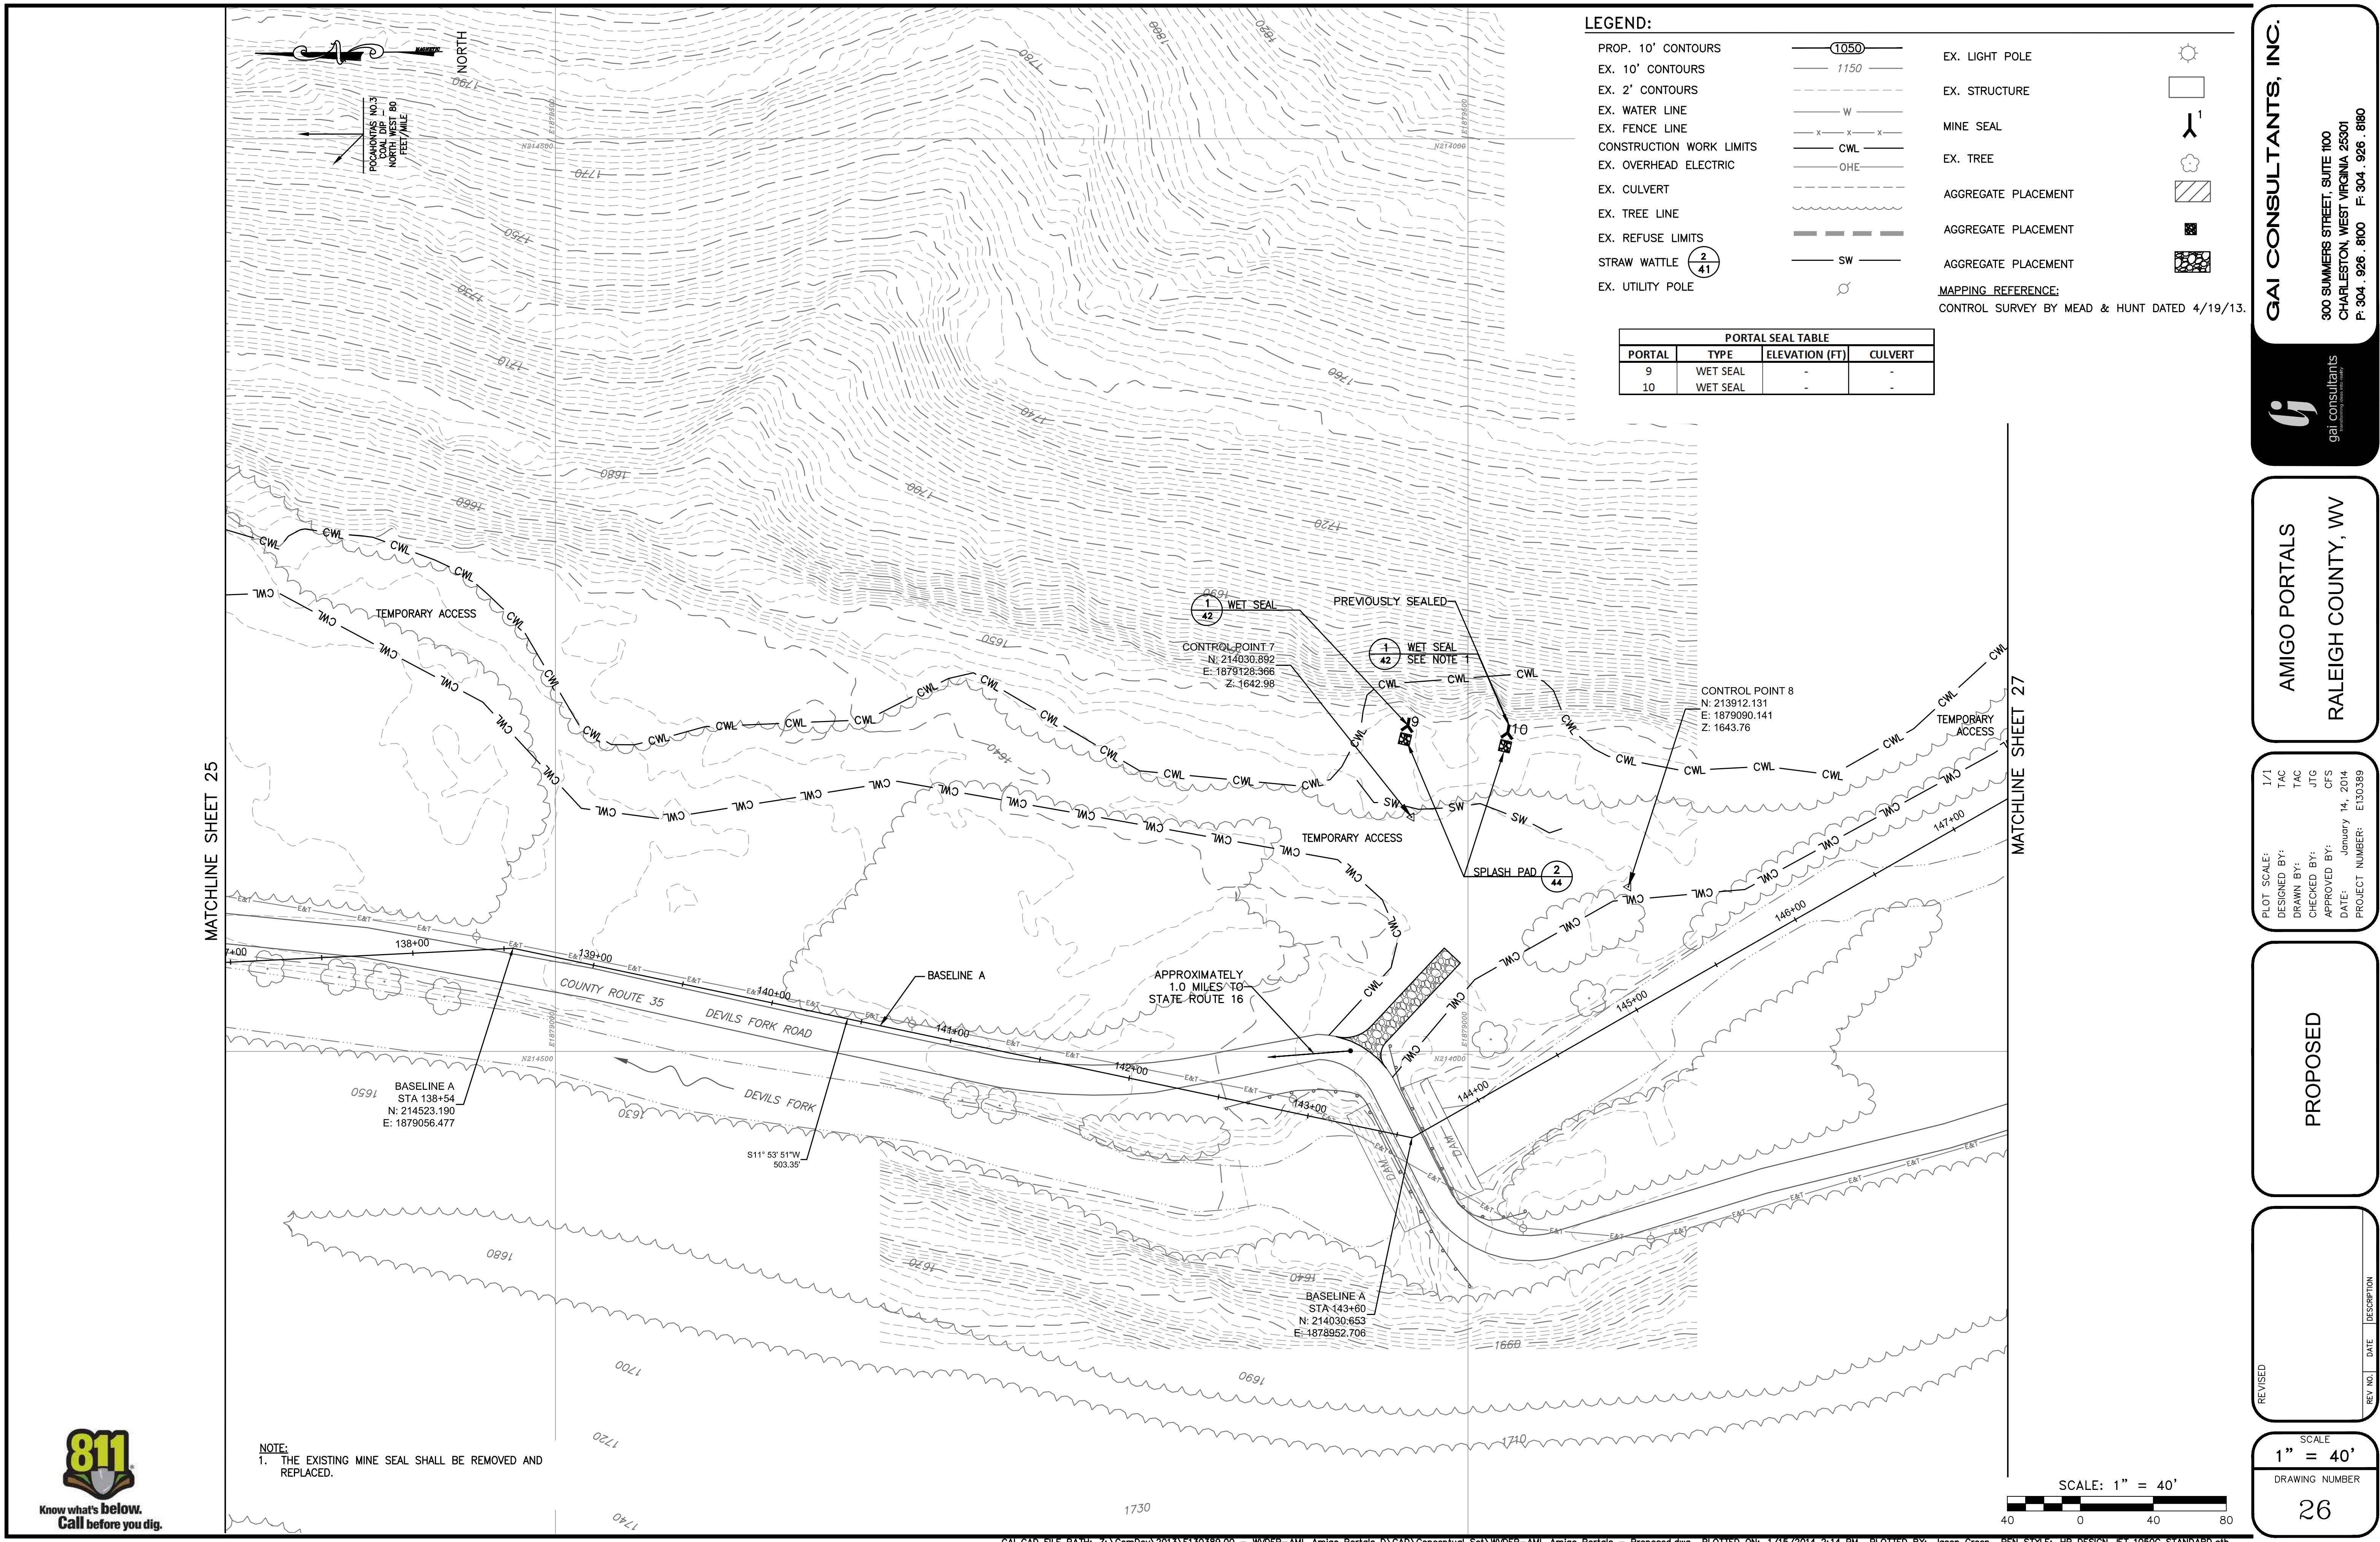PROPOSED


REVISED

SCALE
1" = 40'
DRAWING NUMBER
27

MATCHLINE SHEET 26

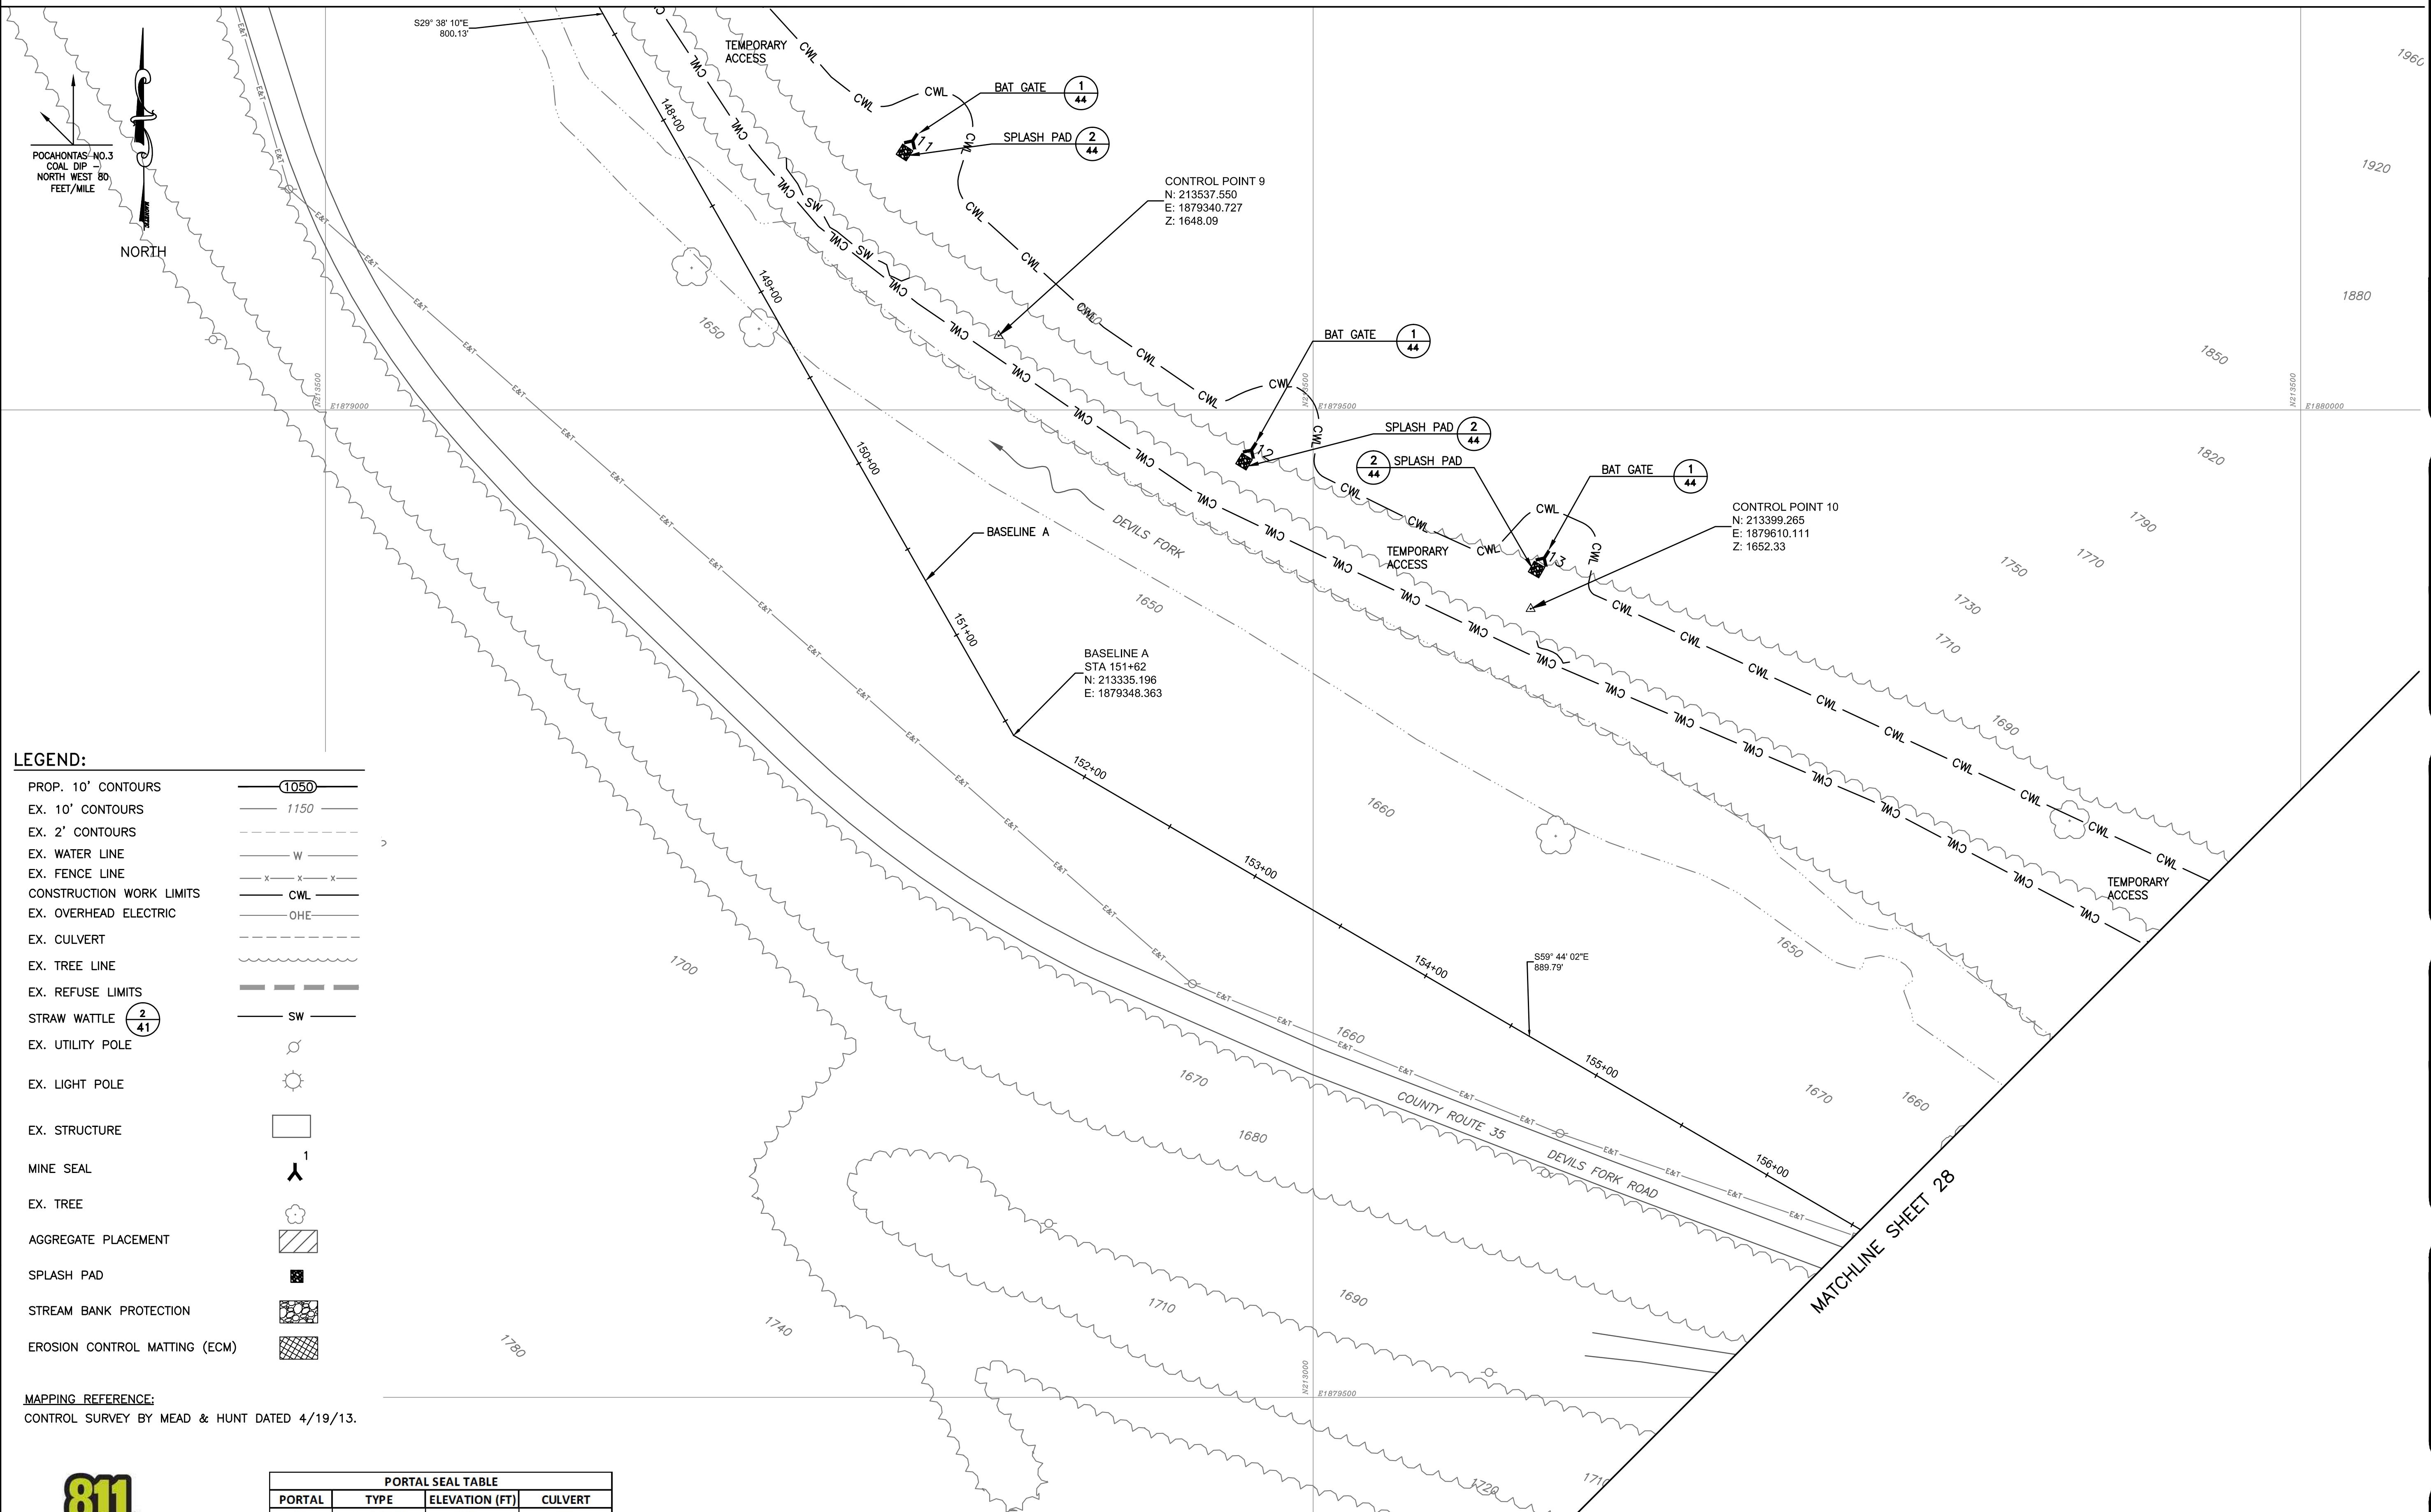

MATCHLINE SHEET 27

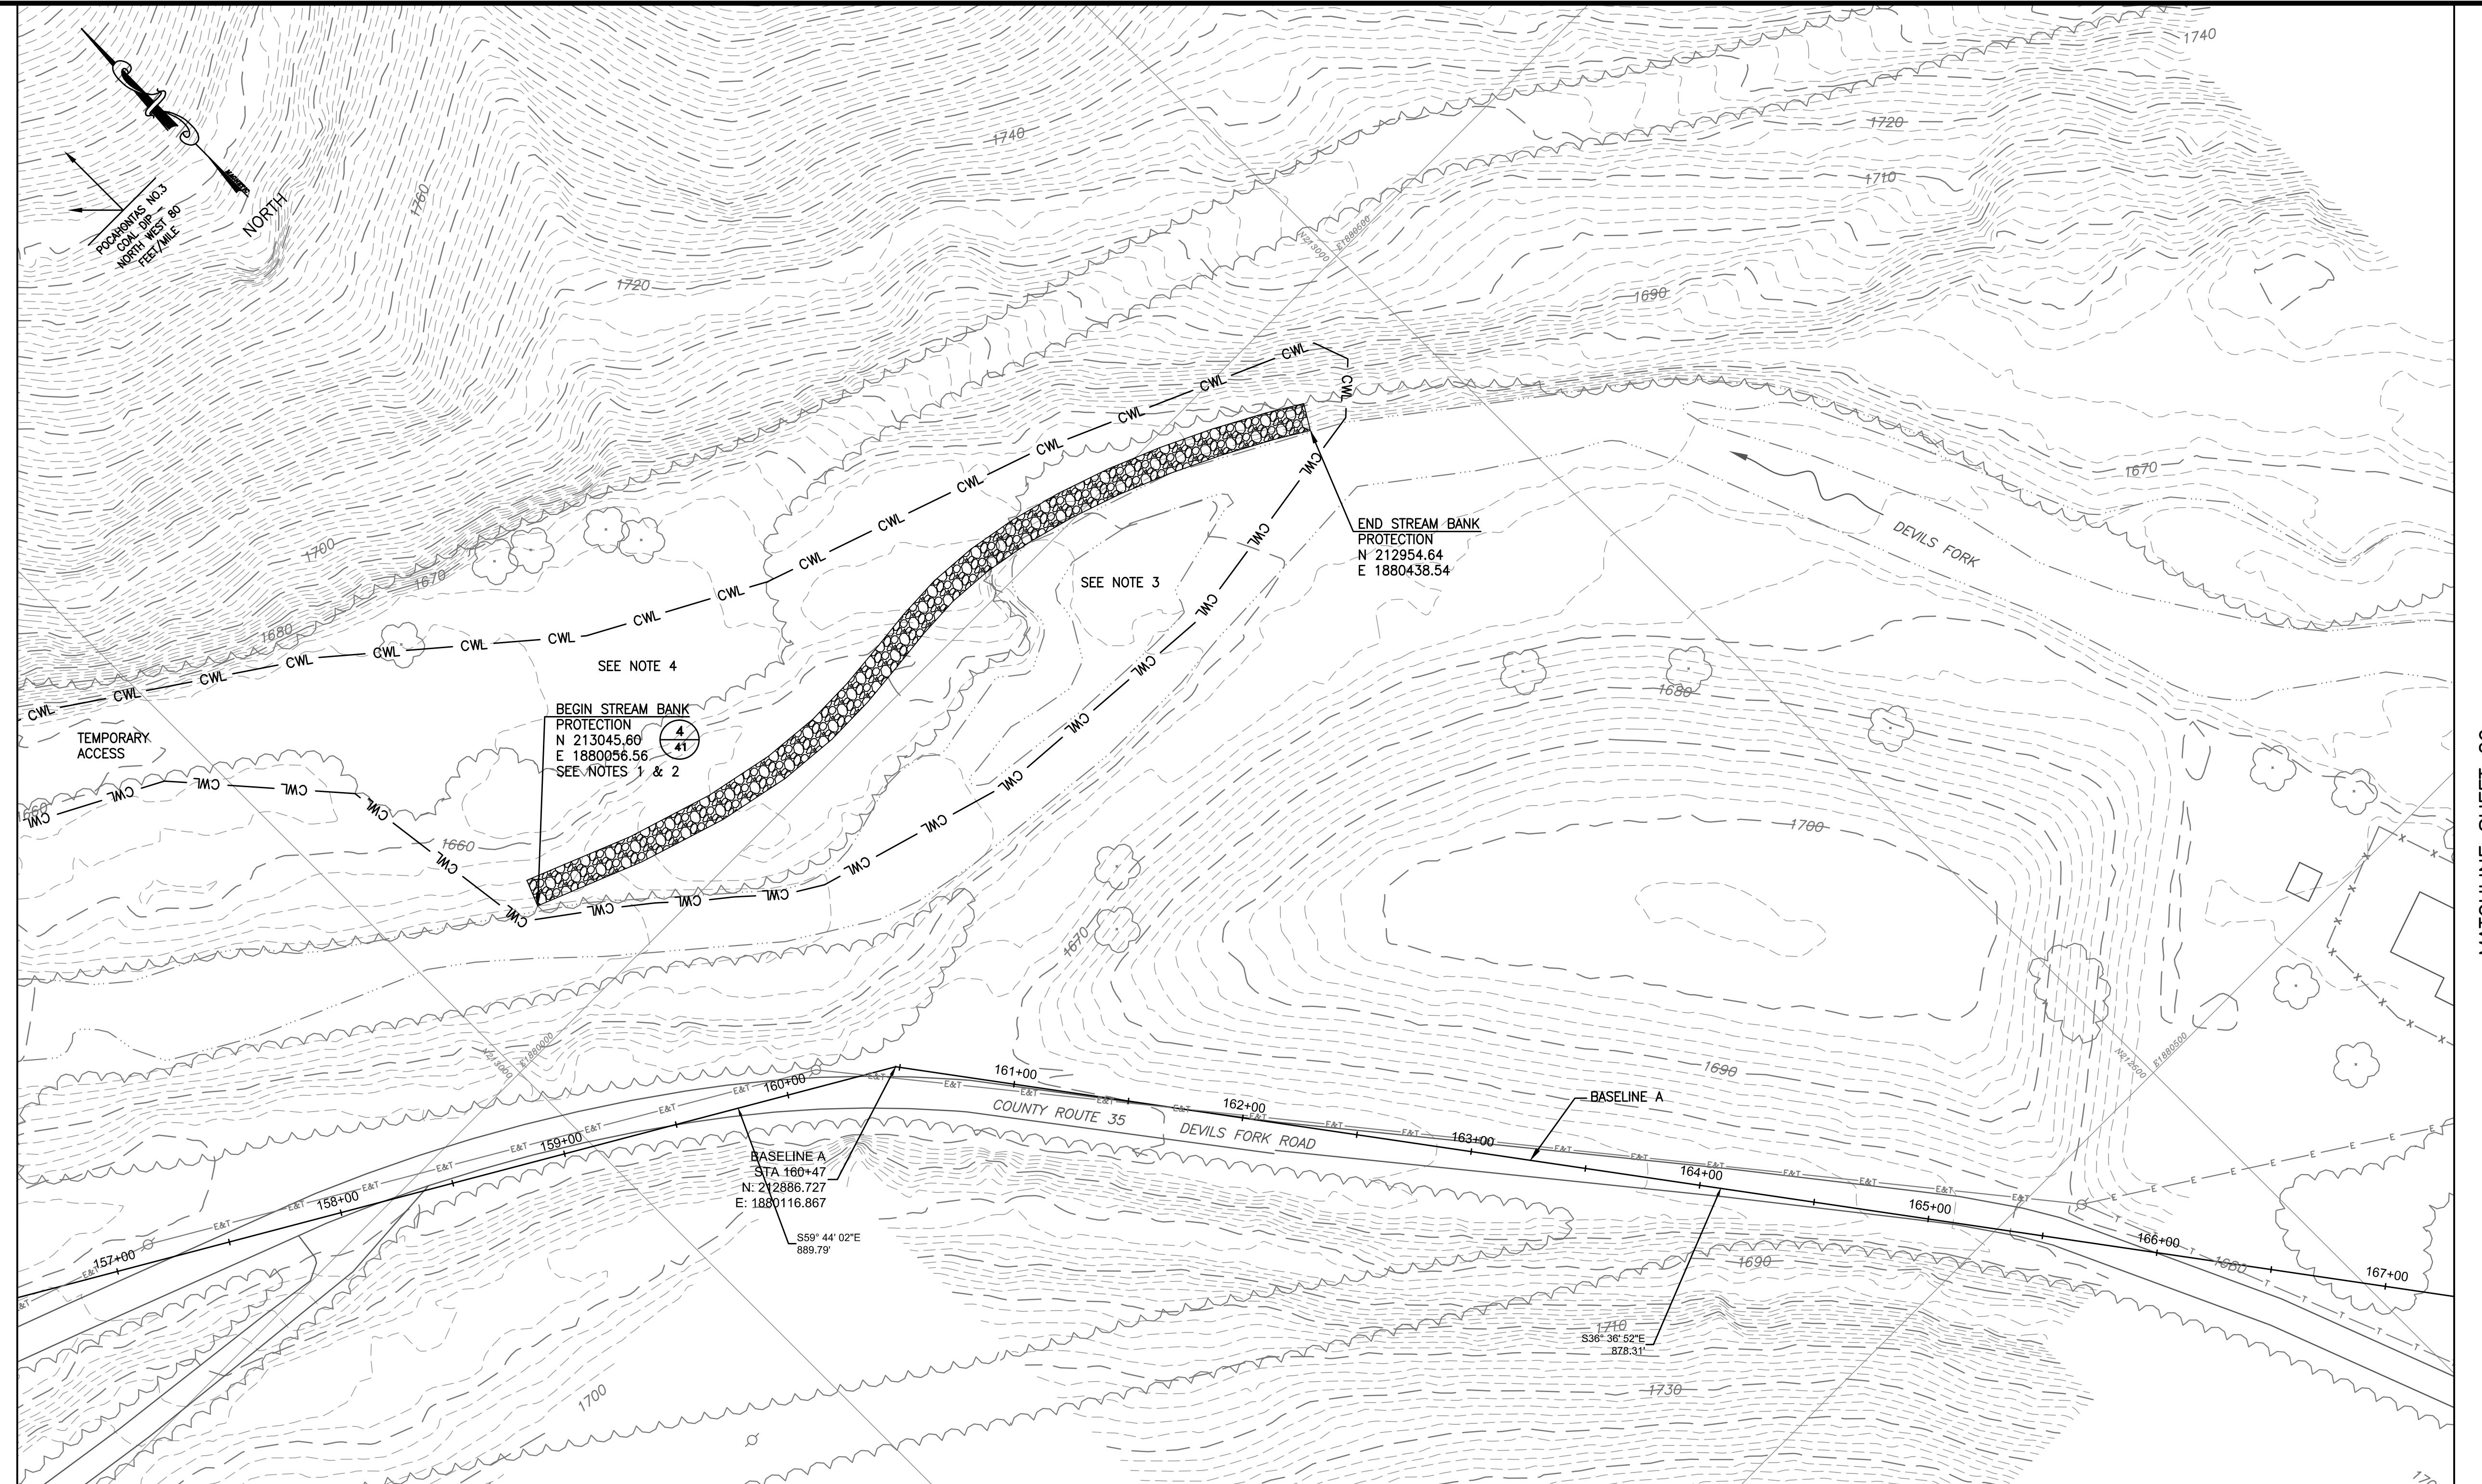

MATCHLINE SHEET 29

SCALE: 1" = 40'
DRAWING NUMBER
28

REV. NO.

DATE

DESCRIPTION

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RALEIGH COUNTY, WV

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PLOT SCALE:
1/1
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JTG
CS
APPROVED BY:
DATE: January 14, 2014
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AMIGO PORTALS

RALEIGH COUNTY, WV

PLOT SCALE: 1/1
DRAWN BY: TAC
CHECKED BY: JTG
APPROVED BY: CFS
DATE: January 14, 2014
PROJECT NUMBER: E130389

PROPOSED

REVISED

REV. NO. DATE DESCRIPTION

SCALE
1" = 40'

DRAWING NUMBER

30

BASELINE A
STA 187+00
N: 211002.597
E: 1881399.429

CONTROL POINT 14
N: 210811.291
E: 1881317.494
Z: 1713.33

LEGEND:

PROP. 10' CONTOURS	
EX. 10' CONTOURS	
EX. 2' CONTOURS	
EX. WATER LINE	
EX. FENCE LINE	
CONSTRUCTION WORK LIMITS	
EX. OVERHEAD ELECTRIC	
EX. CULVERT	
EX. TREE LINE	
EX. REFUSE LIMITS	
② 41 STRAW WATTLE	
EX. UTILITY POLE	
EX. LIGHT POLE	
EX. STRUCTURE	
MINE SEAL	
EX. TREE	
AGGREGATE PLACEMENT	
SPLASH PAD	
STREAM BANK PROTECTION	
EROSION CONTROL MATTING (ECM)	

MAPPING REFERENCE:
CONTROL SURVEY BY MEAD & HUNT DATED 4/19/13.

SCALE: 1" = 40'


DRAWING NUMBER

30

PORTAL SEAL TABLE			
PORTAL	TYPE	ELEVATION (FT)	CULVERT
17	LOW SUMP CONCRETE	-	-
18	LOW SUMP CONCRETE	-	-

- NOTES:
1. THE AREA INDICATED SHALL BE REVEGETATED USING SEED FOR HORSE PASTURE.
 2. POTENTIAL ACCESS ROUTES FOR PORTAL 14.
 3. FENCING FOR HORSES SHALL BE MAINTAINED AT ALL TIMES.
 4. THE CONTRACTOR SHALL REVIEW AND VERIFY THE LOAD CAPACITY FOR THE EXISTING PRIVATE BRIDGE ACROSS DEVIL'S FORK NEAR PORTAL 17. THE CONTRACTOR SHALL BE RESPONSIBLE FOR THE REPAIR OF ANY DAMAGE TO THE BRIDGE AS A RESULT OF UTILIZING THE BRIDGE FOR THE CONSTRUCTION. THIS SHALL BE CONSIDERED INCIDENTAL TO SITE PREPARATION.

MATCHLINE SHEET 29

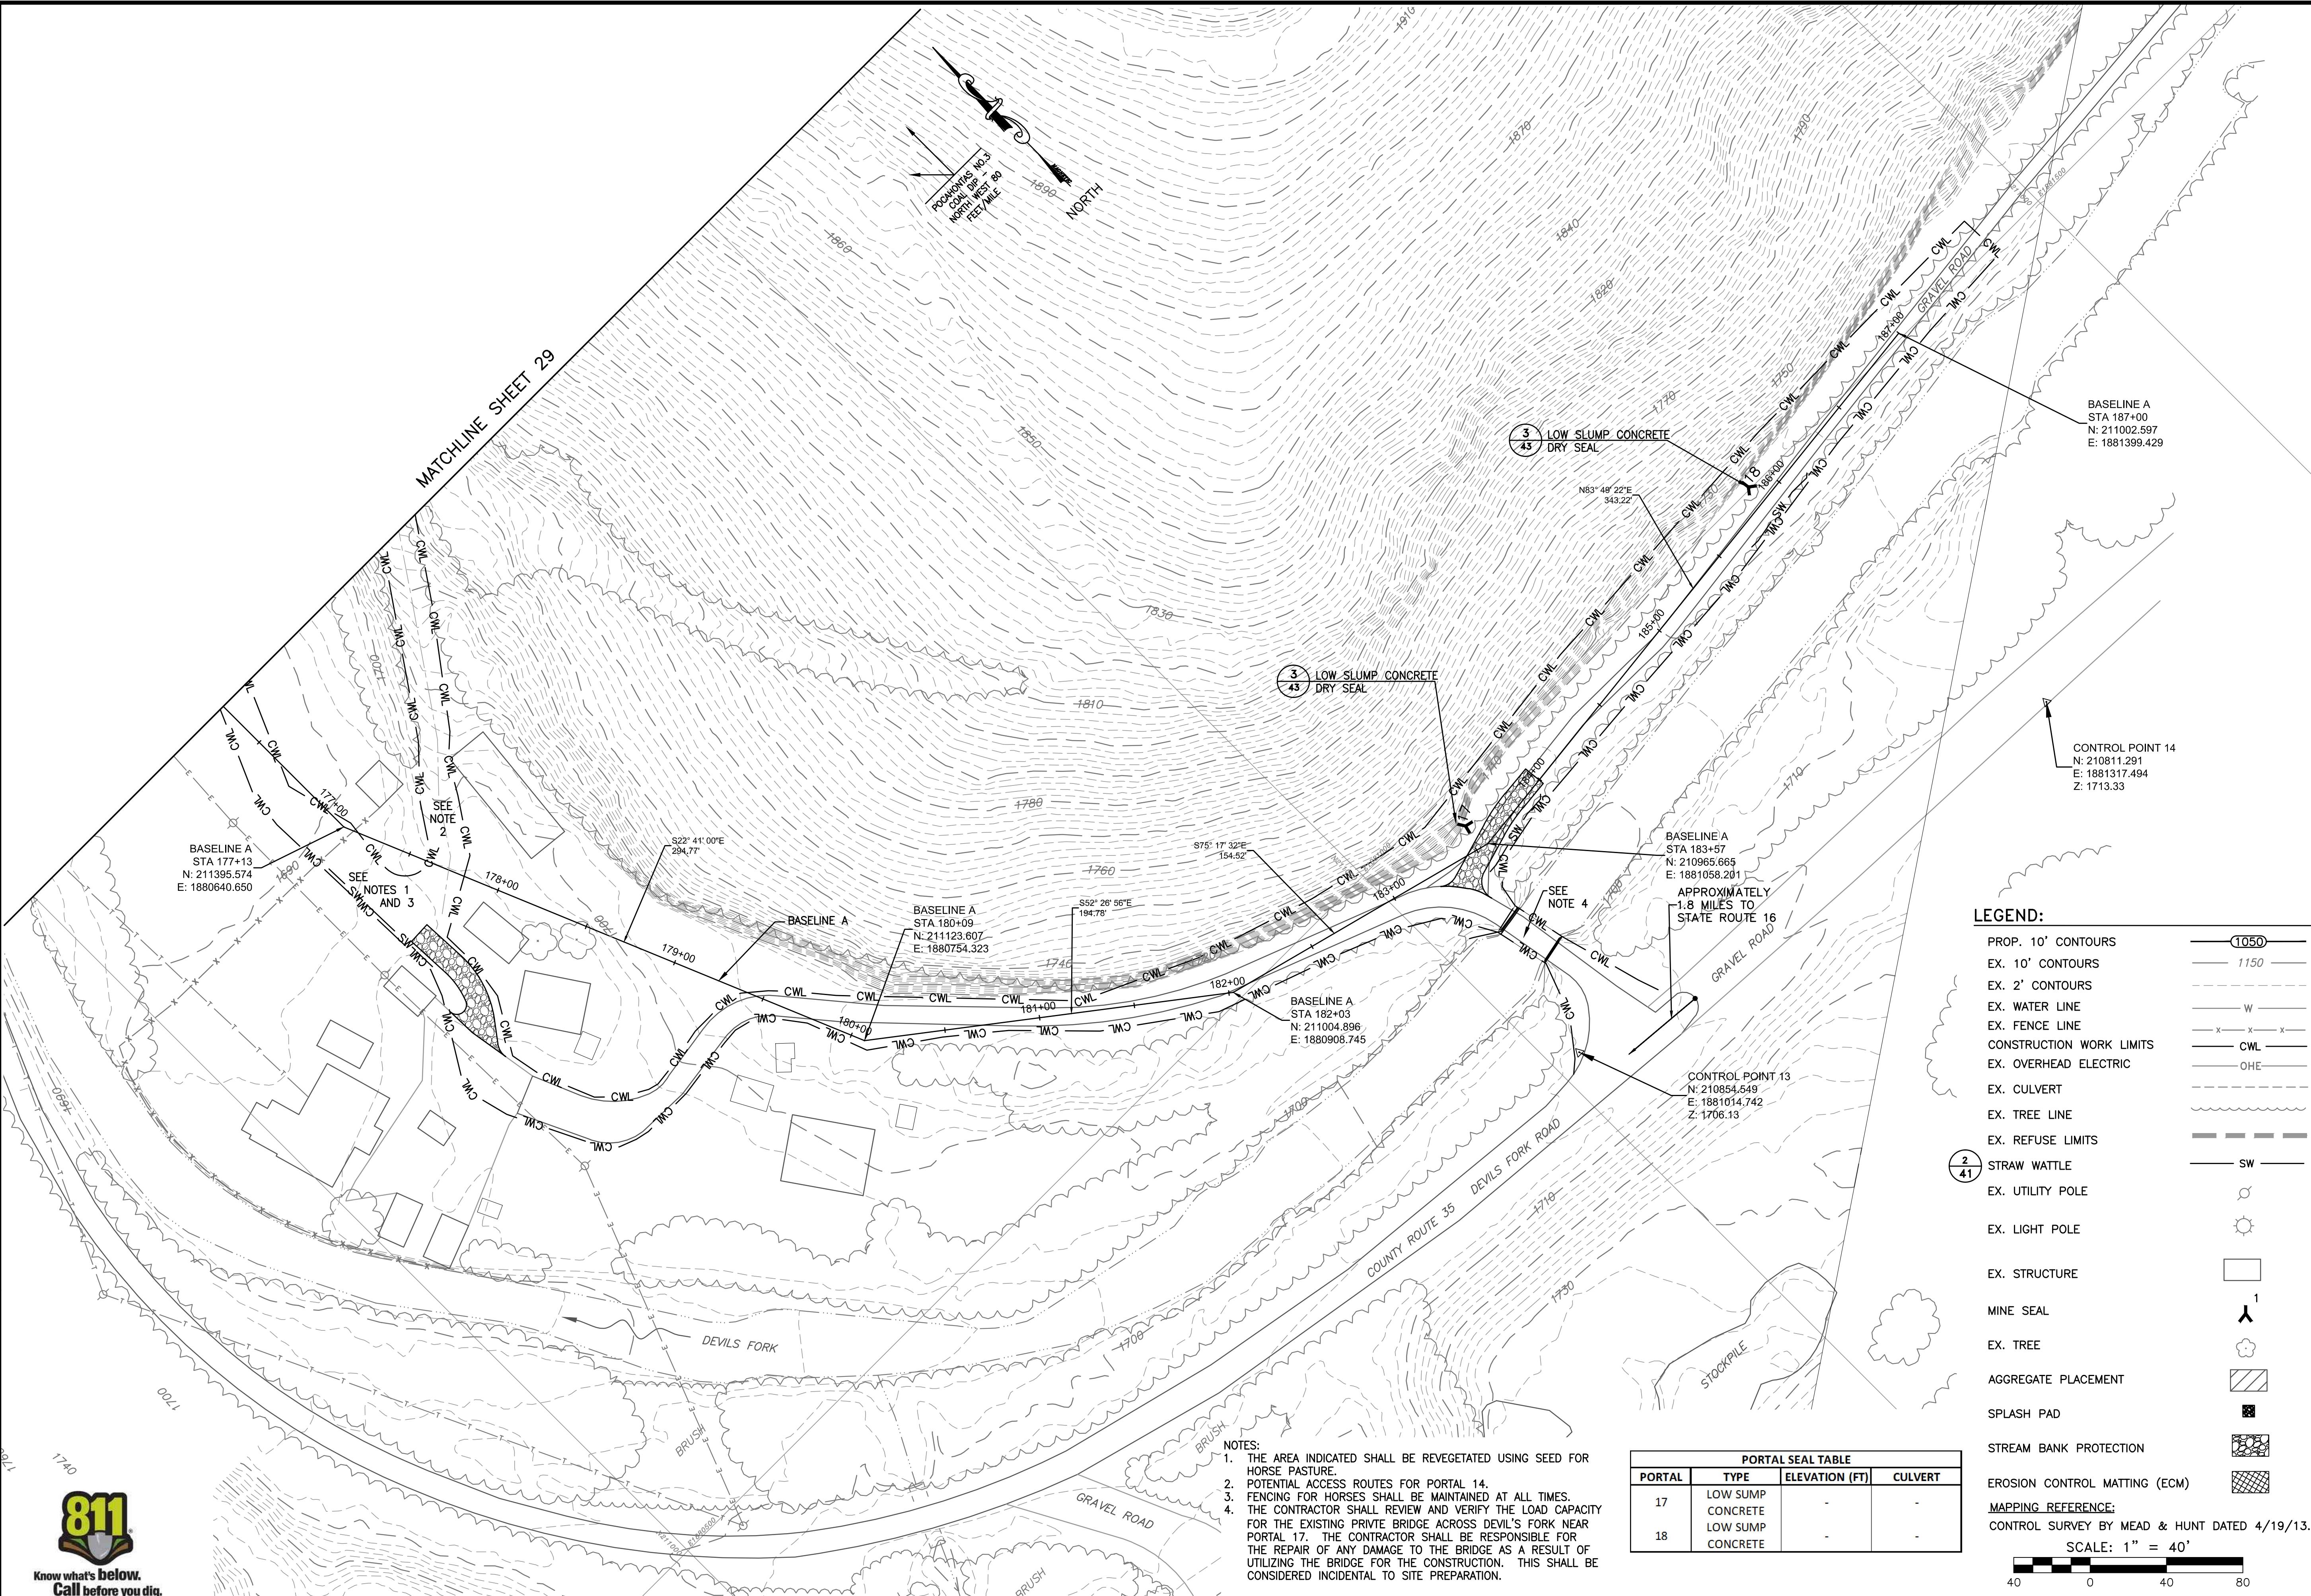

AMIGO PORTALS

RALEIGH COUNTY, WV

PLOT SCALE: 1/1
 DRAWN BY: TAC
 CHECKED BY: TAC
 APPROVED BY: JTG
 DATE: January 14, 2014
 PROJECT NUMBER: E130389


TAX MAP OVERLAY

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REV. NO. DATE DESCRIPTION

SCALE
 1" = 40'
 DRAWING NUMBER
 31

MATCHLINE SHEET 32

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AMIGO PORTALS

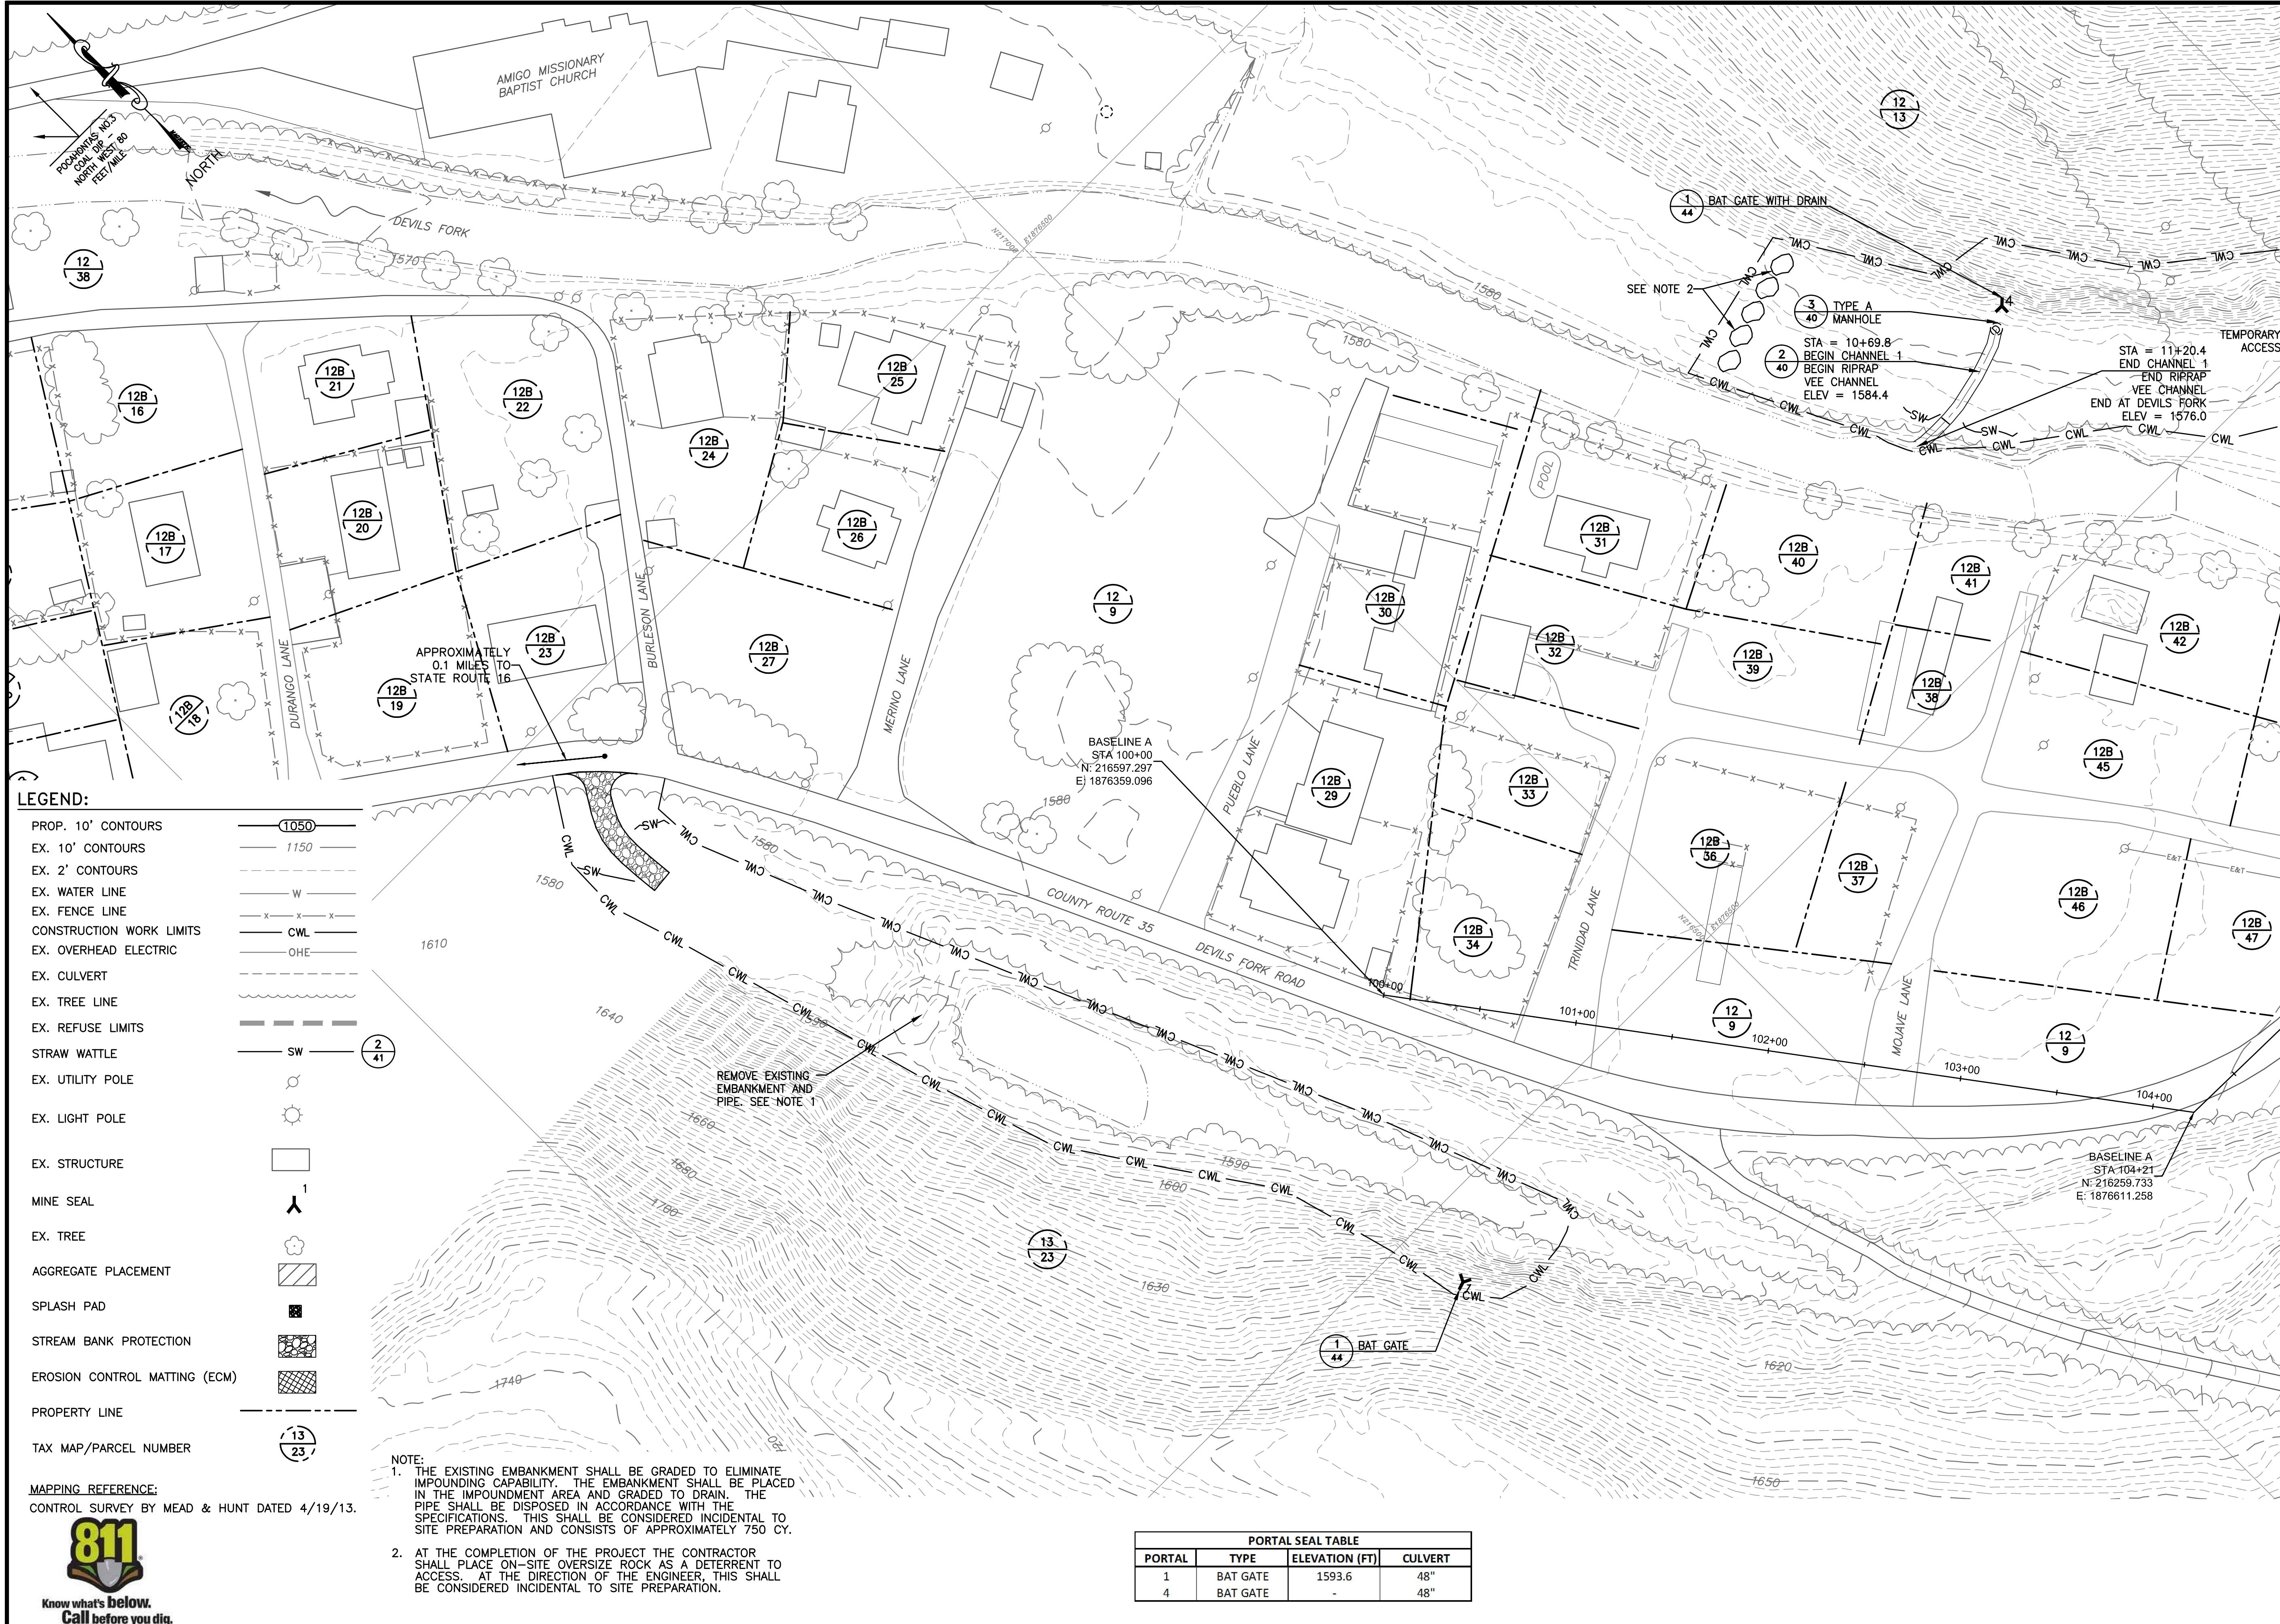RALEIGH COUNTY, WV

AMIGO PORTALS
RALEIGH COUNTY, WVPLOT SCALE:
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DRAWN BY:
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TAC
JTG
CS
APPROVED BY:
DATE: January 14, 2014
PROJECT NUMBER: E130389

TAX MAP OVERLAY

REV. NO.: DATE: DESCRIPTION

SCALE
1" = 40'
DRAWING NUMBER
32

LEGEND:

PROP. 10' CONTOURS	1050	MINE SEAL
EX. 10' CONTOURS	1150	EX. TREE
EX. 2' CONTOURS		AGGREGATE PLACEMENT
EX. WATER LINE		SPLASH PAD
EX. FENCE LINE		STREAM BANK PROTECTION
CONSTRUCTION WORK LIMITS		EROSION CONTROL MATTING (ECM)
EX. OVERHEAD ELECTRIC		PROPERTY LINE
EX. CULVERT		TAX MAP/PARCEL NUMBER
EX. TREE LINE		
EX. REFUSE LIMITS		
STRAW WATTLE	SW	
EX. UTILITY POLE		
EX. LIGHT POLE		
EX. STRUCTURE		


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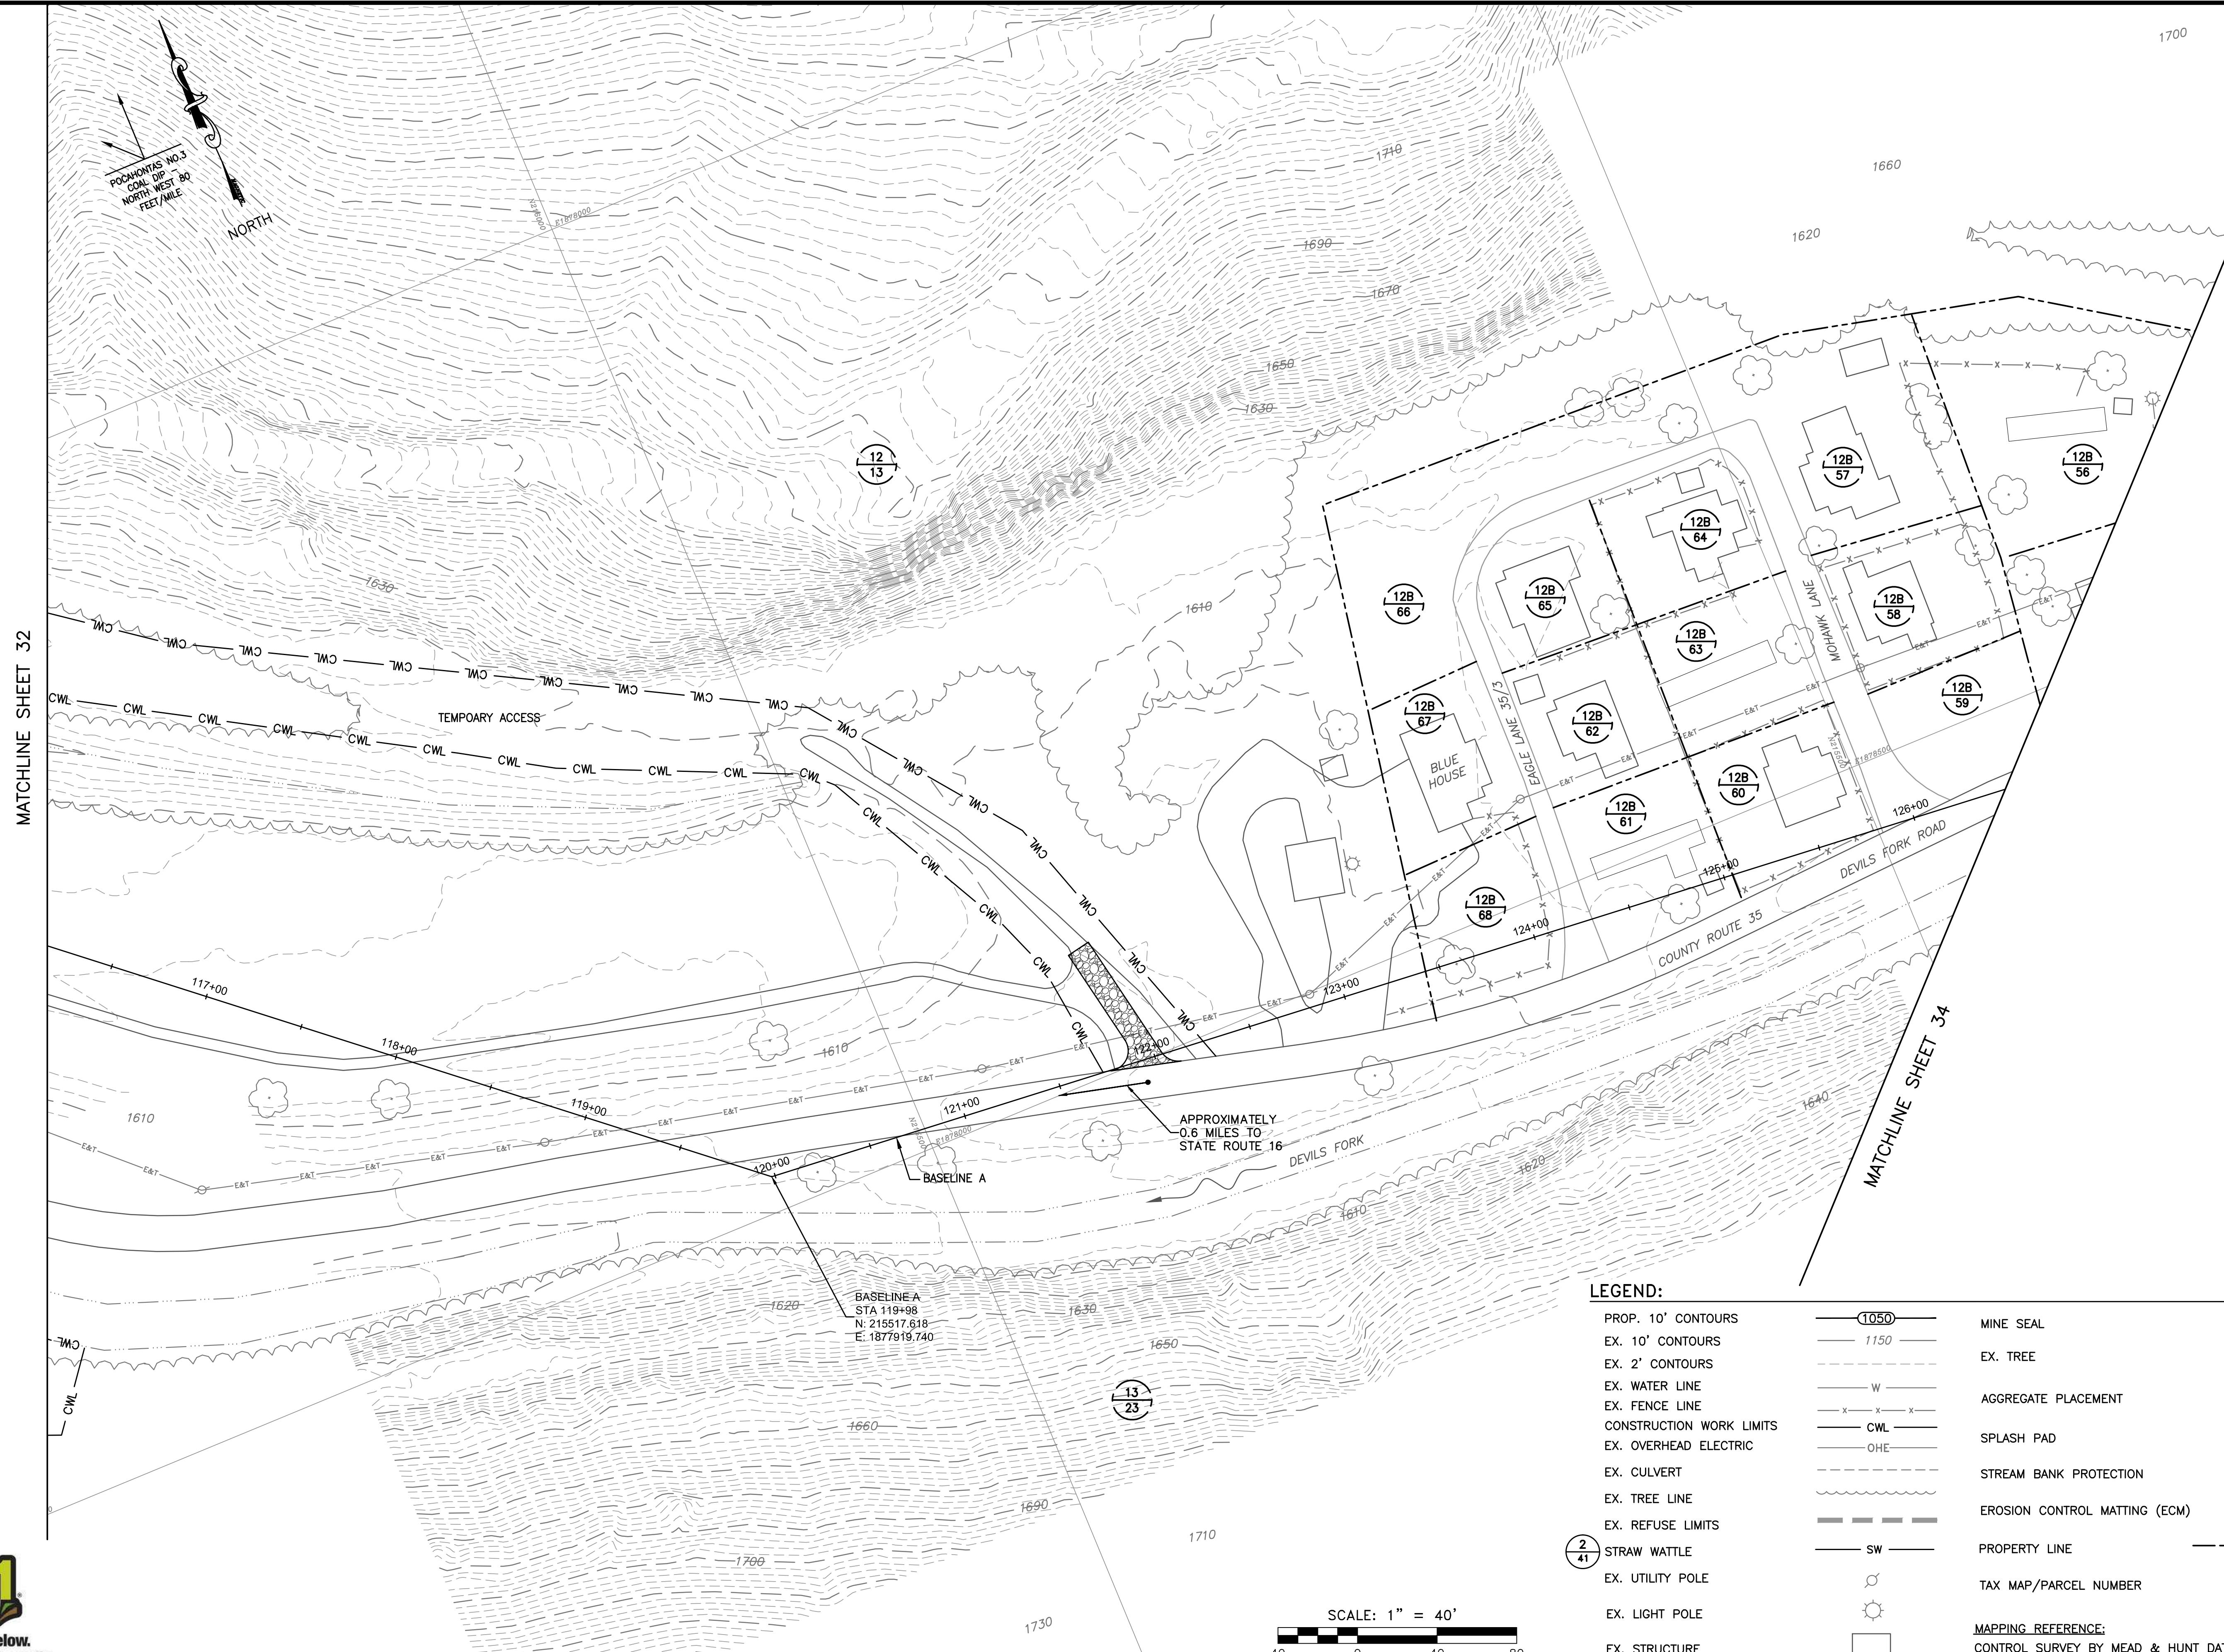
CONTROL SURVEY BY MEAD & HUNT DATED 4/19/13.



MATCHLINE SHEET 33

MATCHLINE SHEET 31



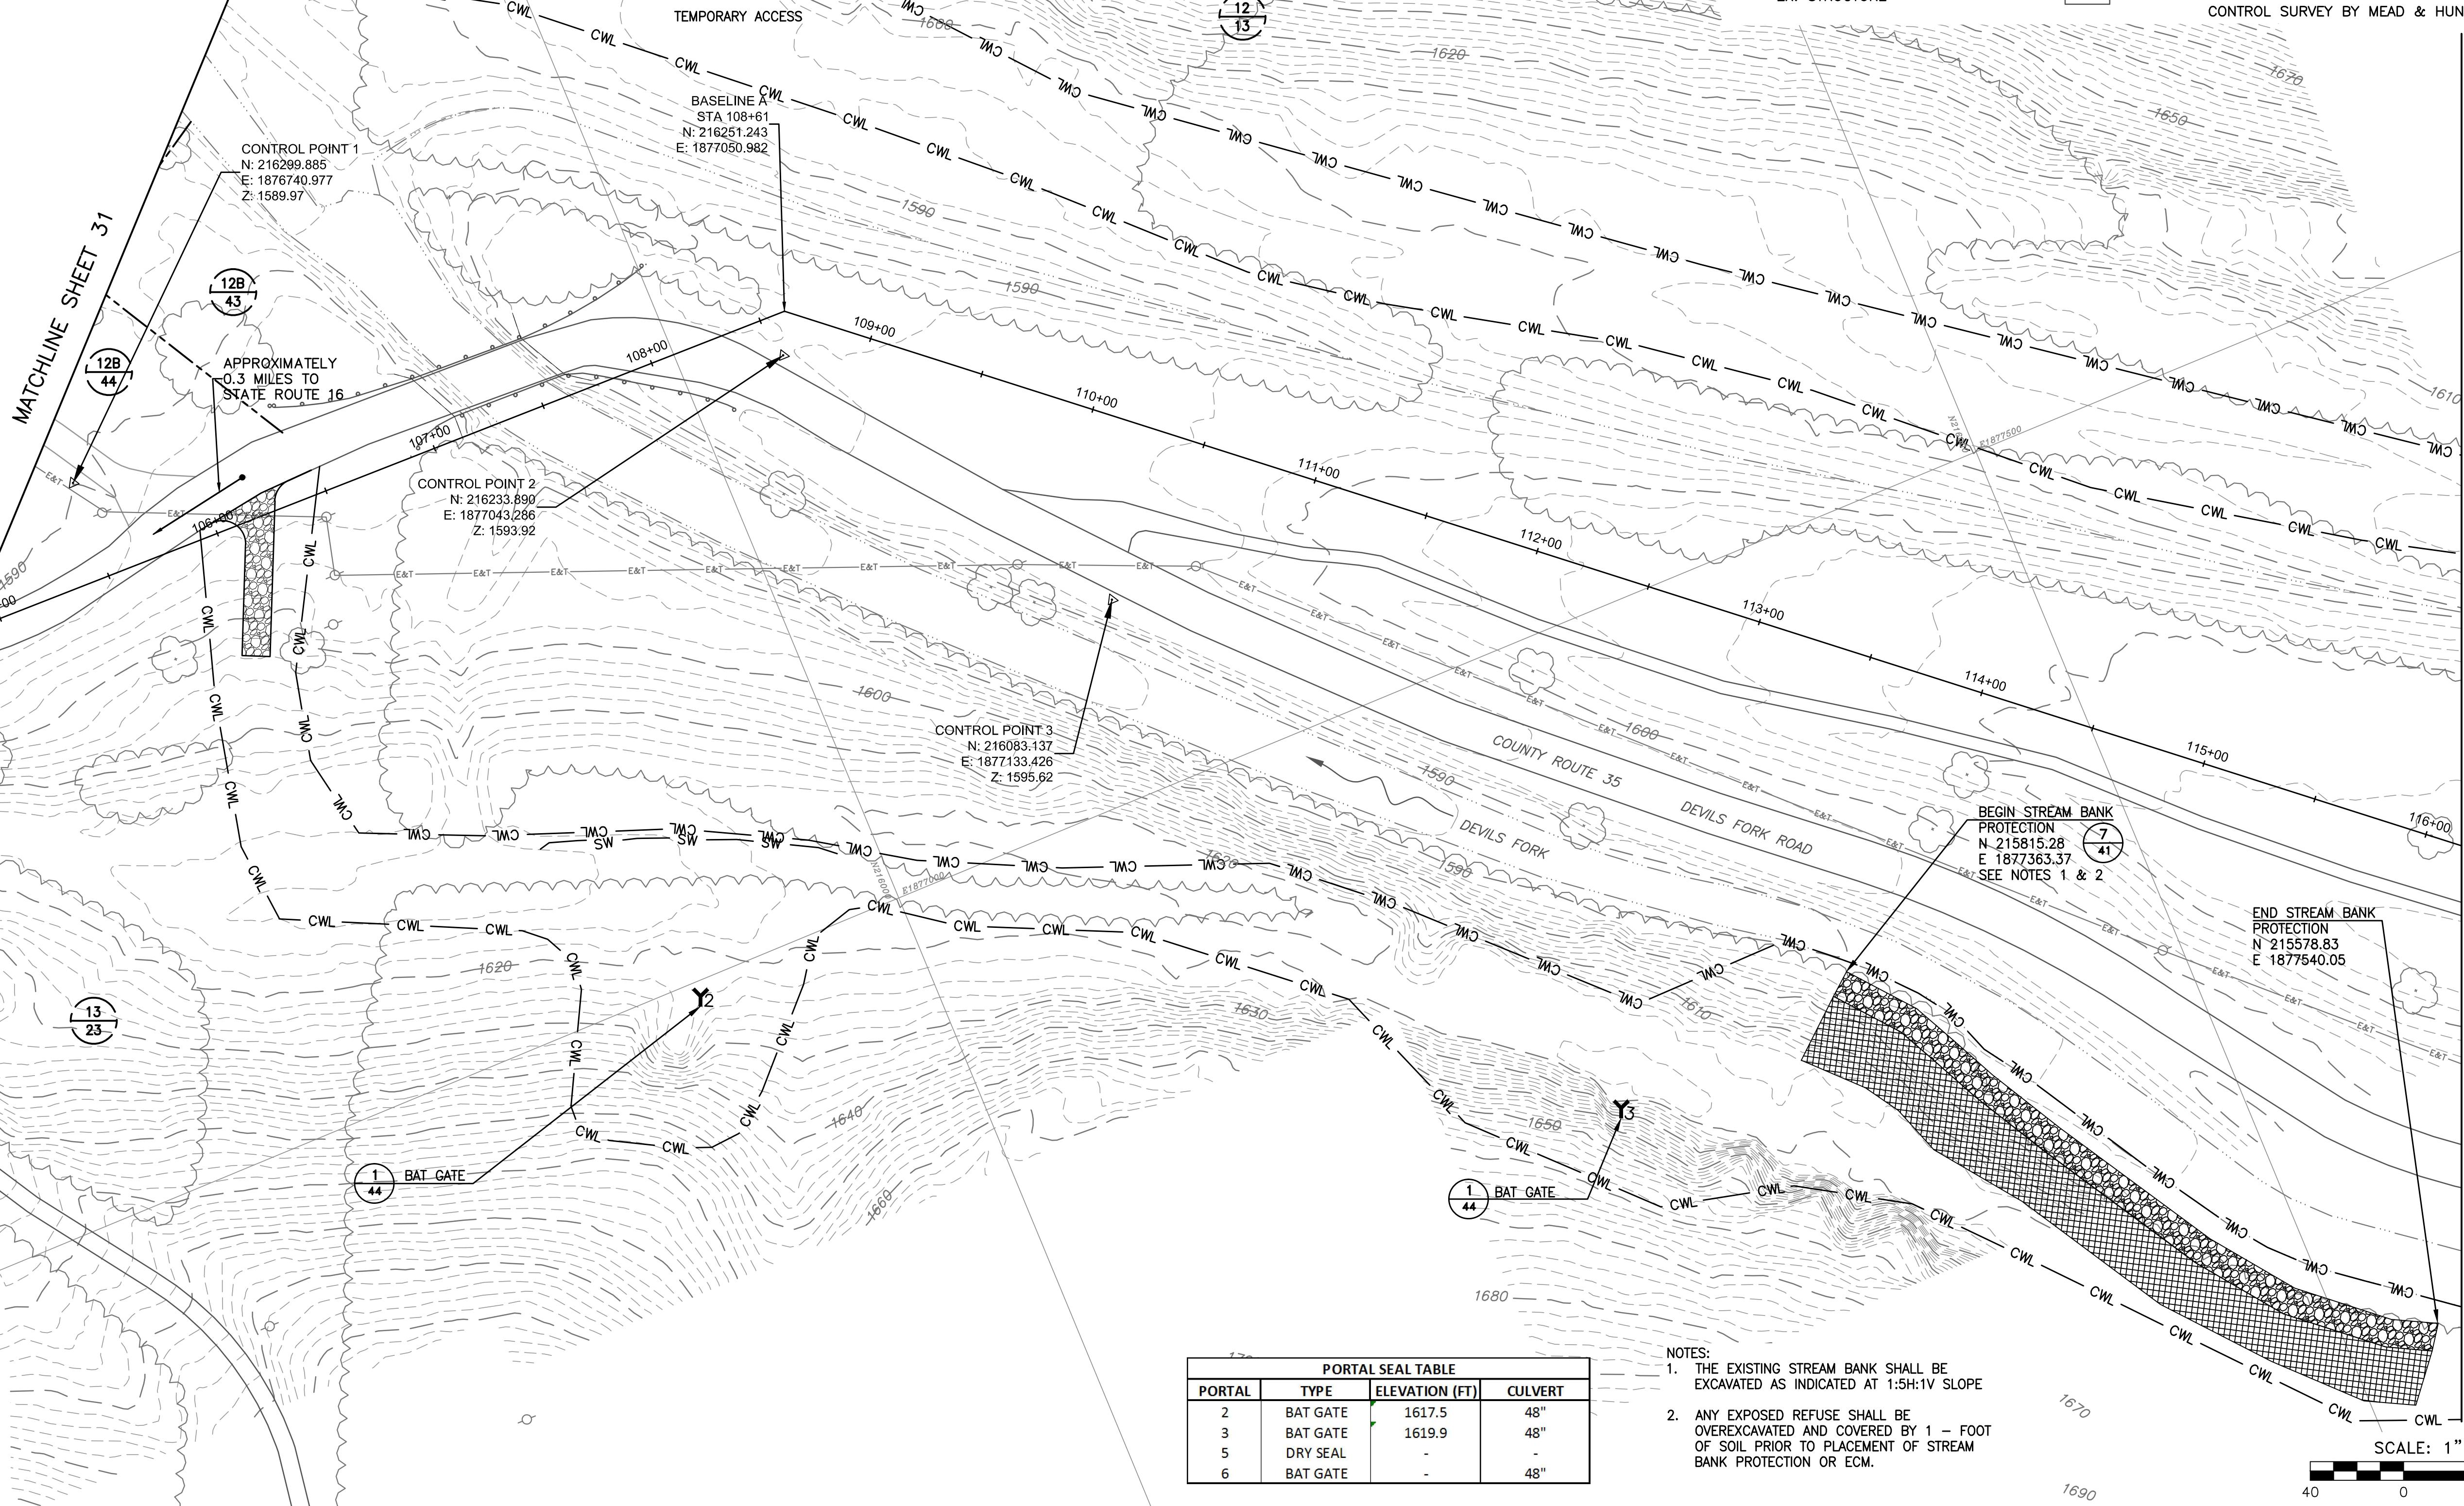

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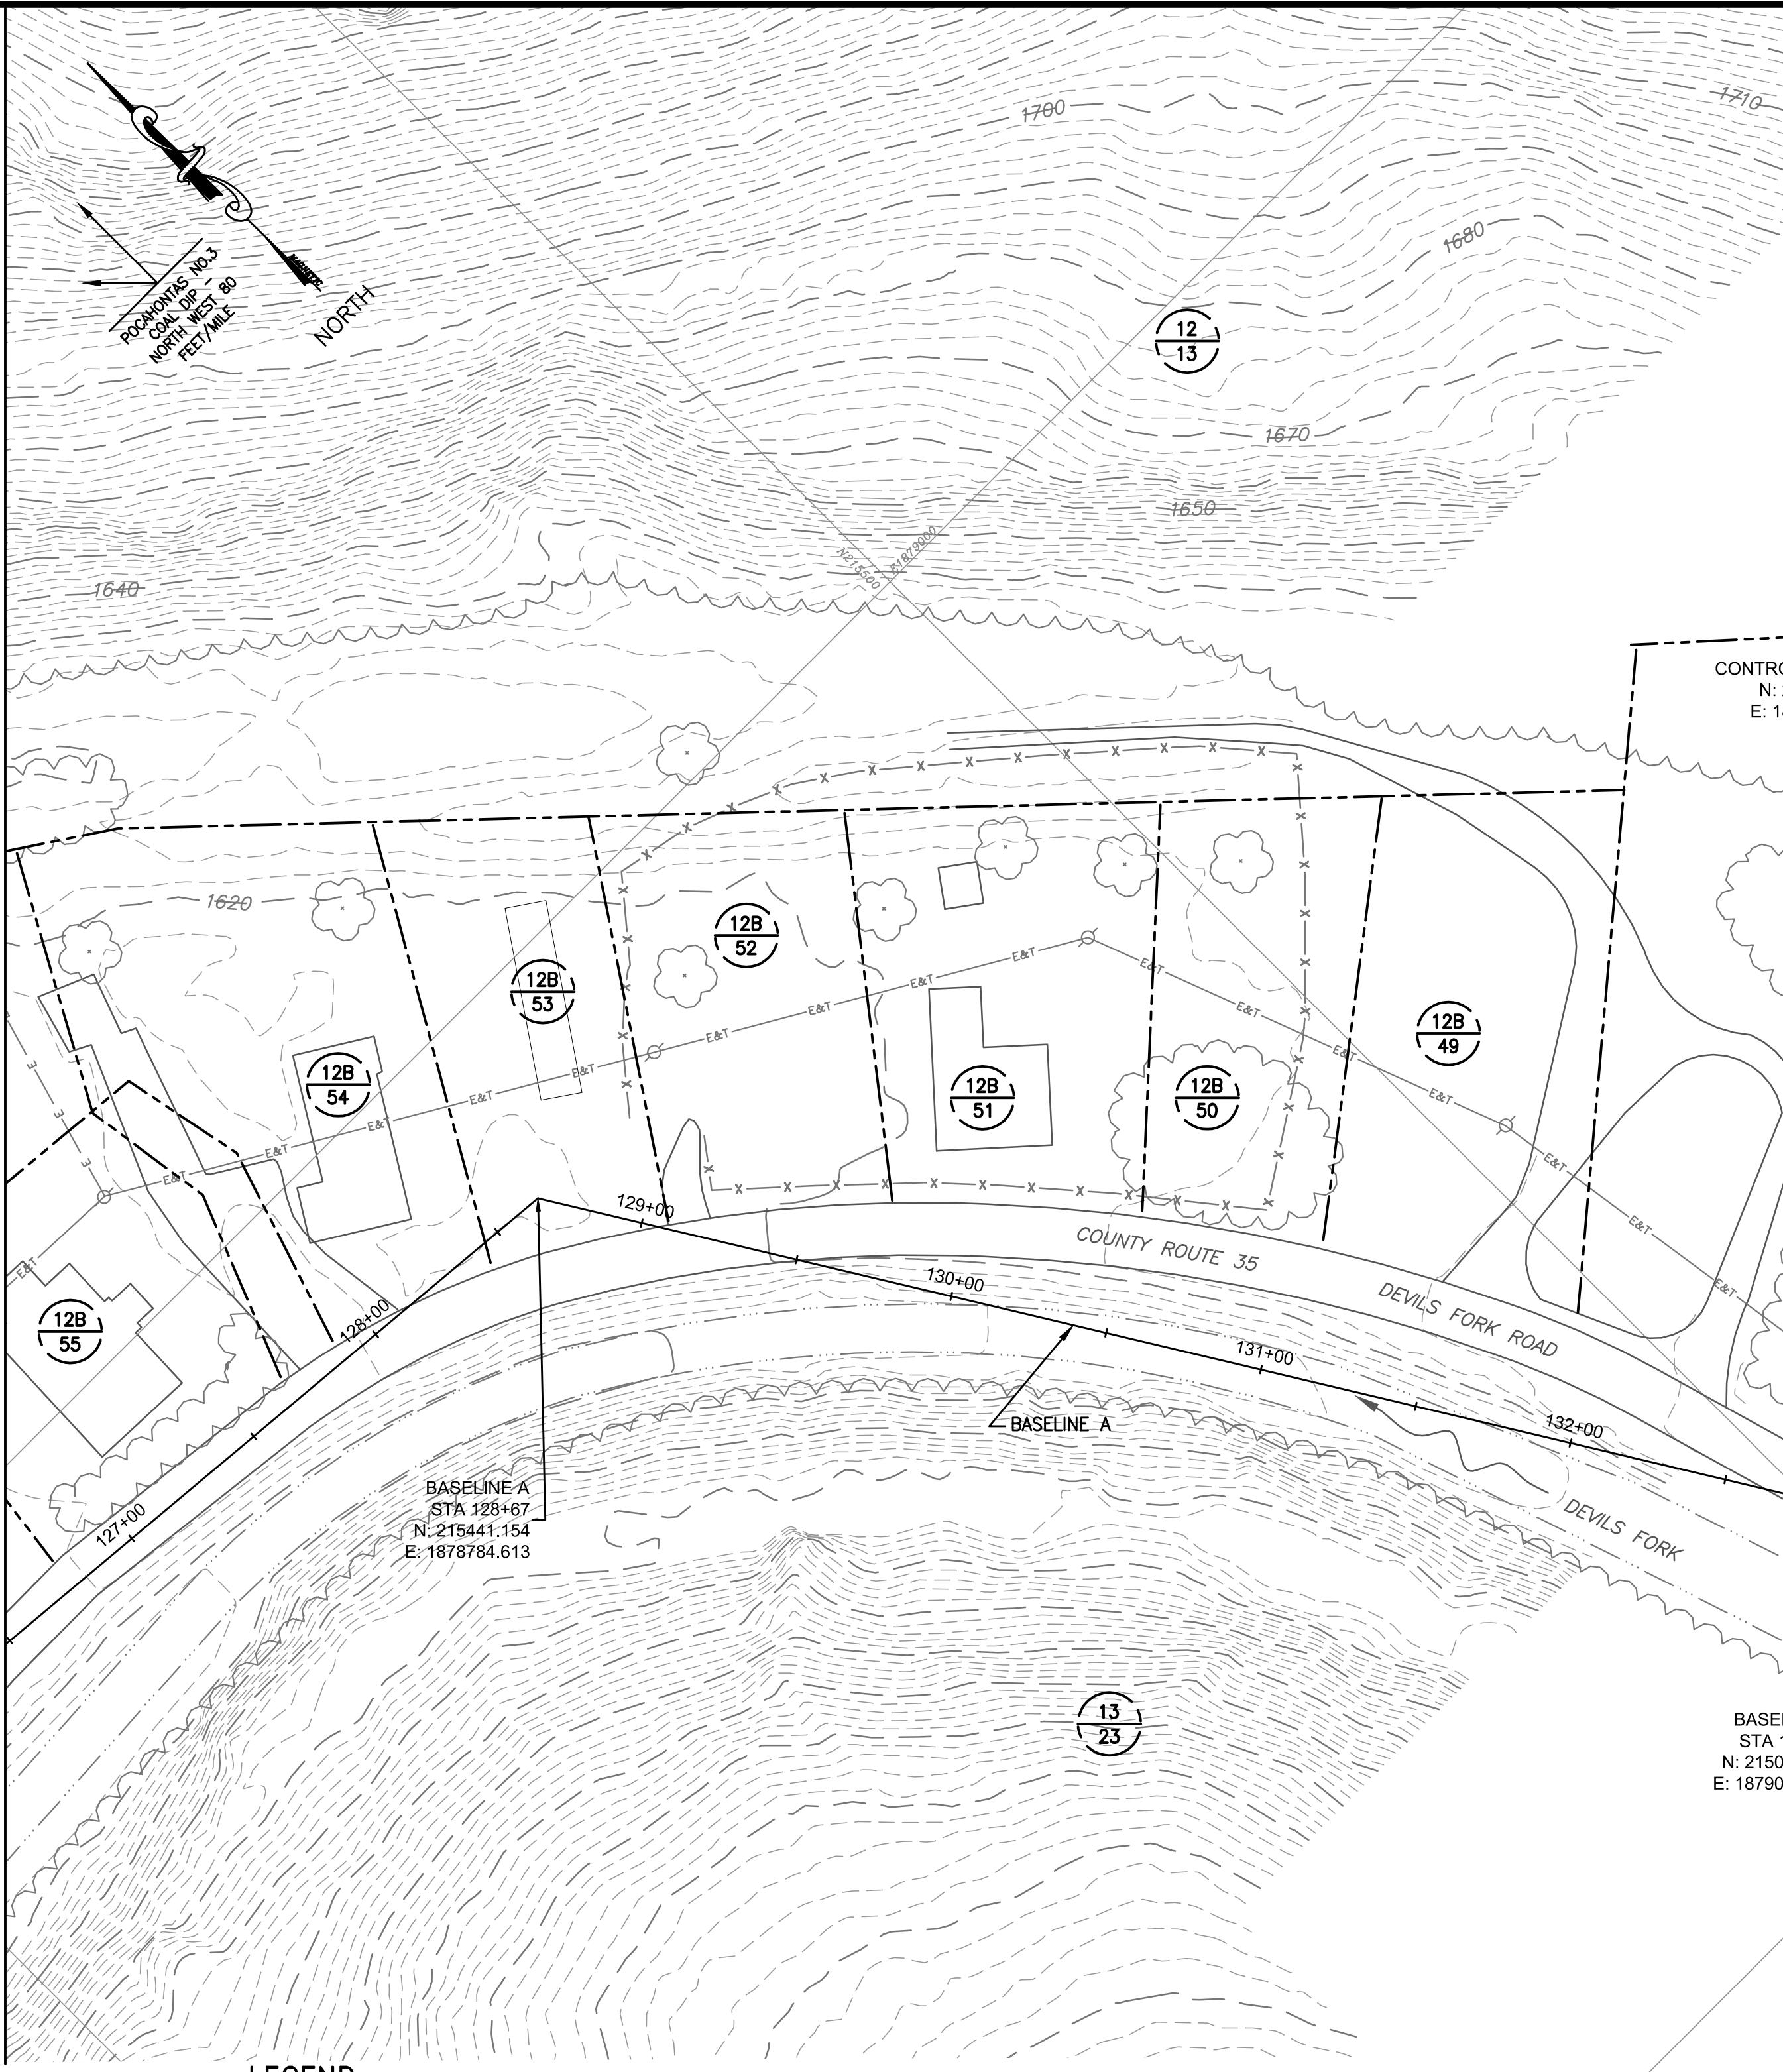
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REV NO. D

1”
DRAWING

ALE
: 40'
NUMBER
3

MATCHLINE SHEET 33



2 41	EX. UTILITY POLE	○
EX. LIGHT POLE	○	○
EX. STRUCTURE	□	□
MAPPING REFERENCE:		
CONTROL SURVEY BY MEAD & HUNT DATED 4/19/13.	13 23	

PORTAL SEAL TABLE			
PORTAL	TYPE	ELEVATION (FT)	CULVERT
7	BAT GATE	1626.6	48"
8	BAT GATE	-	48"

GAI CAD FILE PATH: Z:\ComDev\2013\1130389.00 - WVDEP-AML Amigo Portals\Cap\Conceptual Set\WVDEP-AML Amigo Portals - Tax Map.dwg PLOTTED ON: 1/15/2014 2:15 PM PLOTTED BY: Jason Green PEN STYLE: HP DESIGN JET 1050C STANDARD.ctb

SCALE: 1" = 40'
DRAWING NUMBER
REV. NO. DATE DESCRIPTION
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34

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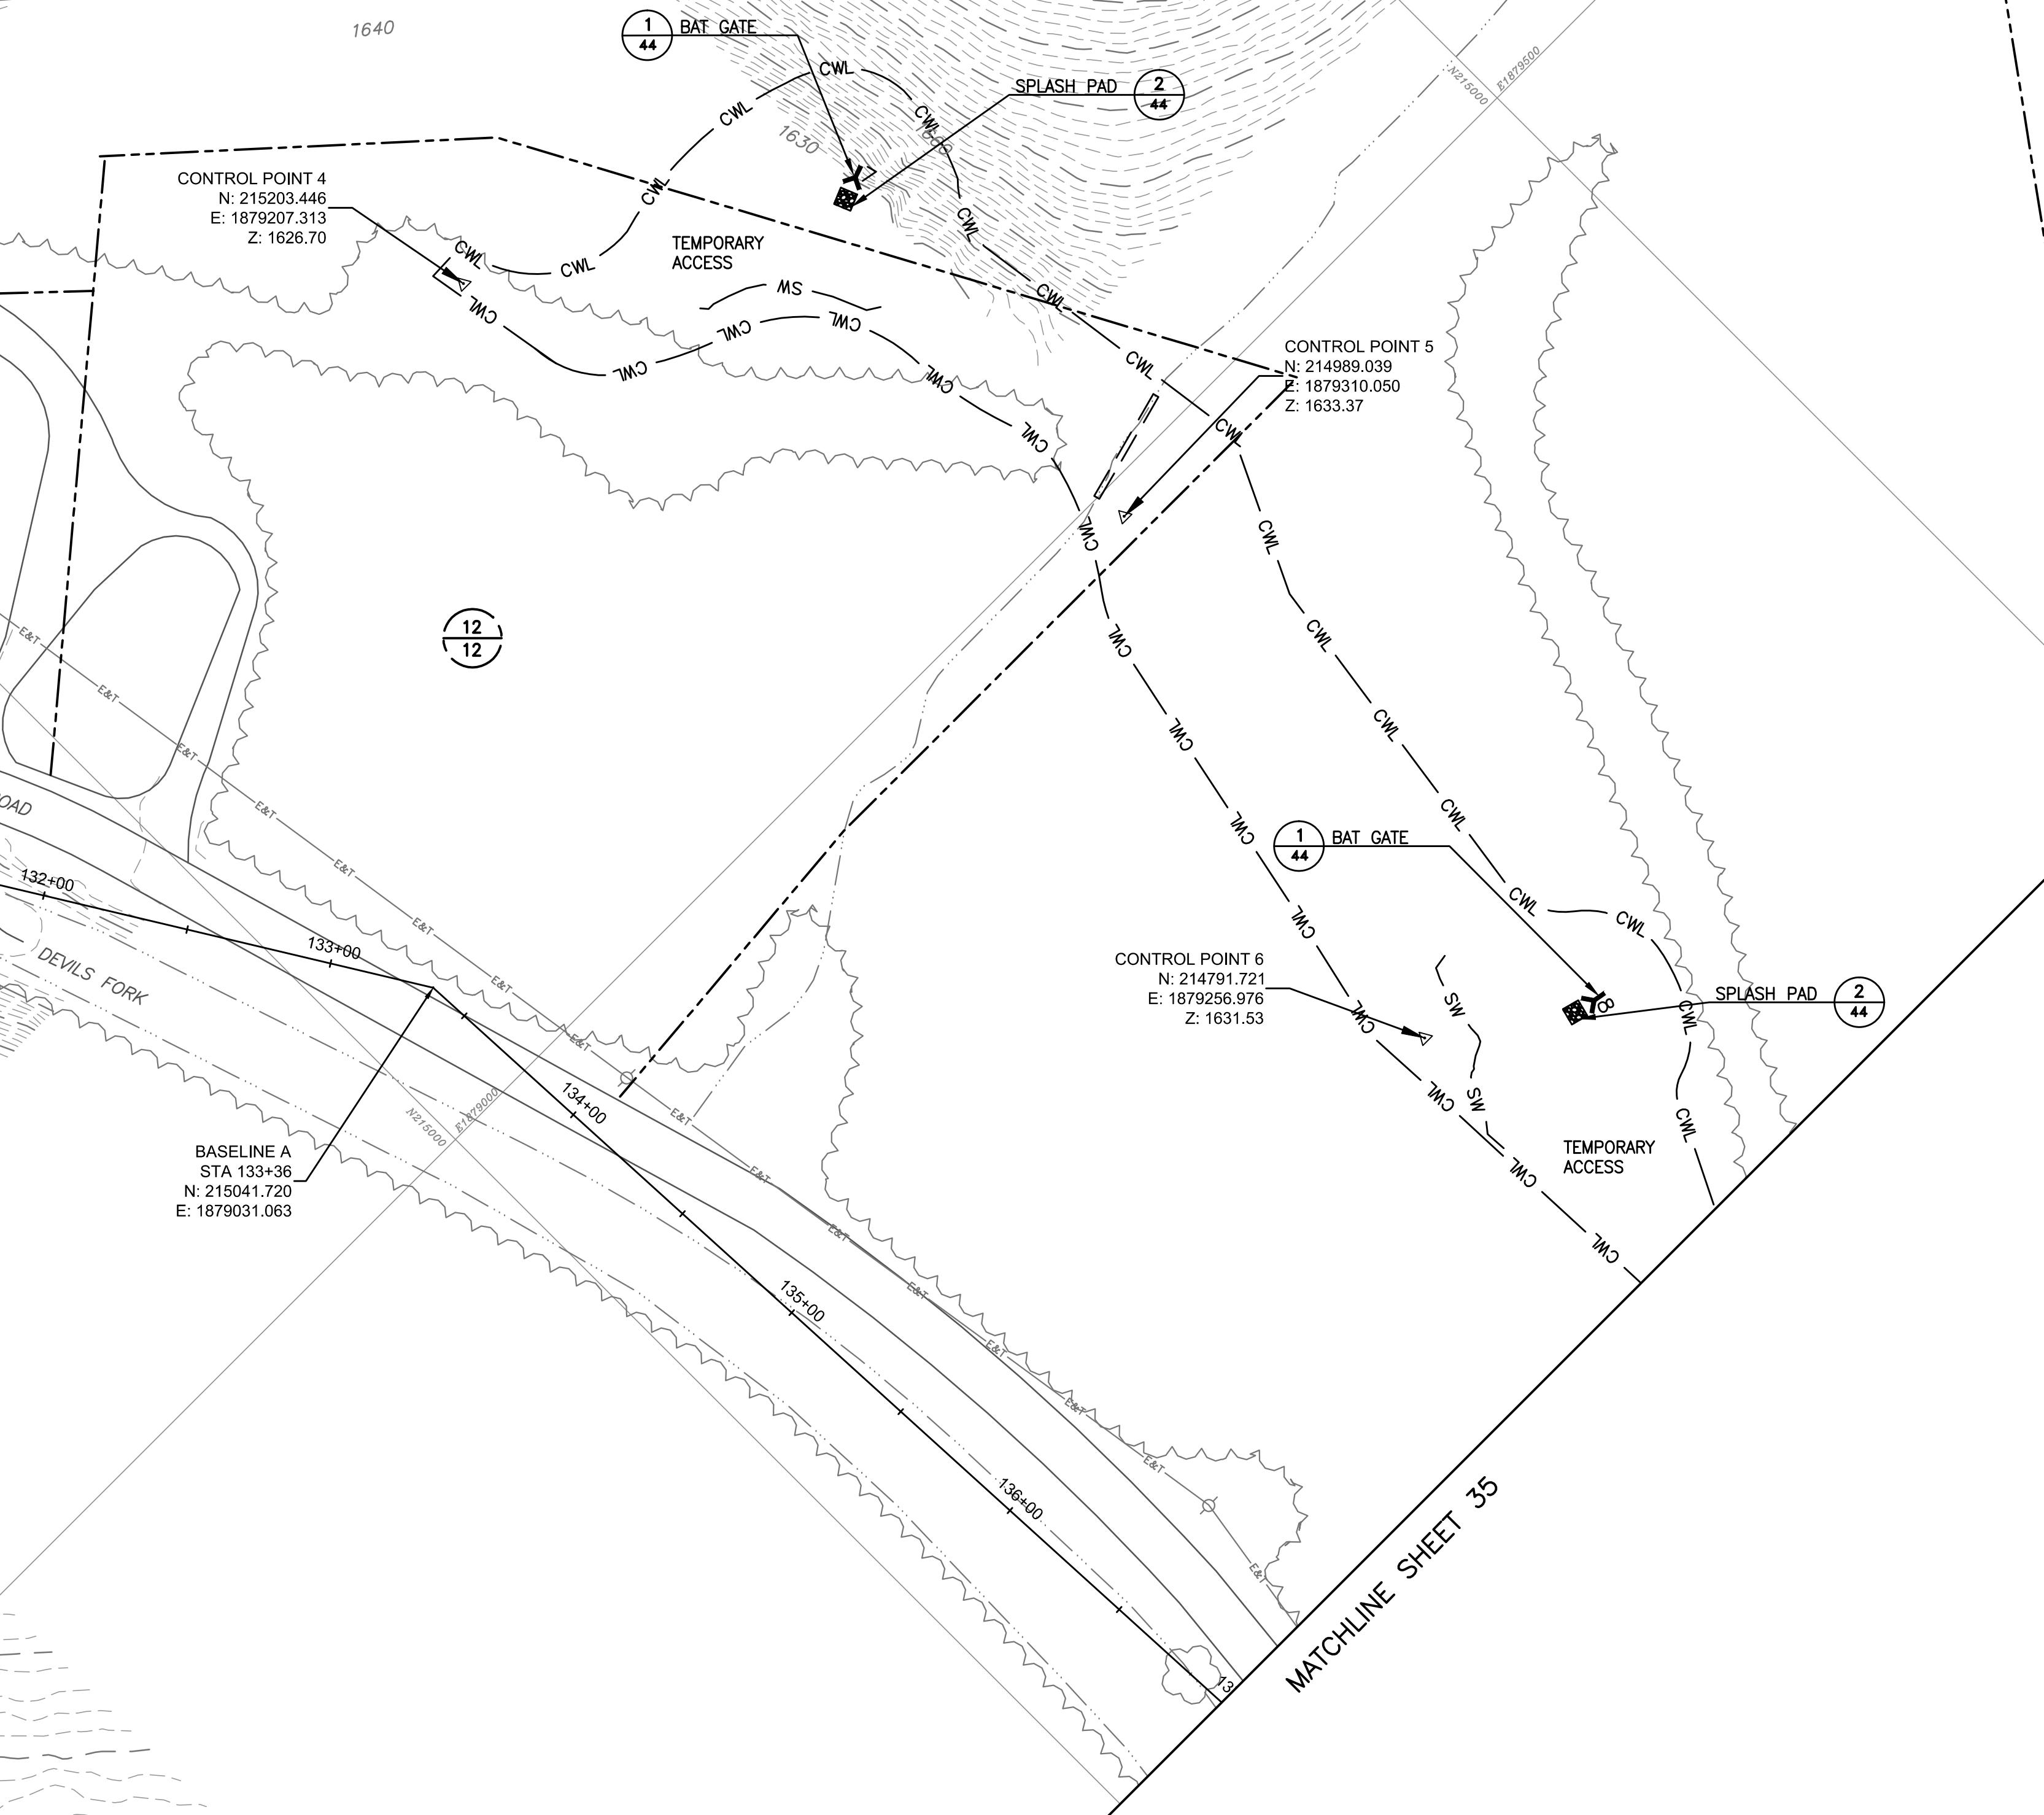
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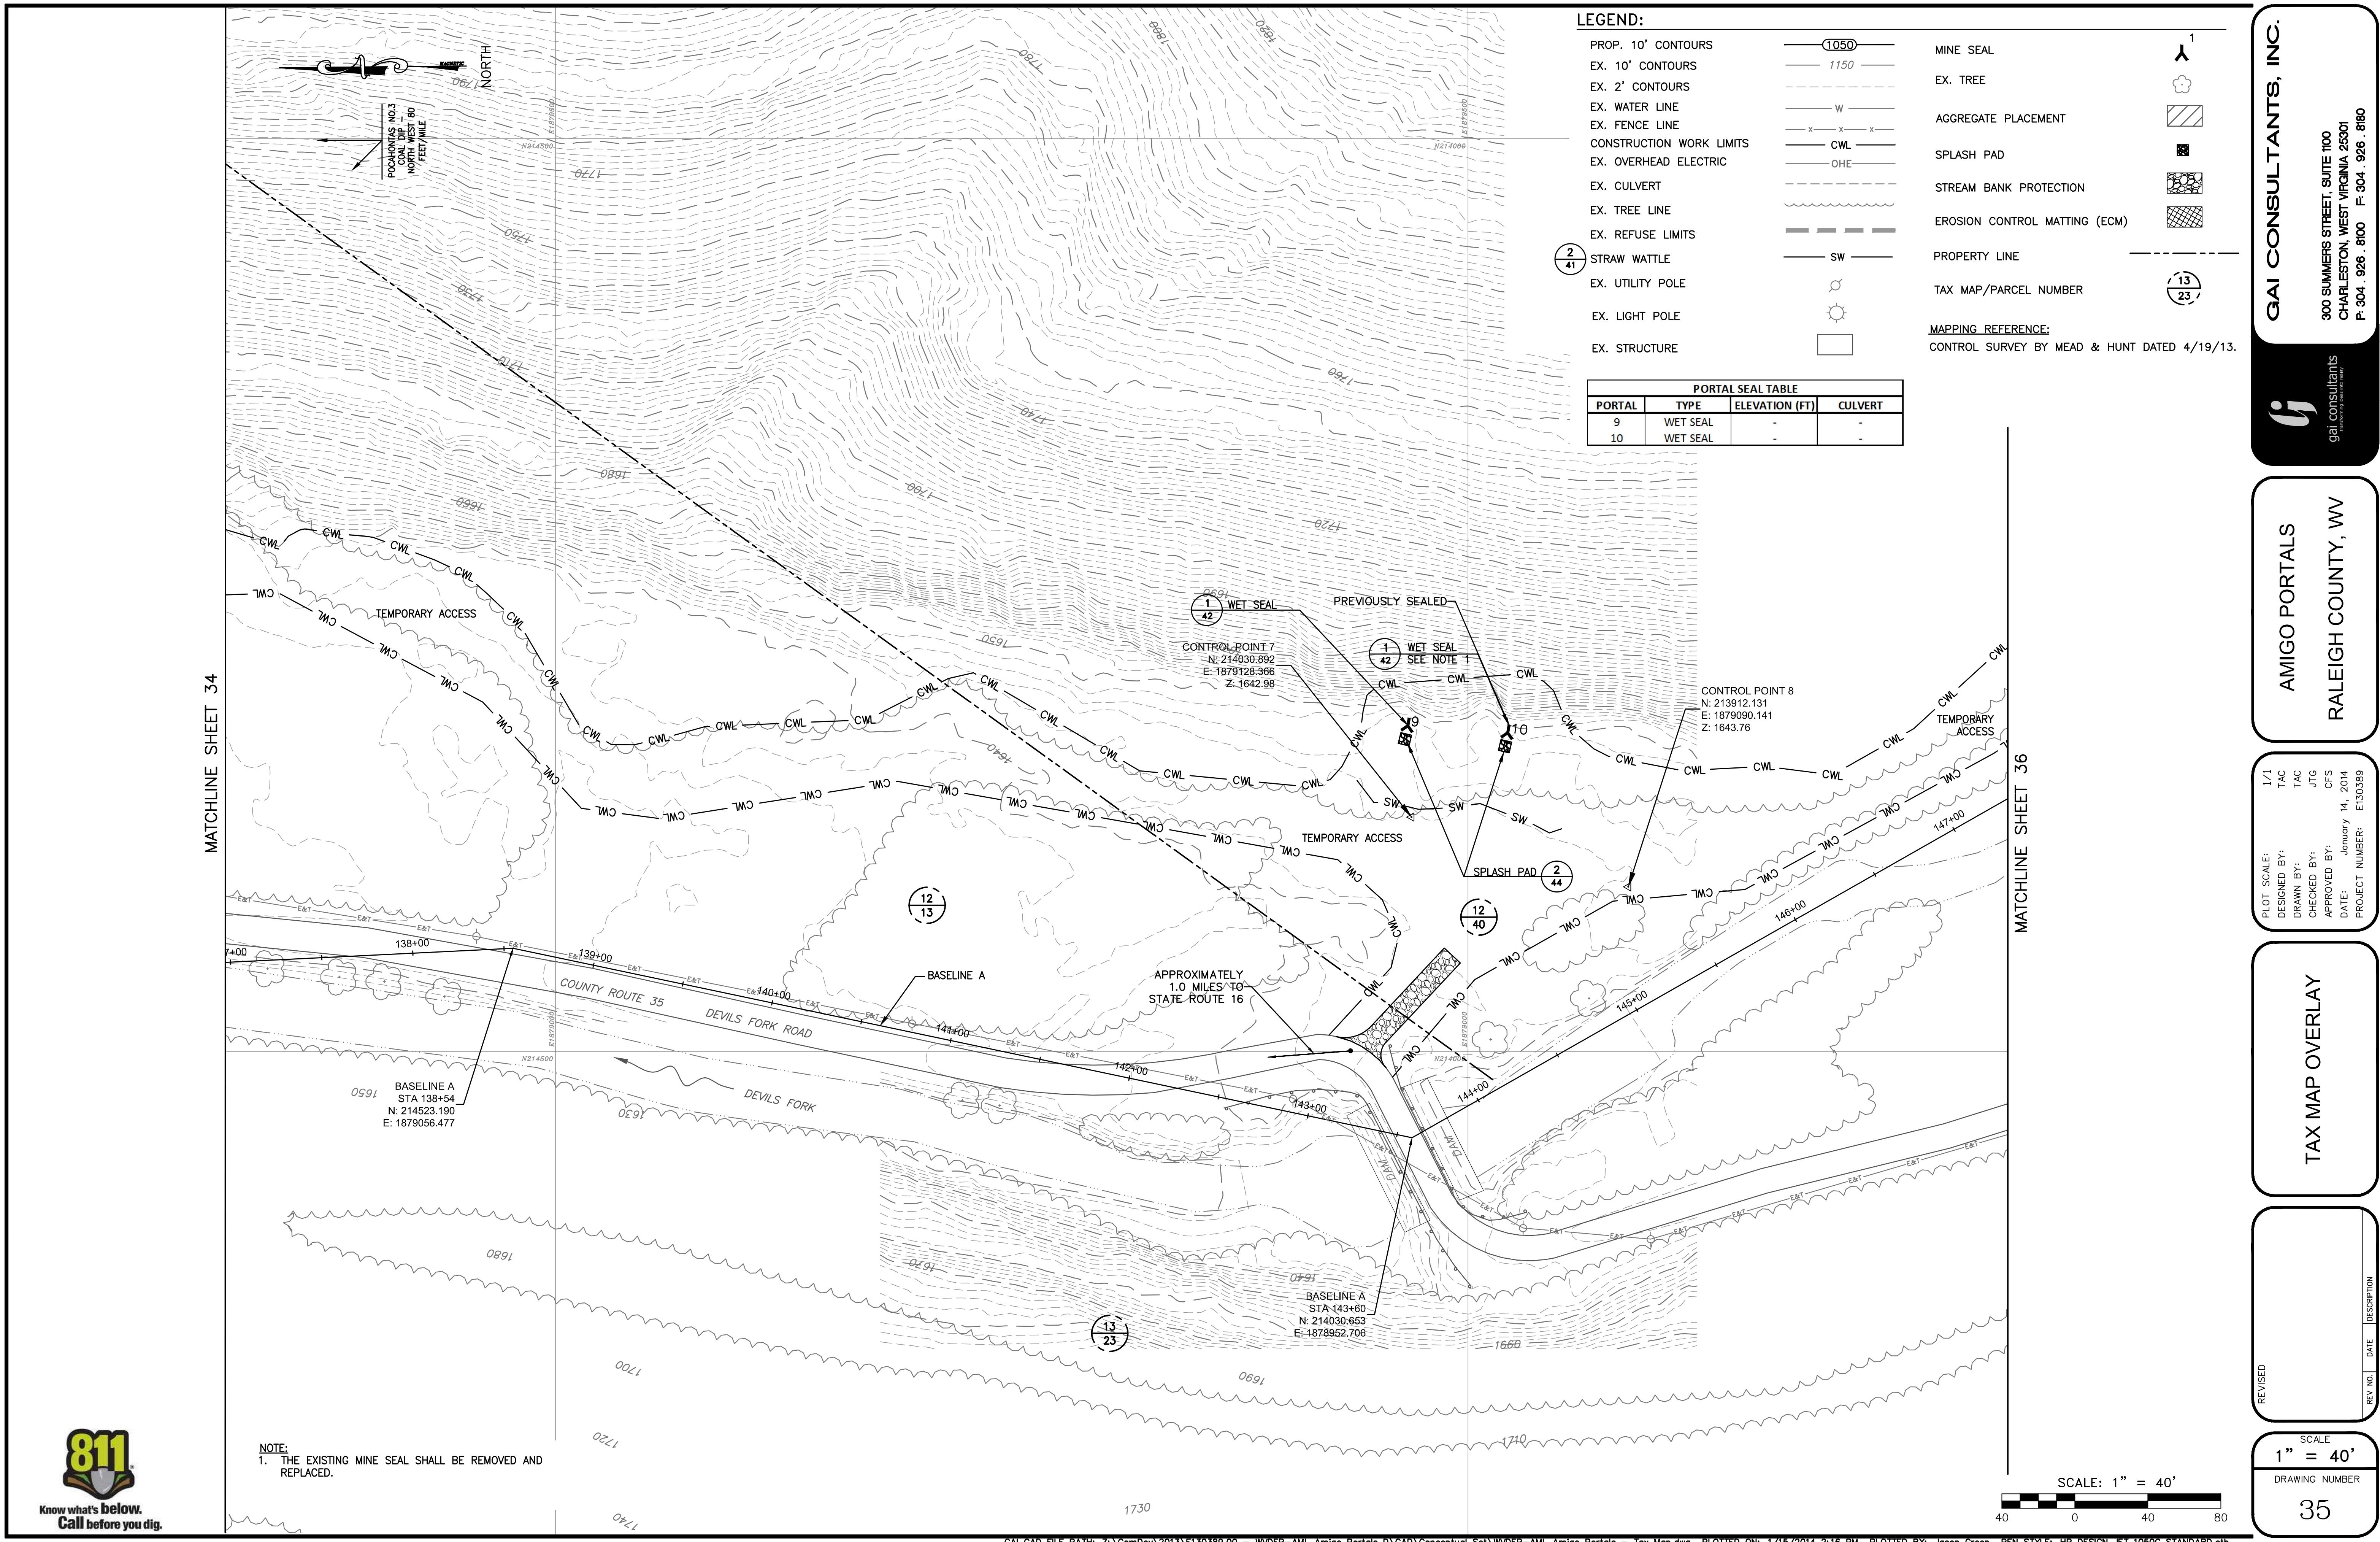
AMIGO PORTALS
RALEIGH COUNTY, WV

PLOT SCALE:
1/1
TAC
TAC
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CS
DATE: January 14, 2014
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TAX MAP OVERLAY

MATCHLINE SHEET 35





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RALEIGH COUNTY, WV

TAX MAP OVERLAY

1/1
TAC
TAC
JTG
CS
DATE: January 14, 2014
PROJECT NUMBER: E130389

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REV. NO. DATE DESCRIPTION


SCALE

1" = 40'

DRAWING NUMBER

35

MATCHLINE SHEET 35

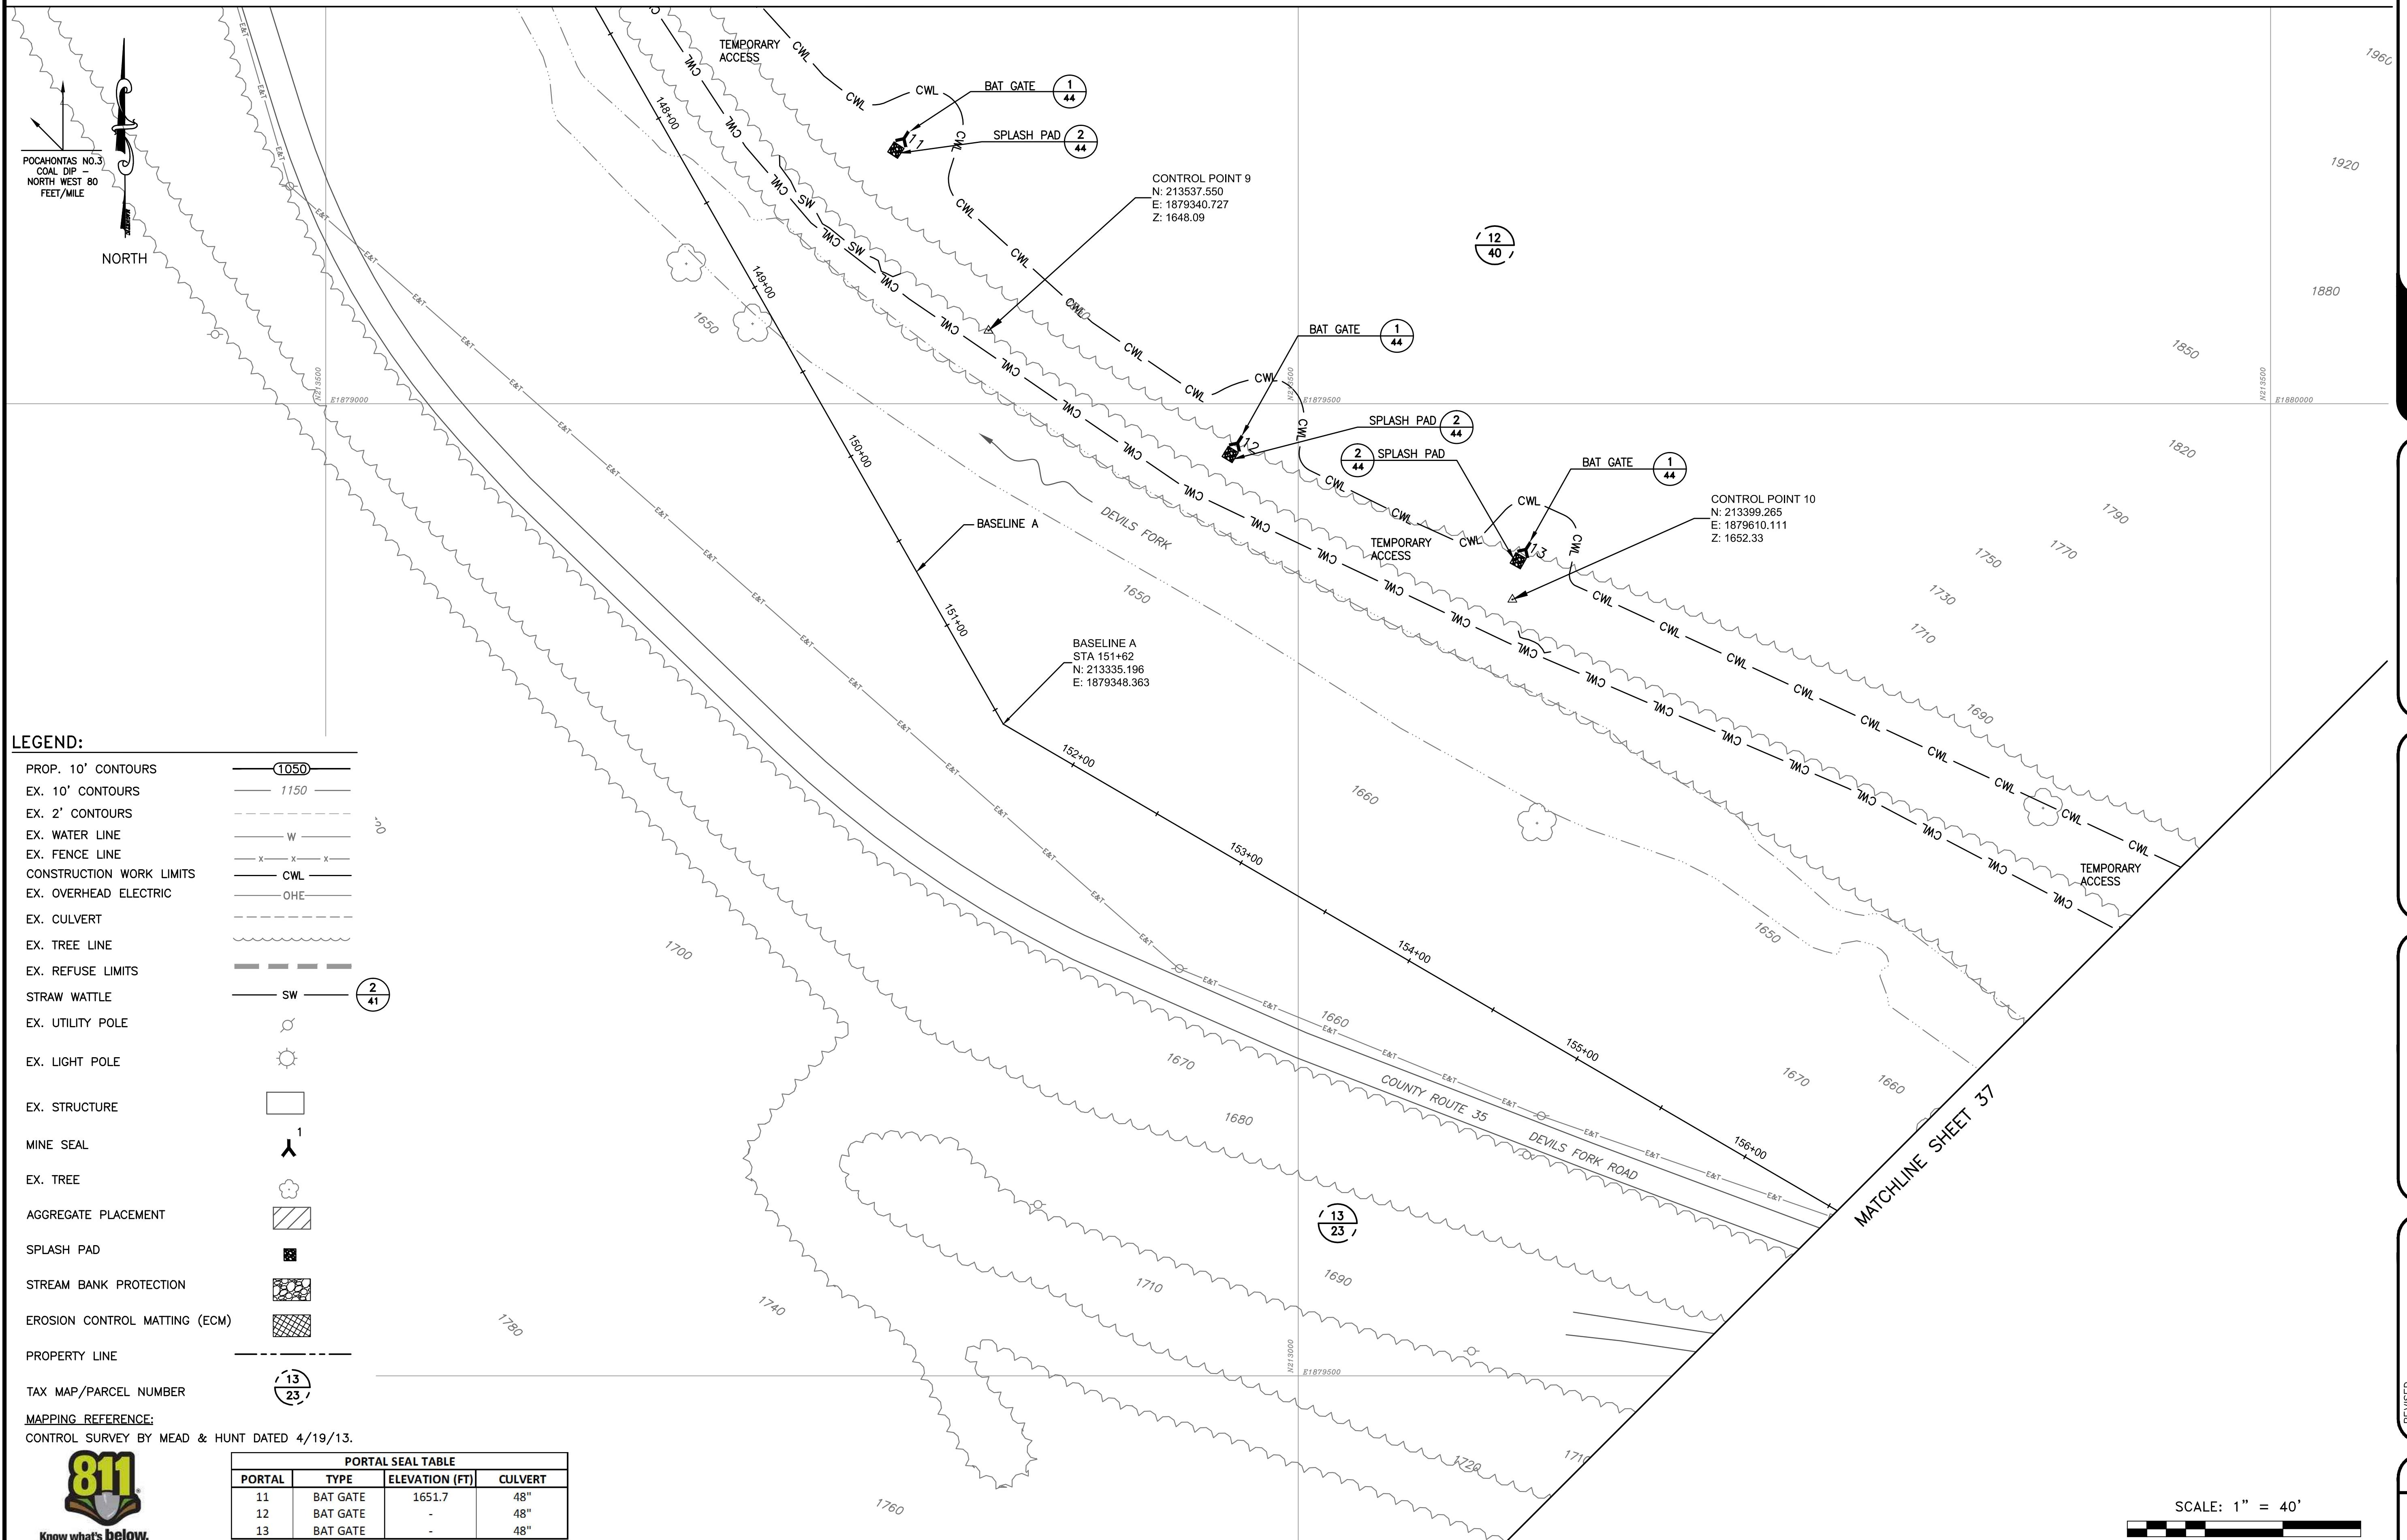

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RALEIGH COUNTY, WV

RALEIGH COUNTY, WV

TAX MAP OVERLAY

IMMIGRATION

/ NO. DATE

SCALE
1" = 40'
DRAWING NUMBER
36

SALE
40%
NUMBER
6

MATCHLINE SHEET 36

LEGEND:

PROP. 10' CONTOURS		MINE SEAL	
EX. 10' CONTOURS		EX. TREE	
EX. 2' CONTOURS		AGGREGATE PLACEMENT	
EX. WATER LINE		CWL	
EX. FENCE LINE		OHE	
CONSTRUCTION WORK LIMITS		E&T	
EX. OVERHEAD ELECTRIC		E&T	
EX. CULVERT		E&T	
EX. TREE LINE		E&T	
EX. REFUSE LIMITS		E&T	
STRAW WATTLE		PROPERTY LINE	
EX. UTILITY POLE		TAX MAP/PARCEL NUMBER	
EX. LIGHT POLE			
EX. STRUCTURE			

MAPPING REFERENCE:
CONTROL SURVEY BY MEAD & HUNT DATED 4/19/13.

- NOTES:
1. THE EXISTING STREAM BANK SHALL BE EXCAVATED AND REALIGNED AS INDICATED AT 2H:1V SLOPE
 2. ANY EXPOSED REFUSE SHALL BE OVEREXCAVATED AND COVERED BY 1 - FOOT OF SOIL PRIOR TO PLACEMENT OF STREAM BANK PROTECTION.
 3. THE EXISTING SAND BAR/ROCK ISLAND SHALL BE REMOVED. THIS SHALL BE CONSIDERED INCIDENTAL TO THE STREAM BANK PROTECTION PAY ITEM.
 4. THE EXCESS MATERIAL FROM THE REALIGNMENT OF THE STREAM BANK AND REMOVAL OF THE SAND BAR/ROCK ISLAND SHALL BE PLACED IN THIS AREA. UPON COMPLETION THE AREA SHALL BE GRADED TO POSITIVELY DRAIN TO THE STREAM AS DIRECTED BY THE ENGINEER. THIS SHALL BE CONSIDERED INCIDENTAL TO THE STREAM BANK PROTECTION PAY ITEM.

MATCHLINE SHEET 38

SCALE: 1" = 40'
DRAWING NUMBER
40 0 40 80

37

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RALEIGH COUNTY, WV



PLOT SCALE:
1/1
TAC
TAC
JTG
CS
DATE: January 14, 2014
PROJECT NUMBER: E130389

TAX MAP OVERLAY

REV. NO. DATE DESCRIPTION



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PORTAL SEAL TABLE			
PORTAL	TYPE	ELEVATION (FT)	CULVERT
14	BAT GATE	1676.4	48"
15	BAT GATE	1686.9	48"
16	BAT GATE	1691.7	48"

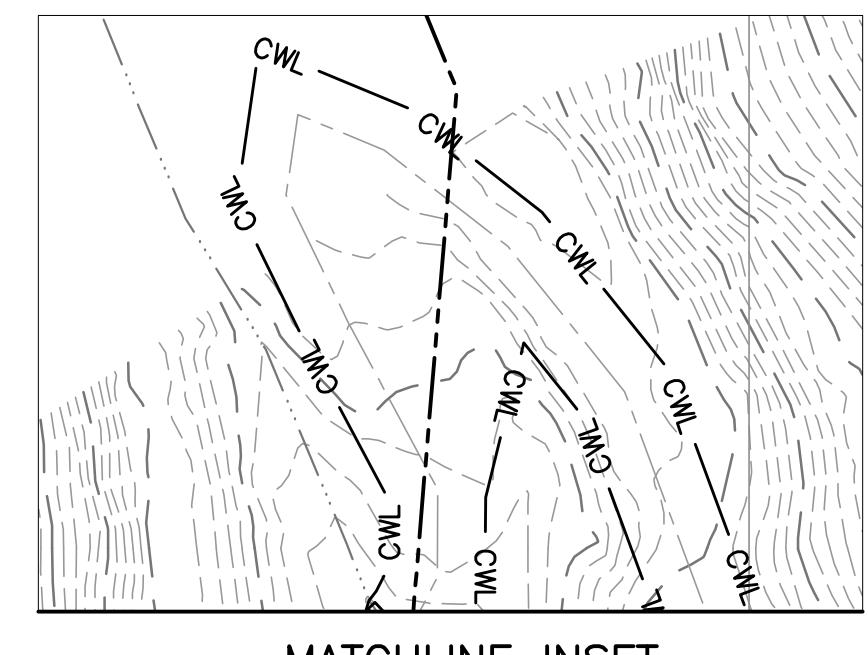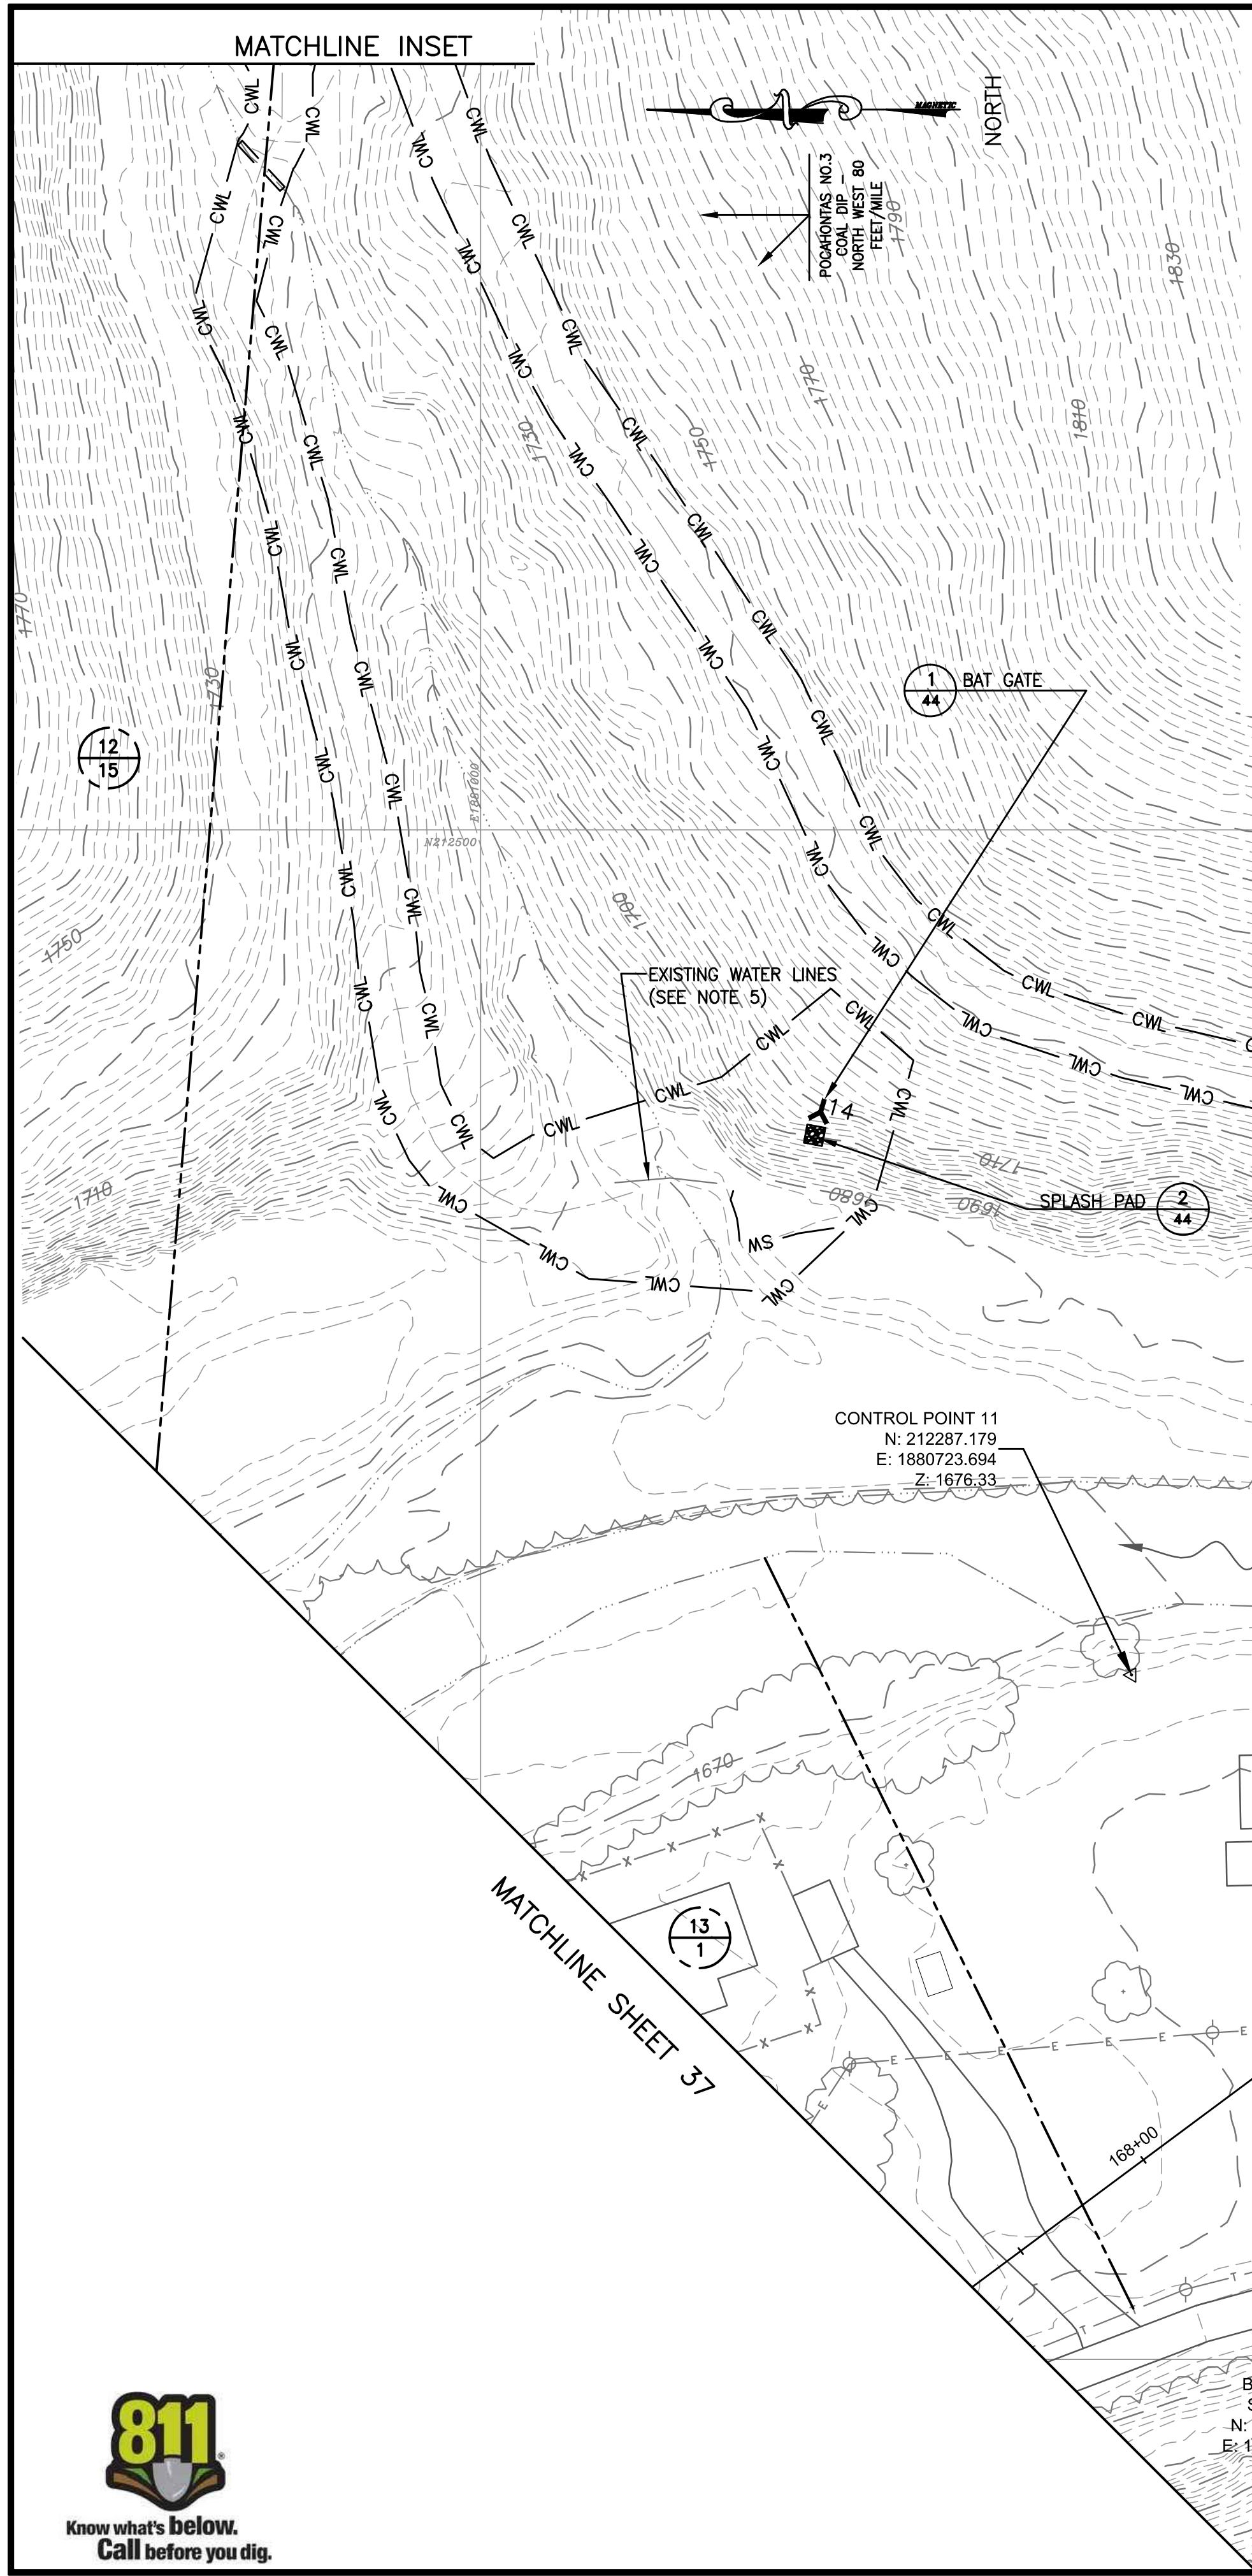- NOTES:
- EXISTING ROCK AND ROCKY MATERIAL REMOVED FROM PORTALS 15 AND 16 SHALL BE REDUCED IN SIZE TO A D50 OF 18 INCHES AND PLACED ALONG THE EXISTING SLOPE AS STREAM BANK PROTECTION. THIS SHALL BE CONSIDERED INCIDENTAL TO THE PROJECT.
 - THE AREA INDICATED SHALL BE REVEGETATED USING SEED FOR HORSE PASTURE.
 - POTENTIAL ACCESS ROUTES FOR PORTAL 14.
 - TRASH IN PORTAL SHALL BE REMOVED AND DISPOSED OF PROPERLY.
 - EXISTING WATERLINES SHALL NOT BE DISTURBED AND ARE TO REMAIN IN USE AFTER CONSTRUCTION.

LEGEND:

PROP. 10' CONTOURS	1050	MINE SEAL
EX. 10' CONTOURS	1150	EX. TREE
EX. 2' CONTOURS	-	AGGREGATE PLACEMENT
EX. WATER LINE	W	SPLASH PAD
EX. FENCE LINE	x x x	STREAM BANK PROTECTION
CONSTRUCTION WORK LIMITS	CWL	EROSION CONTROL MATTING (ECM)
EX. OVERHEAD ELECTRIC	OHE	PROPERTY LINE
EX. CULVERT	-	TAX MAP/PARCEL NUMBER
EX. TREE LINE	-	(13) 23
EX. REFUSE LIMITS	SW	MAPPING REFERENCE:
STRAW WATTLE	-	CONTROL SURVEY BY MEAD & HUNT DATED 4/19/13.
EX. UTILITY POLE	-	
EX. LIGHT POLE	-	
EX. STRUCTURE	-	

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REVIEWED

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SCALE
1" = 40'
DRAWING NUMBER
38

AMIGO PORTALS
RALEIGH COUNTY, WV

PLOT SCALE:
1/1
TAC
JTG
CS
PROJECT NUMBER: E130389

TAX MAP OVERLAY

REV. NO.: DATE: DESCRIPTION

SCALE
1" = 40'
DRAWING NUMBER

39

BASELINE A
STA 187+00
N: 211002.597
E: 1881399.429

CONTROL POINT 14
N: 210811.291
E: 1881317.494
Z: 1713.33

LEGEND:

PROP. 10' CONTOURS	1050
EX. 10' CONTOURS	1150
EX. 2' CONTOURS	
EX. WATER LINE	
EX. FENCE LINE	
CONSTRUCTION WORK LIMITS	
EX. OVERHEAD ELECTRIC	
EX. CULVERT	
EX. TREE LINE	
EX. REFUSE LIMITS	
STRAW WATTLE	
EX. UTILITY POLE	
EX. LIGHT POLE	
EX. STRUCTURE	
MINE SEAL	
EX. TREE	
AGGREGATE PLACEMENT	
SPLASH PAD	
STREAM BANK PROTECTION	
EROSION CONTROL MATTING (ECM)	
PROPERTY LINE	
TAX MAP/PARCEL NUMBER	

REvised
13
23

MAPPING REFERENCE:
CONTROL SURVEY BY MEAD & HUNT DATED 4/19/13.
SCALE: 1" = 40'
40 0 40 80

PORTAL SEAL TABLE			
PORTAL	TYPE	ELEVATION (FT)	CULVERT
17	LOW SUMP CONCRETE	-	-
18	LOW SUMP CONCRETE	-	-

AMIGO PORTALS

RALEIGH COUNTY, WV

PLOT SCALE:
DRAWN BY:
CHECKED BY:
APPROVED BY:
DATE: January 14, 2014
PROJECT NUMBER: E130389

CHANNEL AND MISCELLANEOUS DETAILS

REV'D

DATE

SCALE

DESCRIPTION

REV. NO.





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DRAWING NUMBER


40

CHANNEL SUMMARY									
CHANNEL	TYPE	STATION	DEPTH (FT. MIN.)	SIDE SLOPES	Avg. SLOPE (%)	LINING	LINING THICKNESS	TOP WIDTH (FT. MIN.)	BOTTOM WIDTH (FT.)
1	VEE	10+69.8 - 10+79.1	2	2:1	1.0	RIPRAP	18"	8	0
	VEE	10+79.1 - 11+03.0	2	2:1	10.0	RIPRAP	18"	8	0
	VEE	11+03.0 - 11+10.6	2	2:1	50.0	RIPRAP	18"	8	0
	VEE	11+10.6 - 11+16.6	2	2:1	35.0	RIPRAP	18"	8	0
	VEE	11+16.6 - 11+20.4	2	2:1	0.02	RIPRAP	18"	8	0


NOTE: DEPTH = F.D. + F.b. FROM DETAIL 2/40

RIPRAP "VEE" CHANNEL 2 40

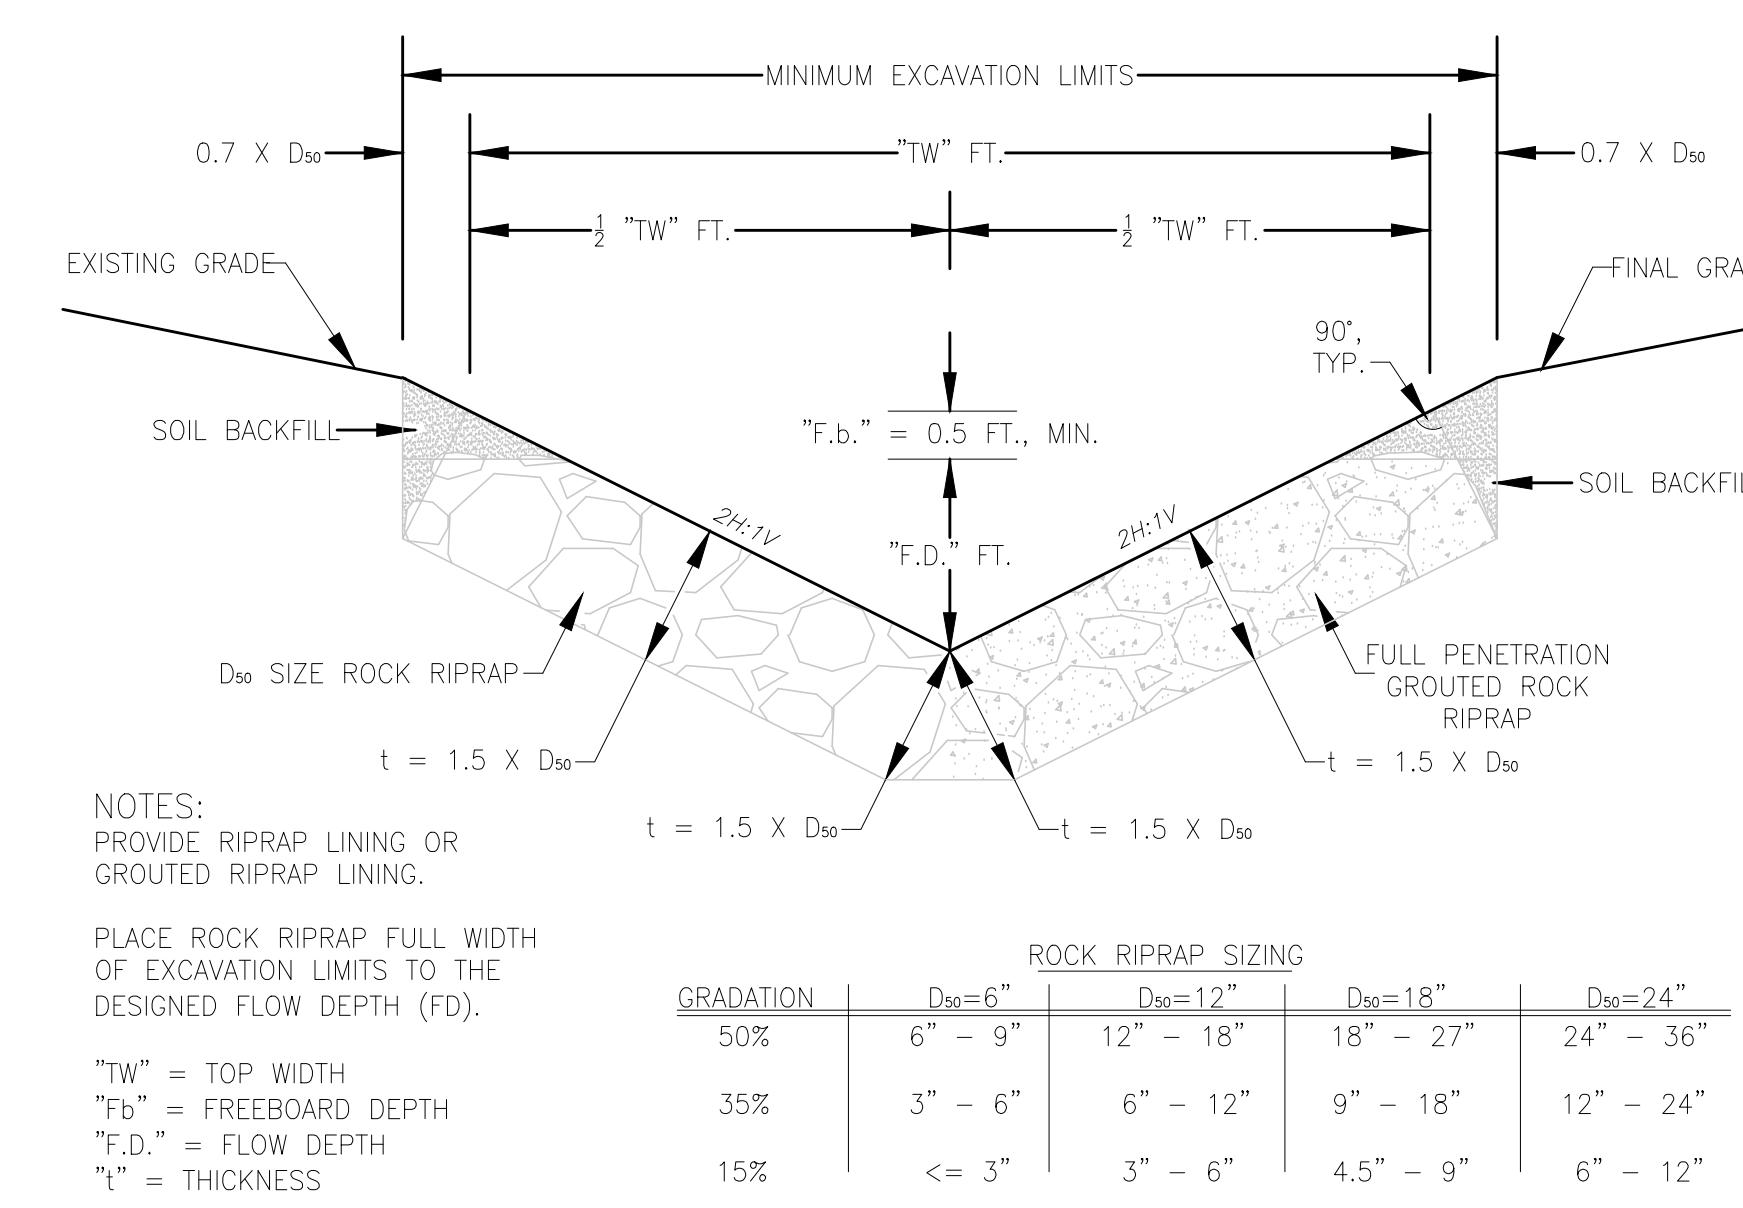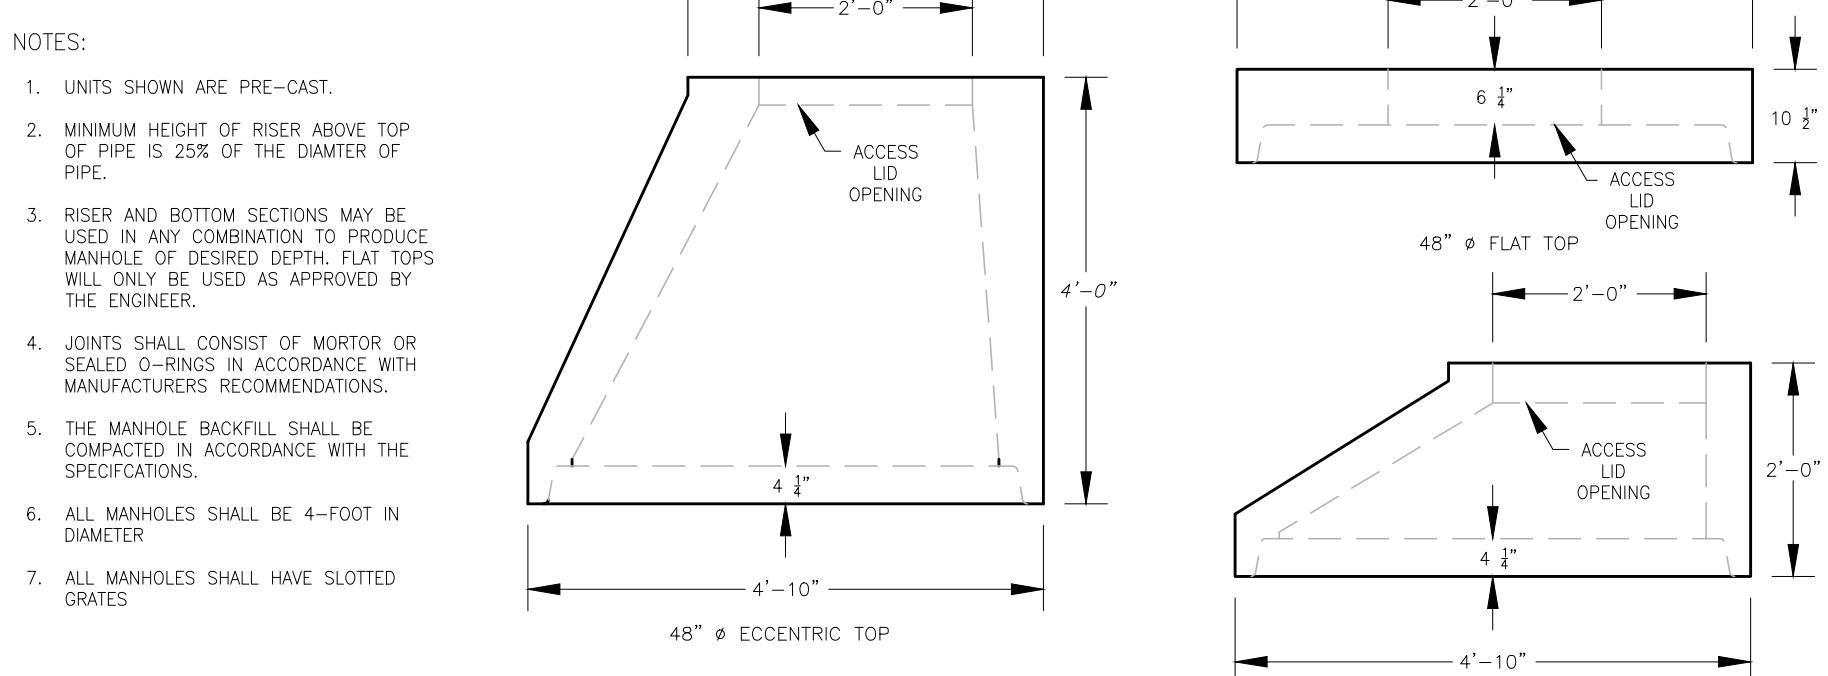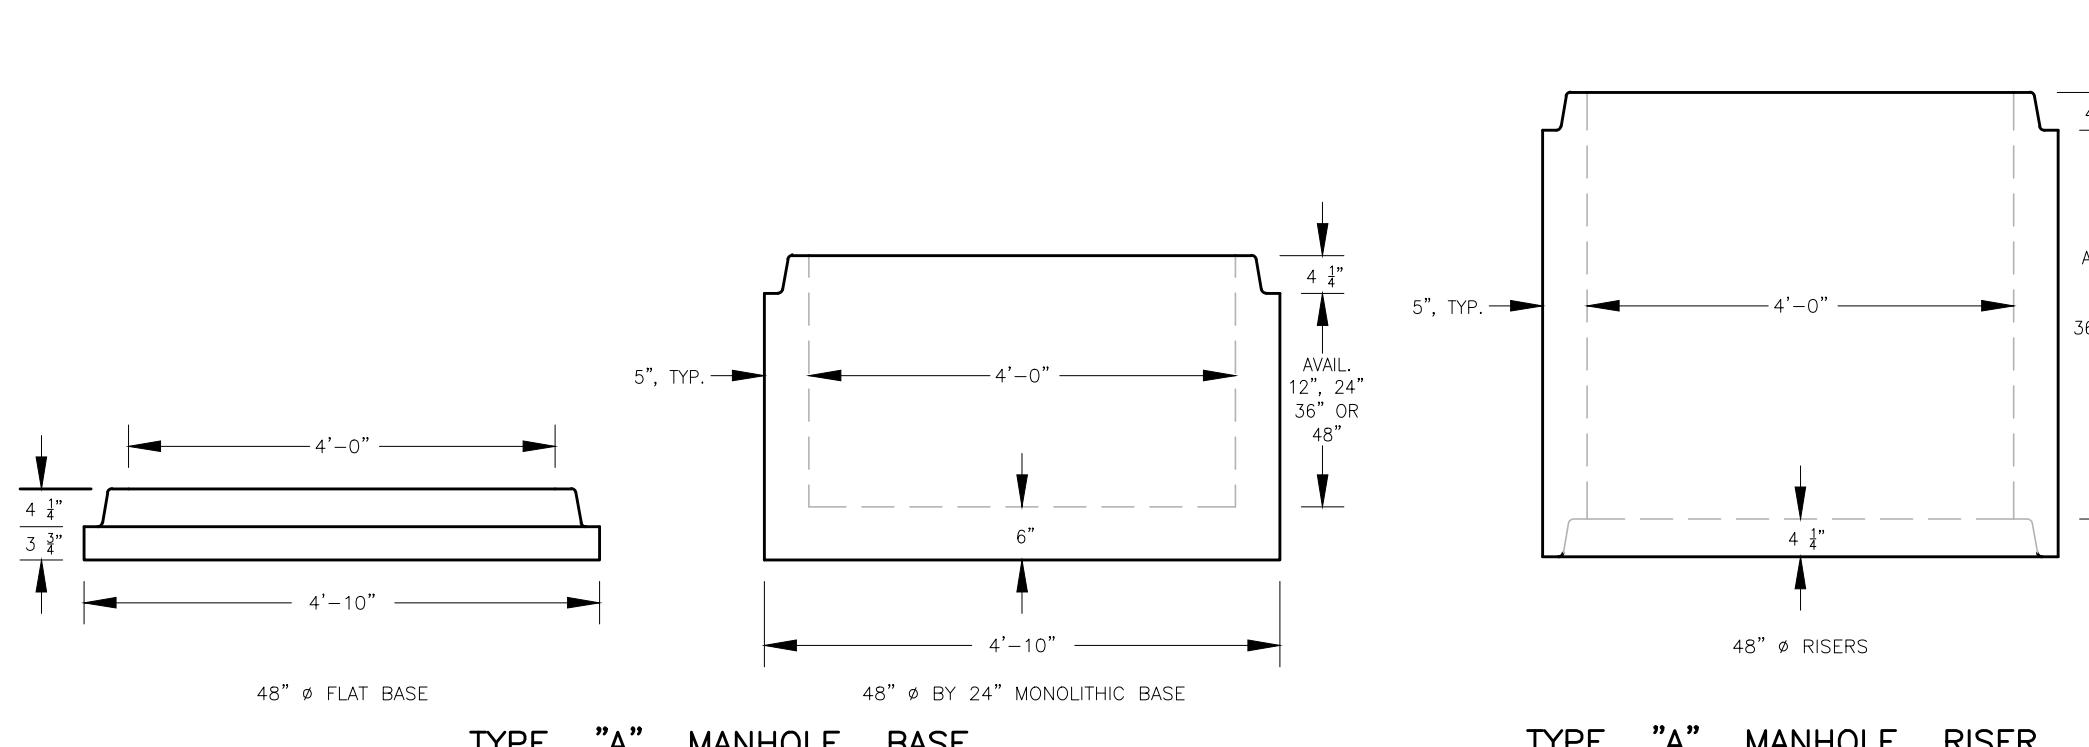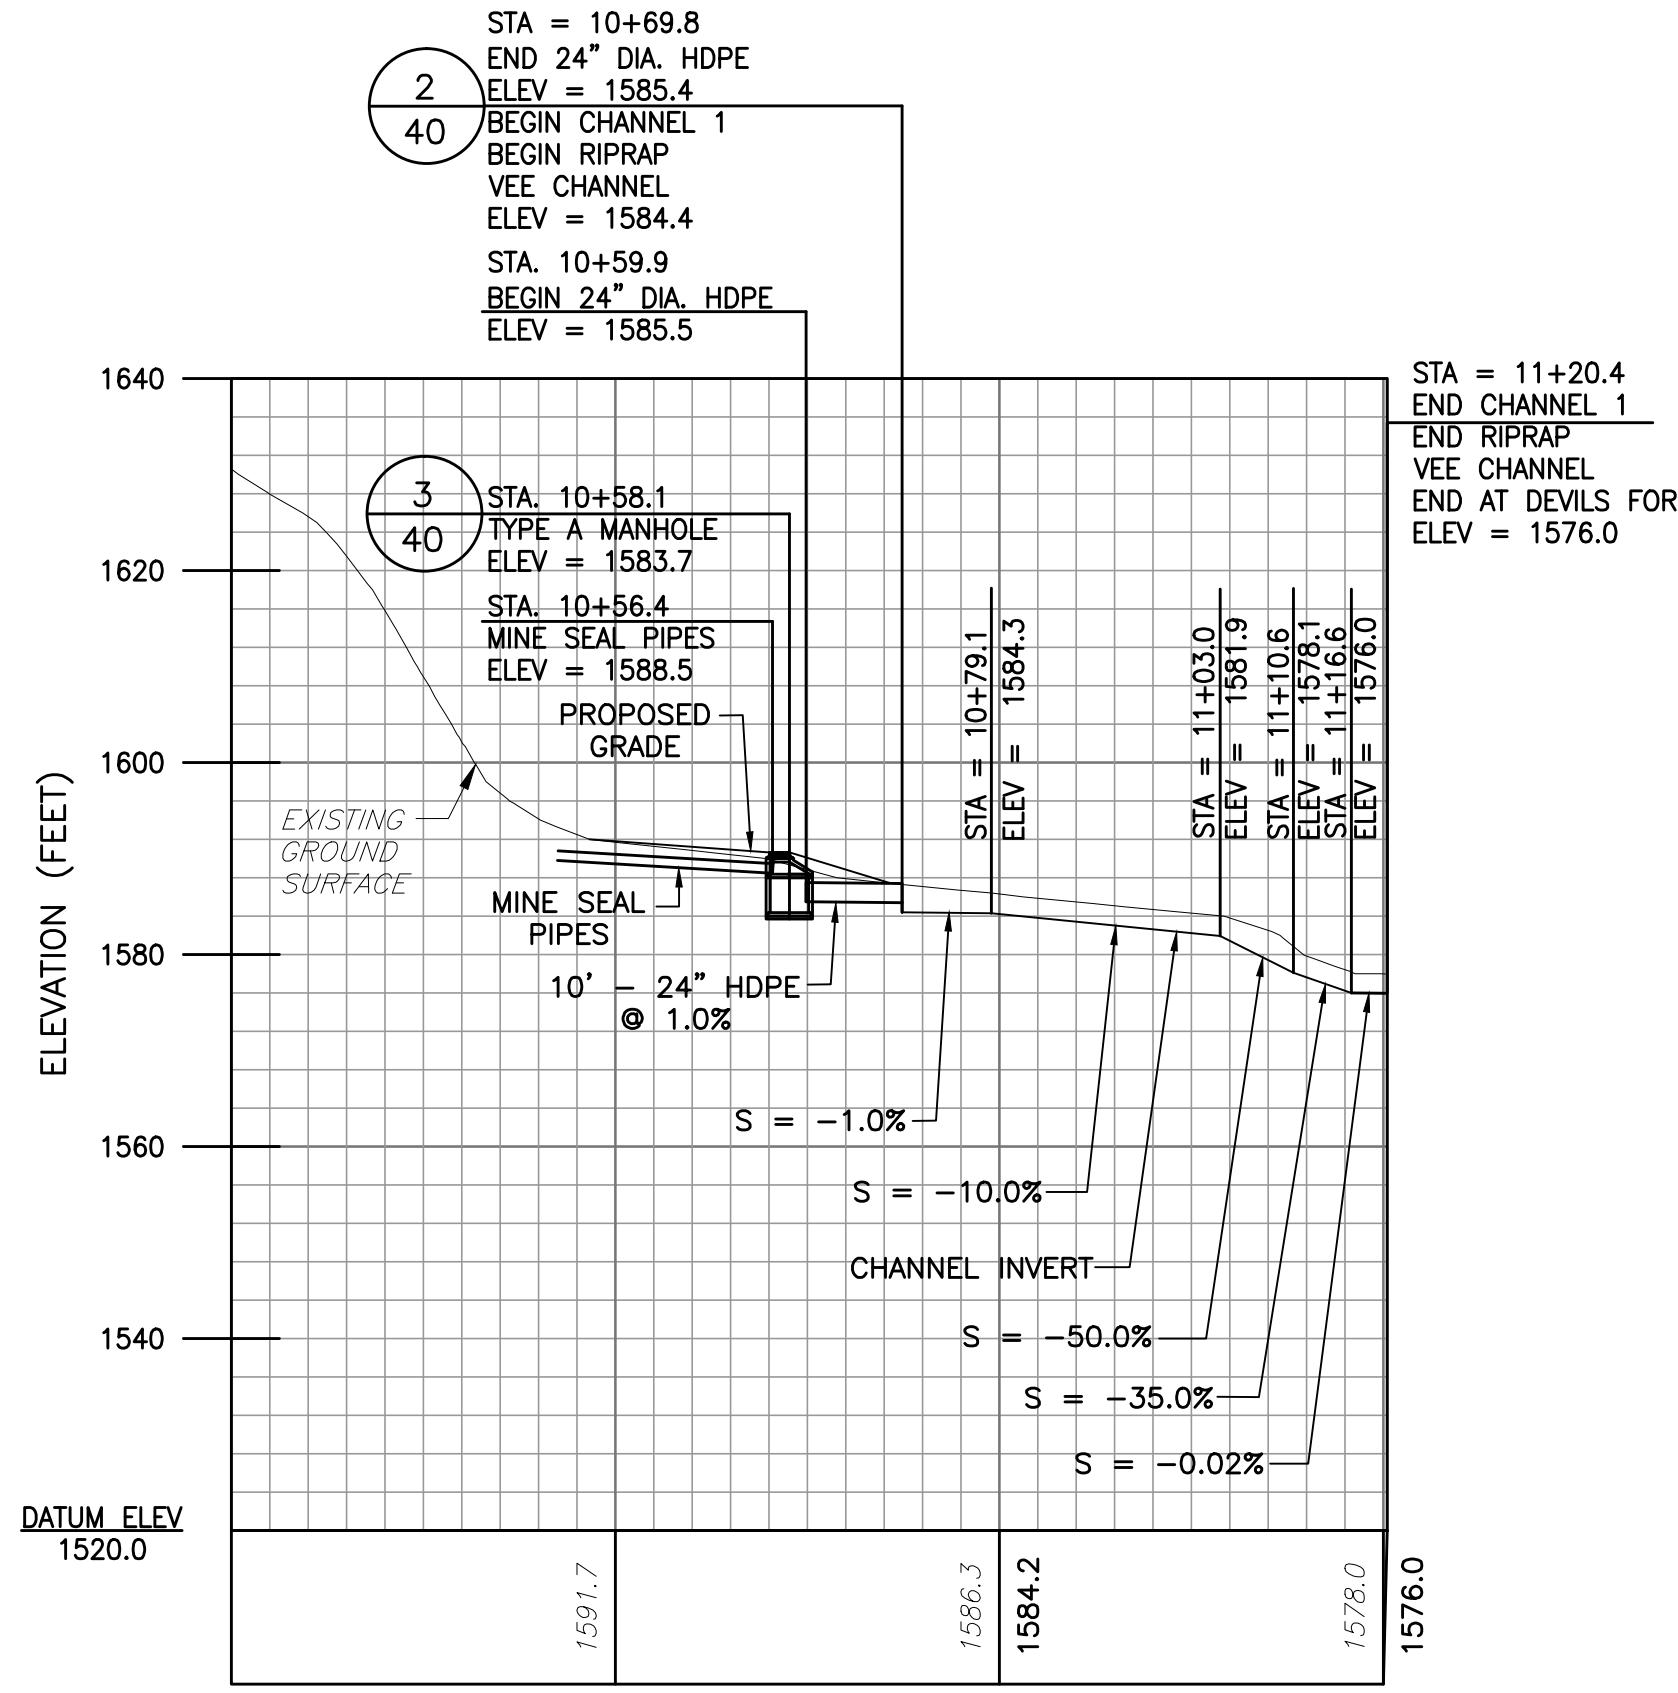TYPE "A" MANHOLE TOPS

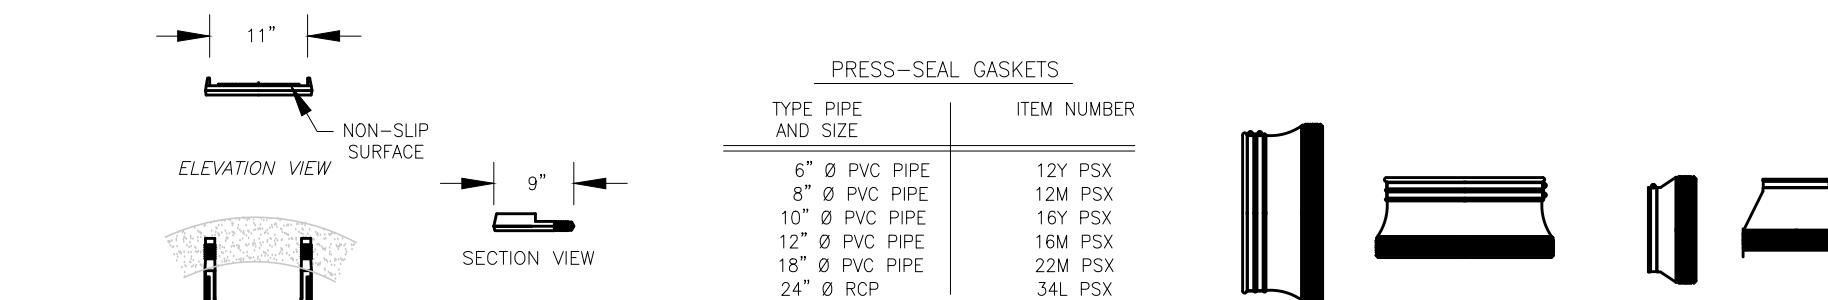

TYPE "A" MANHOLE FRAMES AND COVERS

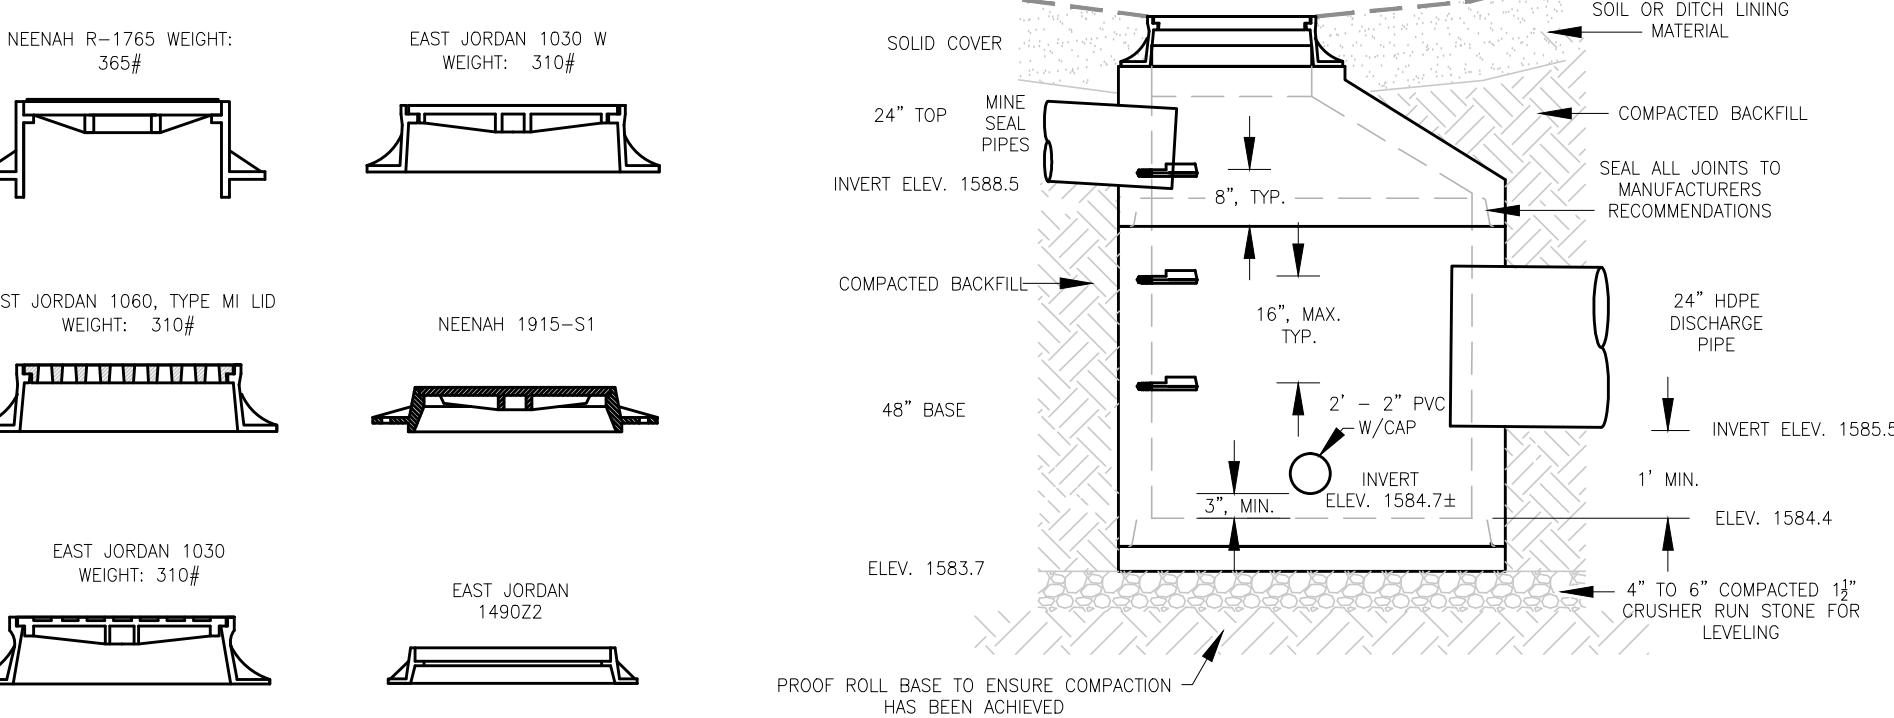TYPE "A" MANHOLE 3 40

NOT TO SCALE

REV'D

DATE

SCALE

DESCRIPTION

REV. NO.

DATE

DRAWING NUMBER

40

AMIGO PORTALS


RALEIGH COUNTY, WV

MISCELLANEOUS DETAILS


REVISED

PLOT SCALE:
DRAWN BY:
CHECKED BY:
APPROVED BY:
DATE: January 14, 2014
PROJECT NUMBER: E130389SCALE AS SHOWN
DRAWING NUMBER 41


1. SET POSTS ALONG CONTOUR OF THE LAND AND EXCAVATE TRENCH UPSLOPE ALONG THE LINE OF POSTS

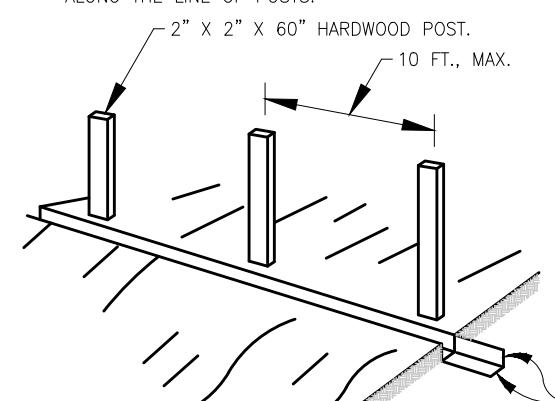

2. ATTACH THE GEOTEXTILE TO THE FENCE POSTS AND EXTEND IT INTO THE DITCH


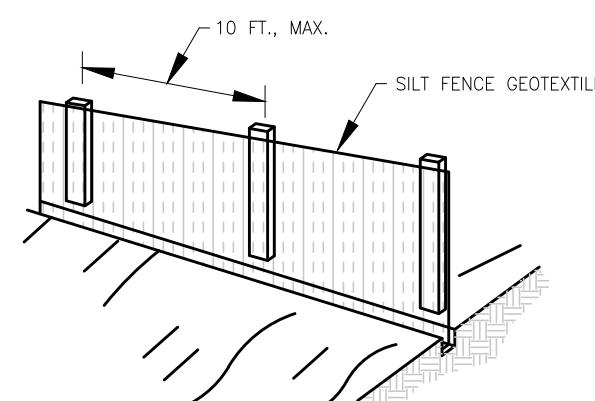


3. BACKFILL AND COMPACT THE TRENCH WITH EXCAVATED SOILS

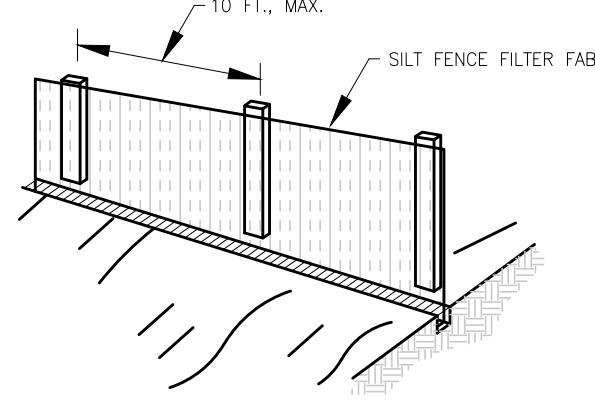

SILT FENCE NOTES:

1. GEOTEXTILE SHALL BE PURCHASED IN A CONTINUOUS ROLL AND CUT TO ALIGNMENT LENGTH TO AVOID JOINTS WHERE JOINTS ARE UNAVOIDABLE, THE FABRIC SHALL BE SPLICED TOGETHER AT A SUPPORT POST BY TWISTING THE POST OF EACH RUN AROUND EACH OTHER.
2. GEOTEXTILE SHALL BE FASTENED SECURELY TO THE UPSLOPE SIDE OF THE SUPPORT POSTS USING ONE INCH, MINIMUM, LONG HEAVY-DUTY WIRE STAPLES OR TIE WIRES WITH EIGHT INCHES, MINIMUM, OF FABRIC EXTENDED INTO THE TRENCH. DO NOT STAPLE FABRIC TO TREES.
3. COMPACTED SOIL BACKFILL SHALL BE PLACED IN THE 4" X 4" TRENCH ATOP THE EXTENDED FABRIC.
4. POSTS SHALL BE CONSTRUCTED OF 2" X 2" HARDWOOD OR 2" X 4" PINE BY 60" LONG.
5. GEOTEXTILE SHALL BE NON-WOVEN "MIRAFI 100X", "EXXON GTF 180" OR EQUAL.
6. APPROVED PREFABRICATED UNITS INCLUDE "GEOFAB", "ENVRFENCE", OR APPROVED EQUAL.
7. THE MAXIMUM RUN OF SLOPE ABOVE A ROW OF SILT FENCE IS 110 FEET.

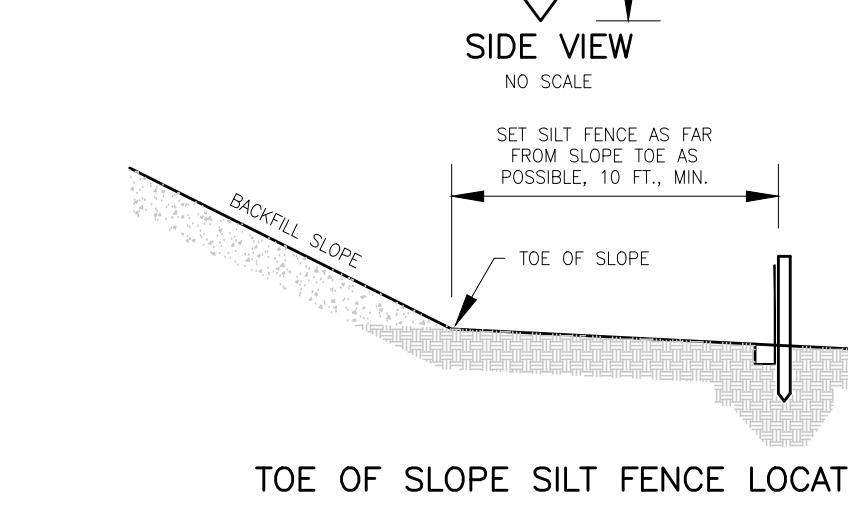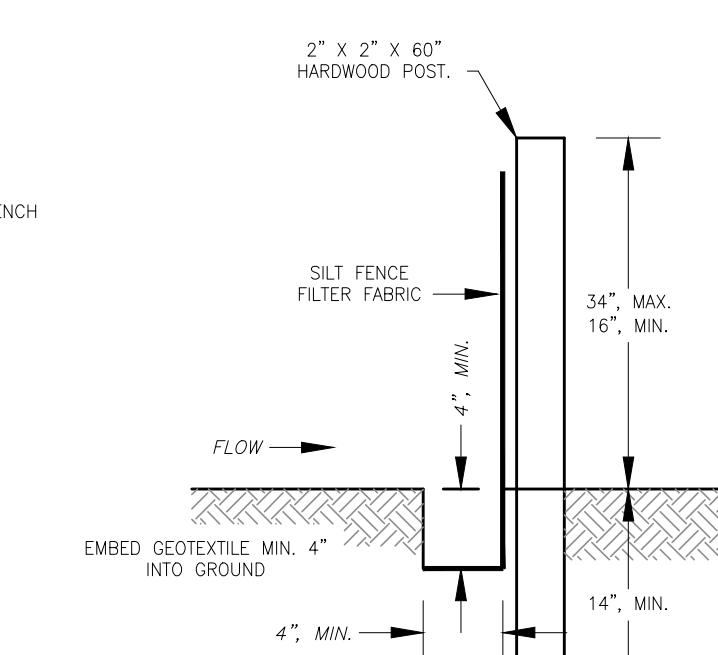

SILT FENCE


NOT TO SCALE

1 41

1. THE EXISTING STREAM BANK SHALL BE EXCAVATED AND REALIGNED AS INDICATED WITH 2H:1V SLOPE IN THE AREA SHOWN ON THE PLAN.

2. ANY EXPOSED REFUSE SHALL BE OVEREXCAVATED AND COVERED BY 1 - FOOT OF SOIL PRIOR TO PLACEMENT OF STREAM BANK PROTECTION.

3. THE EXISTING SAND BAR/ROCK ISLAND SHALL BE REMOVED AND PLACED ON THE BANK ABOVE THE STREAM BANK AS SHOWN ON THE PLAN. THIS SHALL BE CONSIDERED INCIDENTAL TO THE STREAM BANK PROTECTION PAY ITEM.

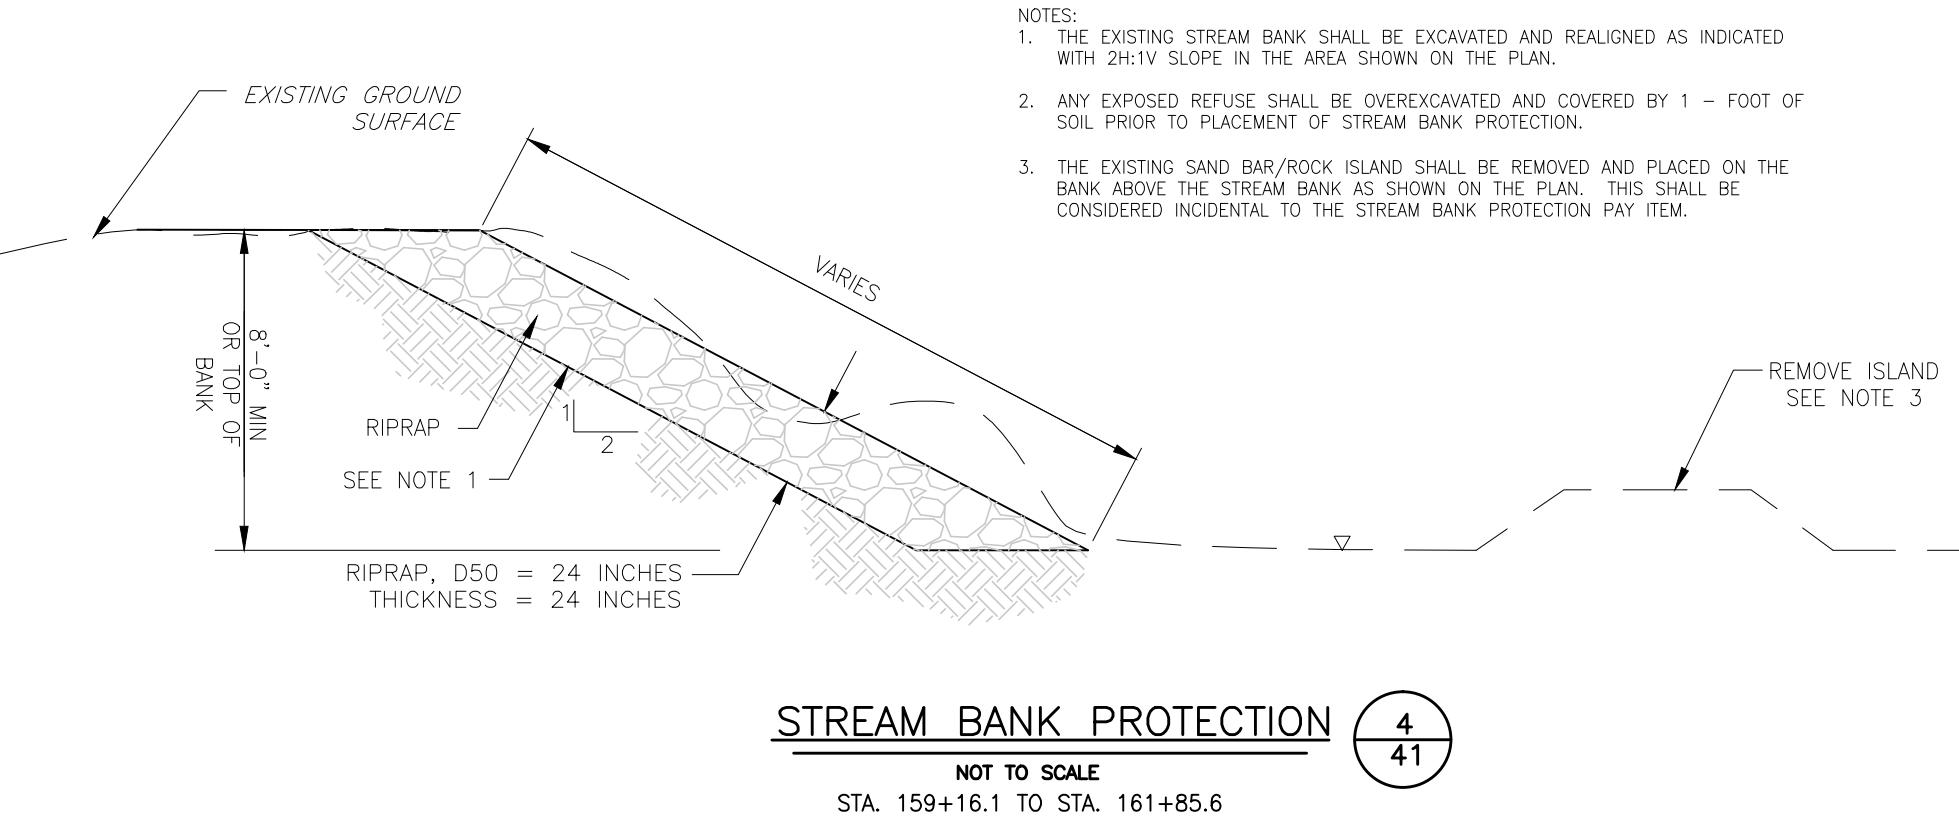

STREAM BANK PROTECTION

NOT TO SCALE

STA. 159+16.1 TO STA. 161+85.6

4 41

SIDE VIEW

NO SCALE

1" HEAVY DUTY WIRE STAPLE

ROLL END

2" X 2" X 60" HARDWOOD POST.

1" HEAVY DUTY WIRE STAPLE

SILT FENCE FILTER FABRIC

ROLL END

2" X 2" X 60" HARDWOOD POST.

SILT FENCE FILTER FABRIC

NO SCALE

1" HEAVY DUTY WIRE STAPLE

ROLL END

SILT FENCE FILTER FABRIC

NO SCALE

1" HEAVY DUTY WIRE STAPLE

ROLL END

SILT FENCE FILTER FABRIC

NO SCALE

1" HEAVY DUTY WIRE STAPLE

ROLL END

SILT FENCE FILTER FABRIC

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ROLL END

SILT FENCE FILTER FABRIC

NO SCALE

1" HEAVY DUTY WIRE STAPLE




Strategic Consultants
transforming ideas into reality

AMIGO PORTALS

RALEIGH COUNTY, W.

MINE SEA


DETAILS

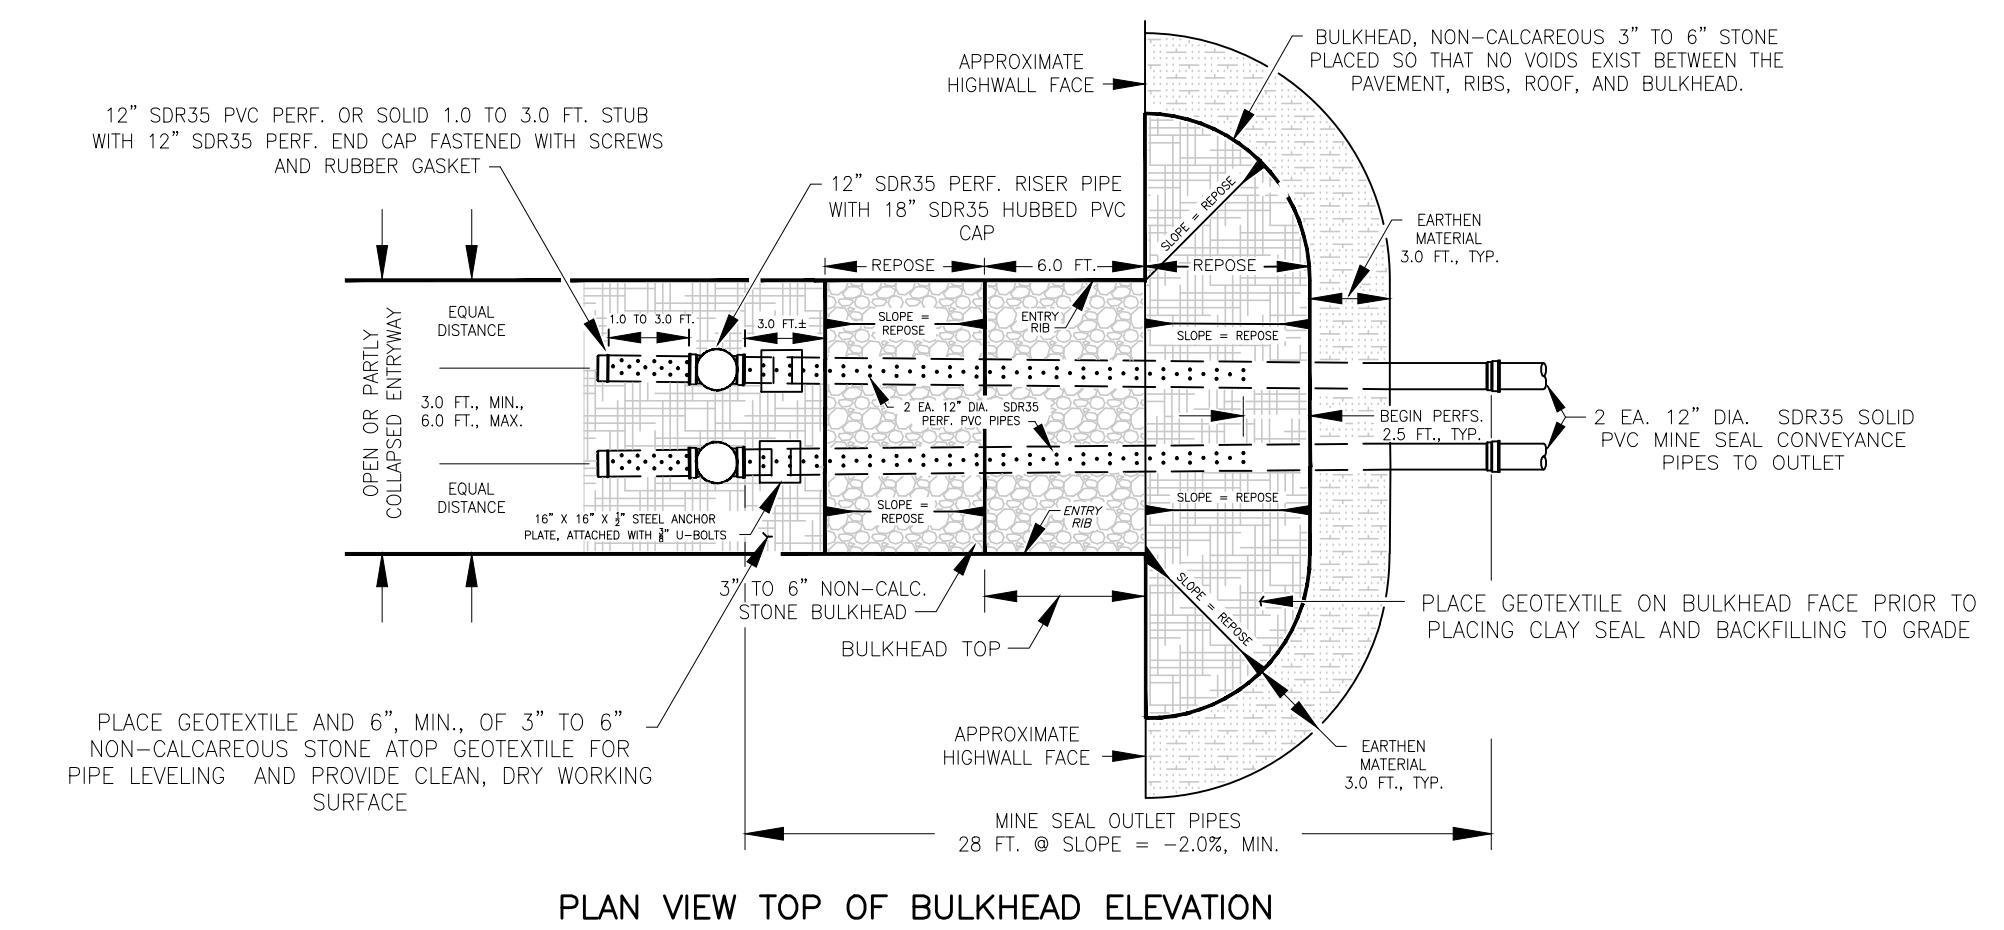


PLAN VIEW TOP OF BULKHEAD ELEVATION

NOTES:


1. THE TWO (2) JOINTS (28.0 FEET) OF MINE SEAL OUTLET PIPES SHALL BE INCLUDED IN THE UNIT PRICE BID FOR "WET MINE SEALS" REGARDLESS OF WHERE THESE PIPES END IN THE INSTALLATION.
 2. THE MINE SEAL CONVEYANCE PIPE LENGTHS VARY AND SHALL BE INCLUDED IN THE UNIT PRICE BID FOR "MINE SEAL CONVEYANCE PIPES". MINE SEAL CONVEYANCE PIPES BEGIN AT THE END OF THE MINE SEAL OUTLET PIPES AND EXTEND TO THE PLANNED OUTFALL.
 3. THE PERFORATED END CAP LOCATED INSIDE THE MINE AT THE END OF THE ONE TO THREE FOOT (1.0' TO 3.0') STUB SHALL HAVE A RUBBER GASKET, PLACED ON THE UPSTREAM END OF THE STUB AND SCREWED IN PLACE.
 4. THE STONE BULKHEAD SHALL BE IN CONTACT WITH COAL ROOF FOR A DISTANCE EQUAL TO THE OPENING HEIGHT OR A MINIMUM OF 6.0 FEET. THE INSIDE AND OUTSIDE STONE BULKHEAD FACES SHALL BE CONSTRUCTED AT THE ANGLE OF REPOSE OF THE 3" TO 6" NON-CALCAREOUS STONE PLACED.
 5. 1 $\frac{1}{2}$ " CRUSHER RUN STONE SHALL MEET THE GRADATION REQUIREMENTS FOR CLASS 1 AGGREGATE IN TABLE 704.6.2A OF THE WVDOT SPECIFICATIONS FOR ROADS AND BRIDGES.

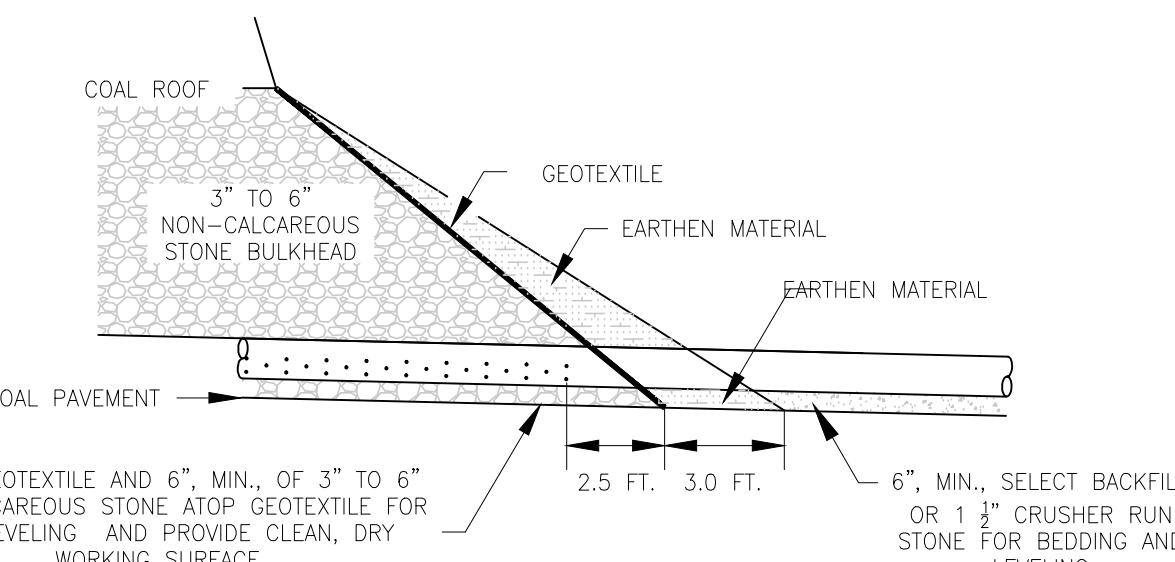


EARTHEN MATERIAL DETAILS

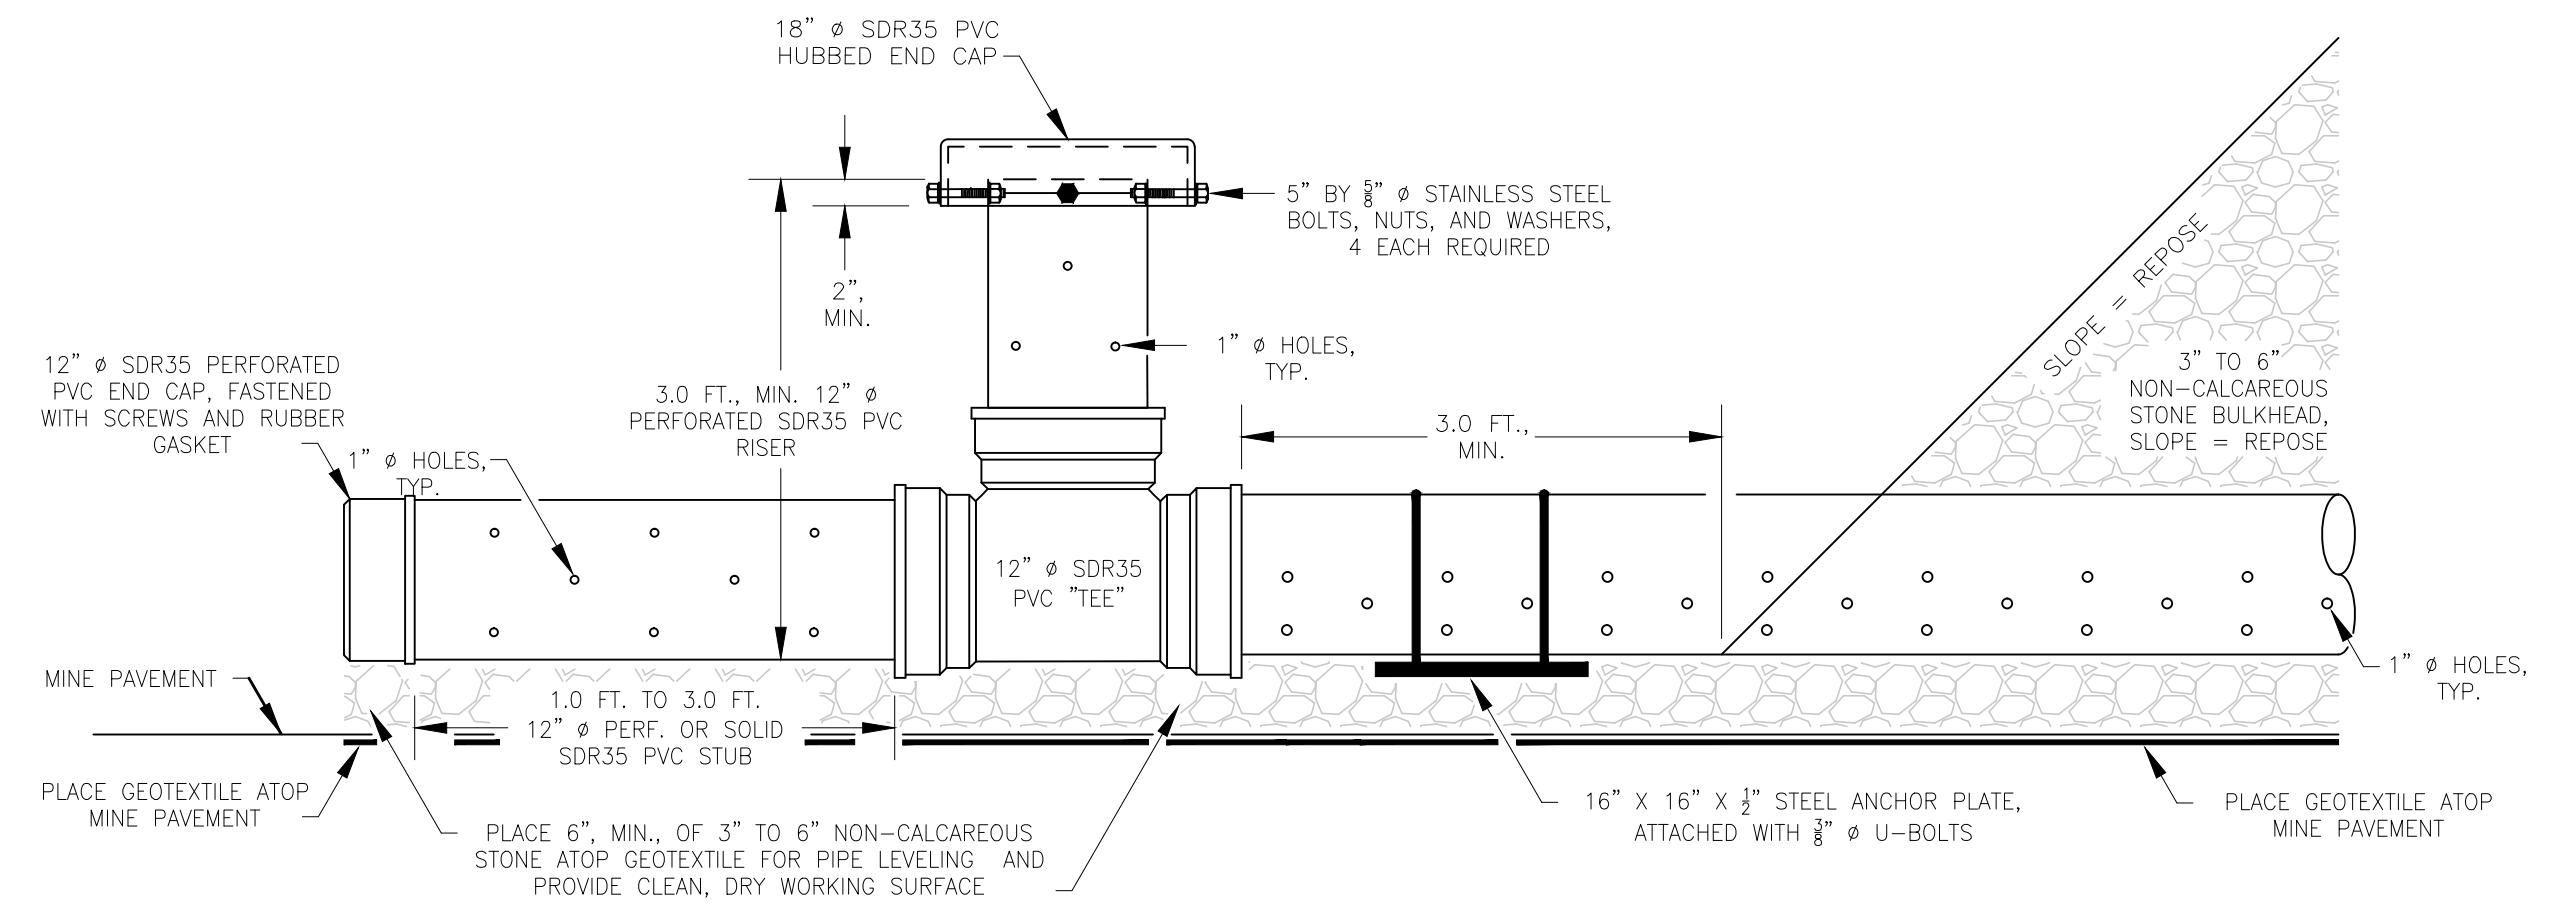


"TEE" RISER DETAIL

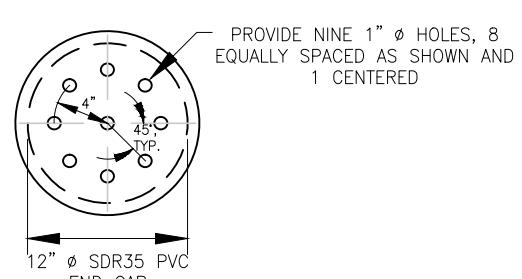


PERFORATED END CAP

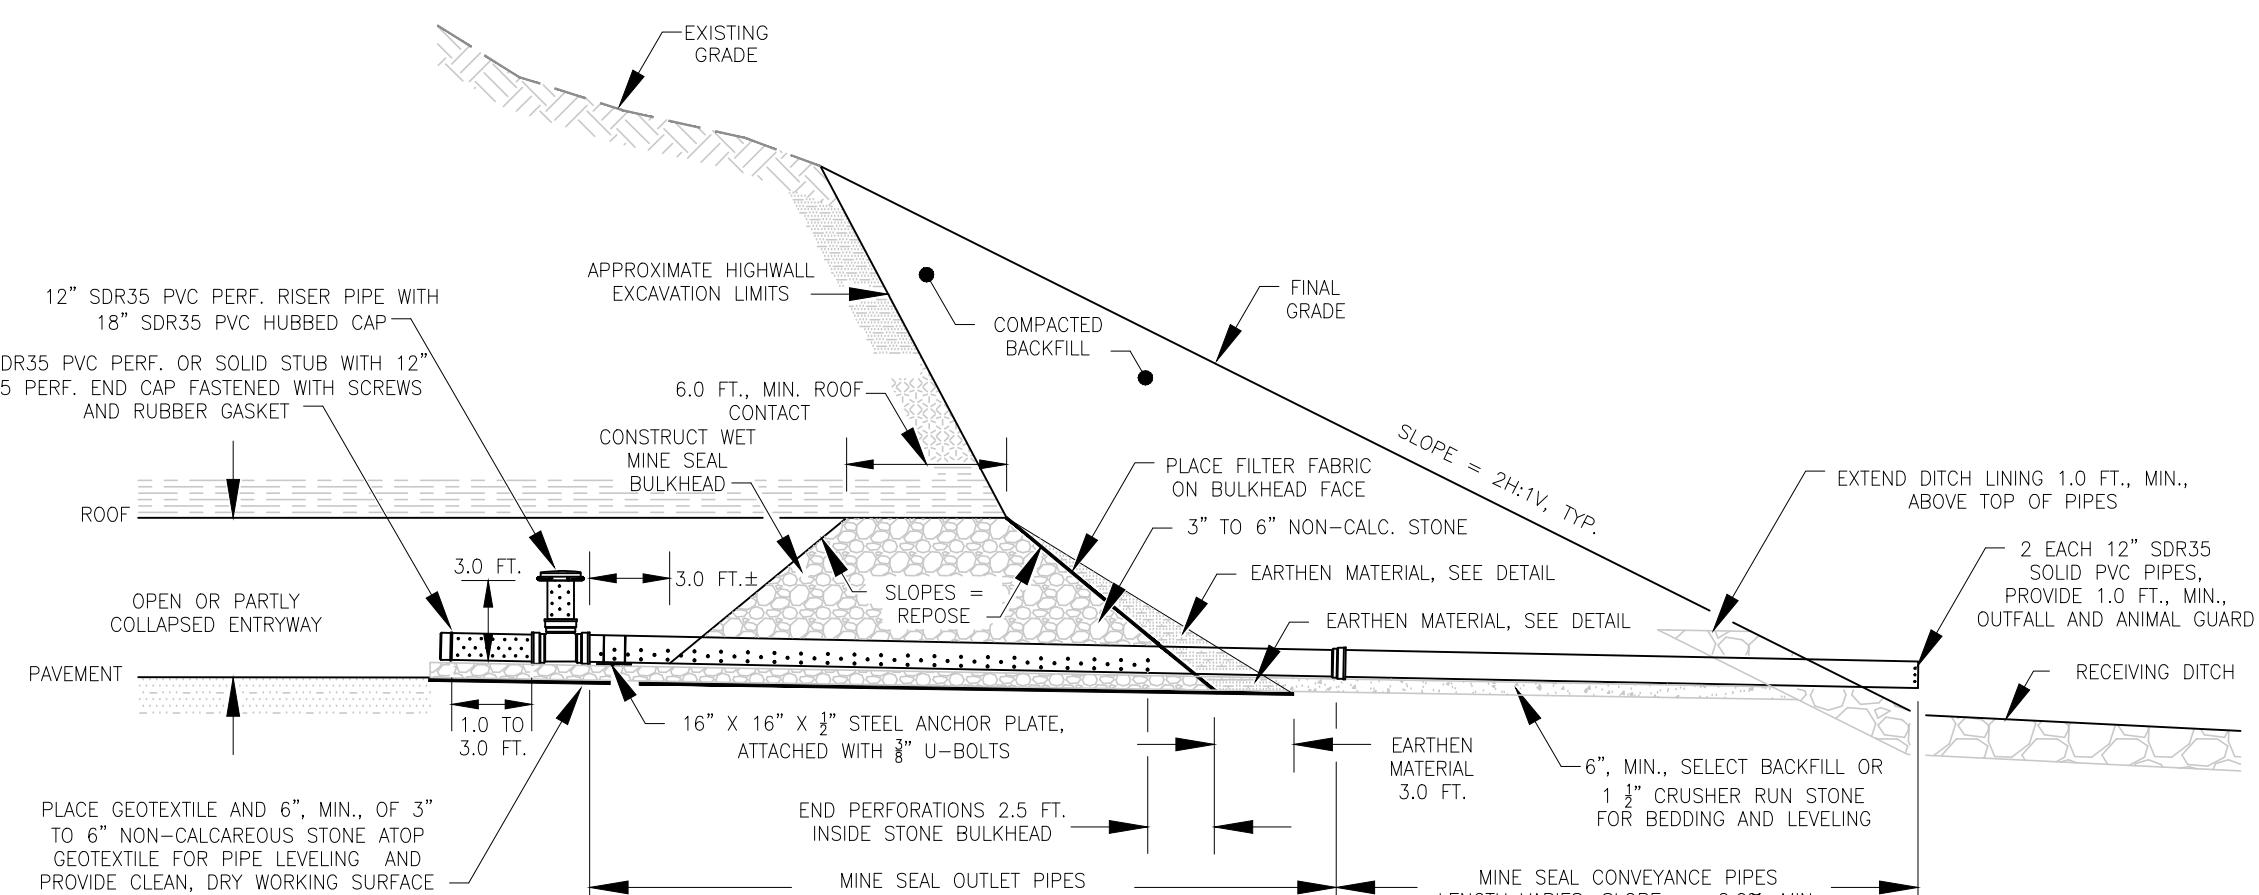


PROFILE VIEW, TY

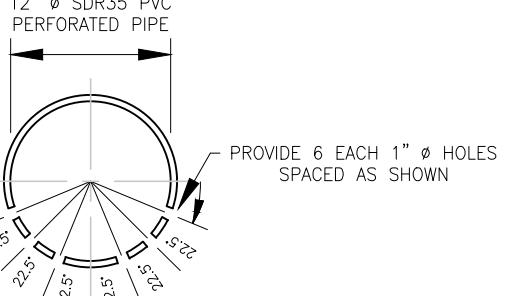


WET MINE SEAL OUTLET PIPES CROSS SECTION

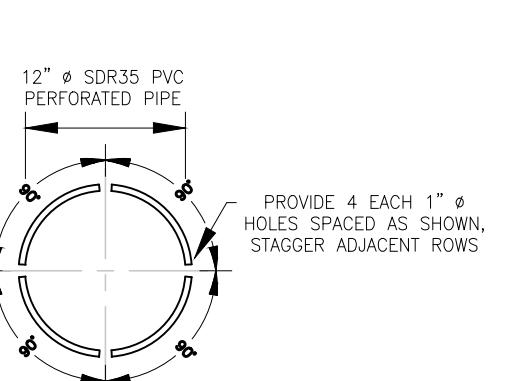

RISFR CAP DFTAI

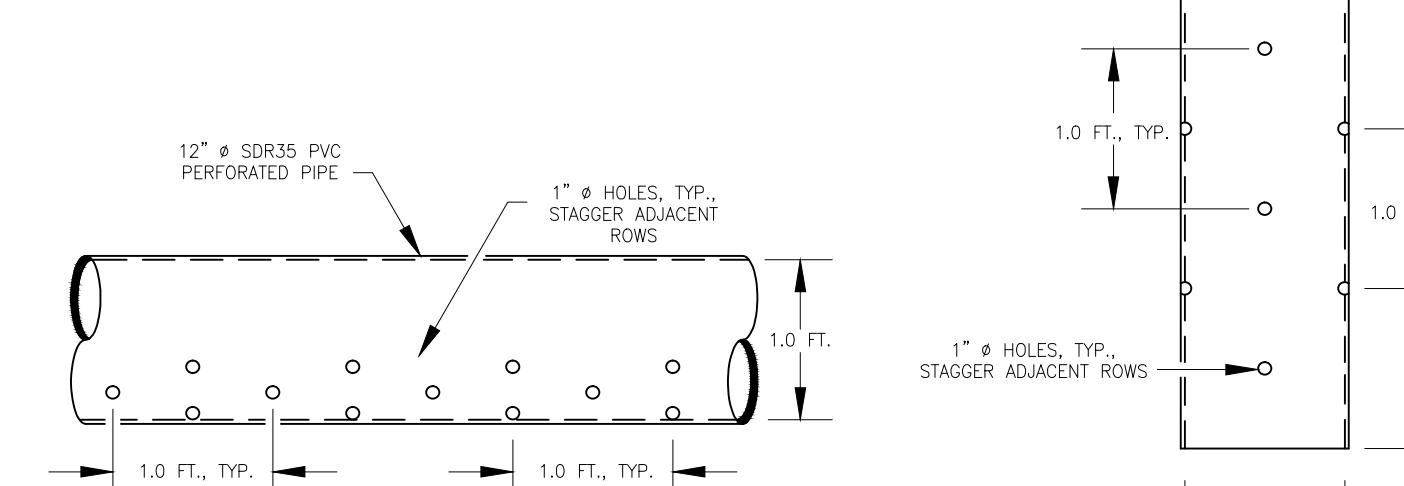

WET MINE SEAL OUTLET PIPES LONGITUDINAL VIEW

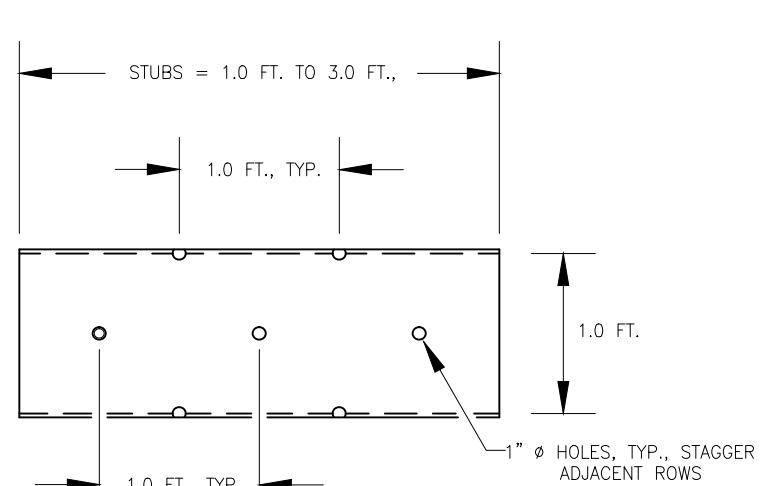

WET MINE SEAL STUBS
LONGITUDINAL VIEW.







AMIGO PORTALS

RALEIGH COUNTY, WV



TAC
TAC
JTG
CFS
DATE: January 14, 2014
PROJECT NUMBER: E130389

MINE SEAL DETAILS



REVISED

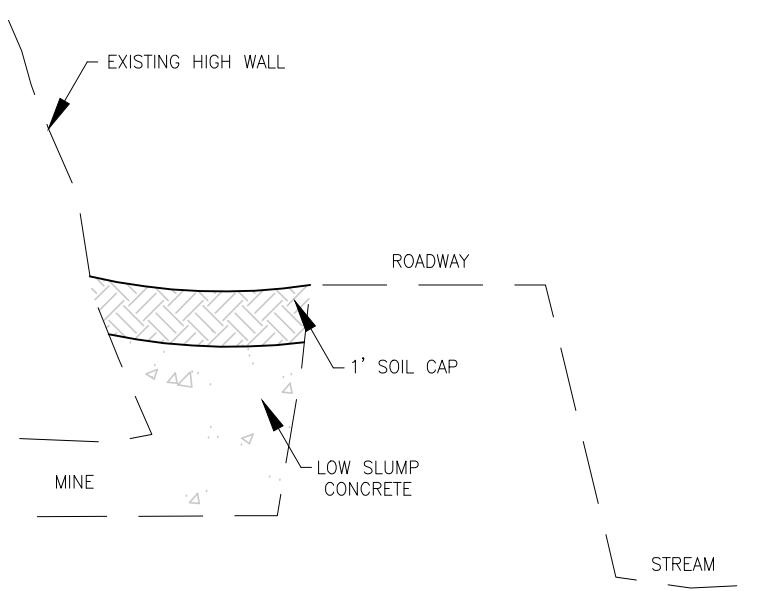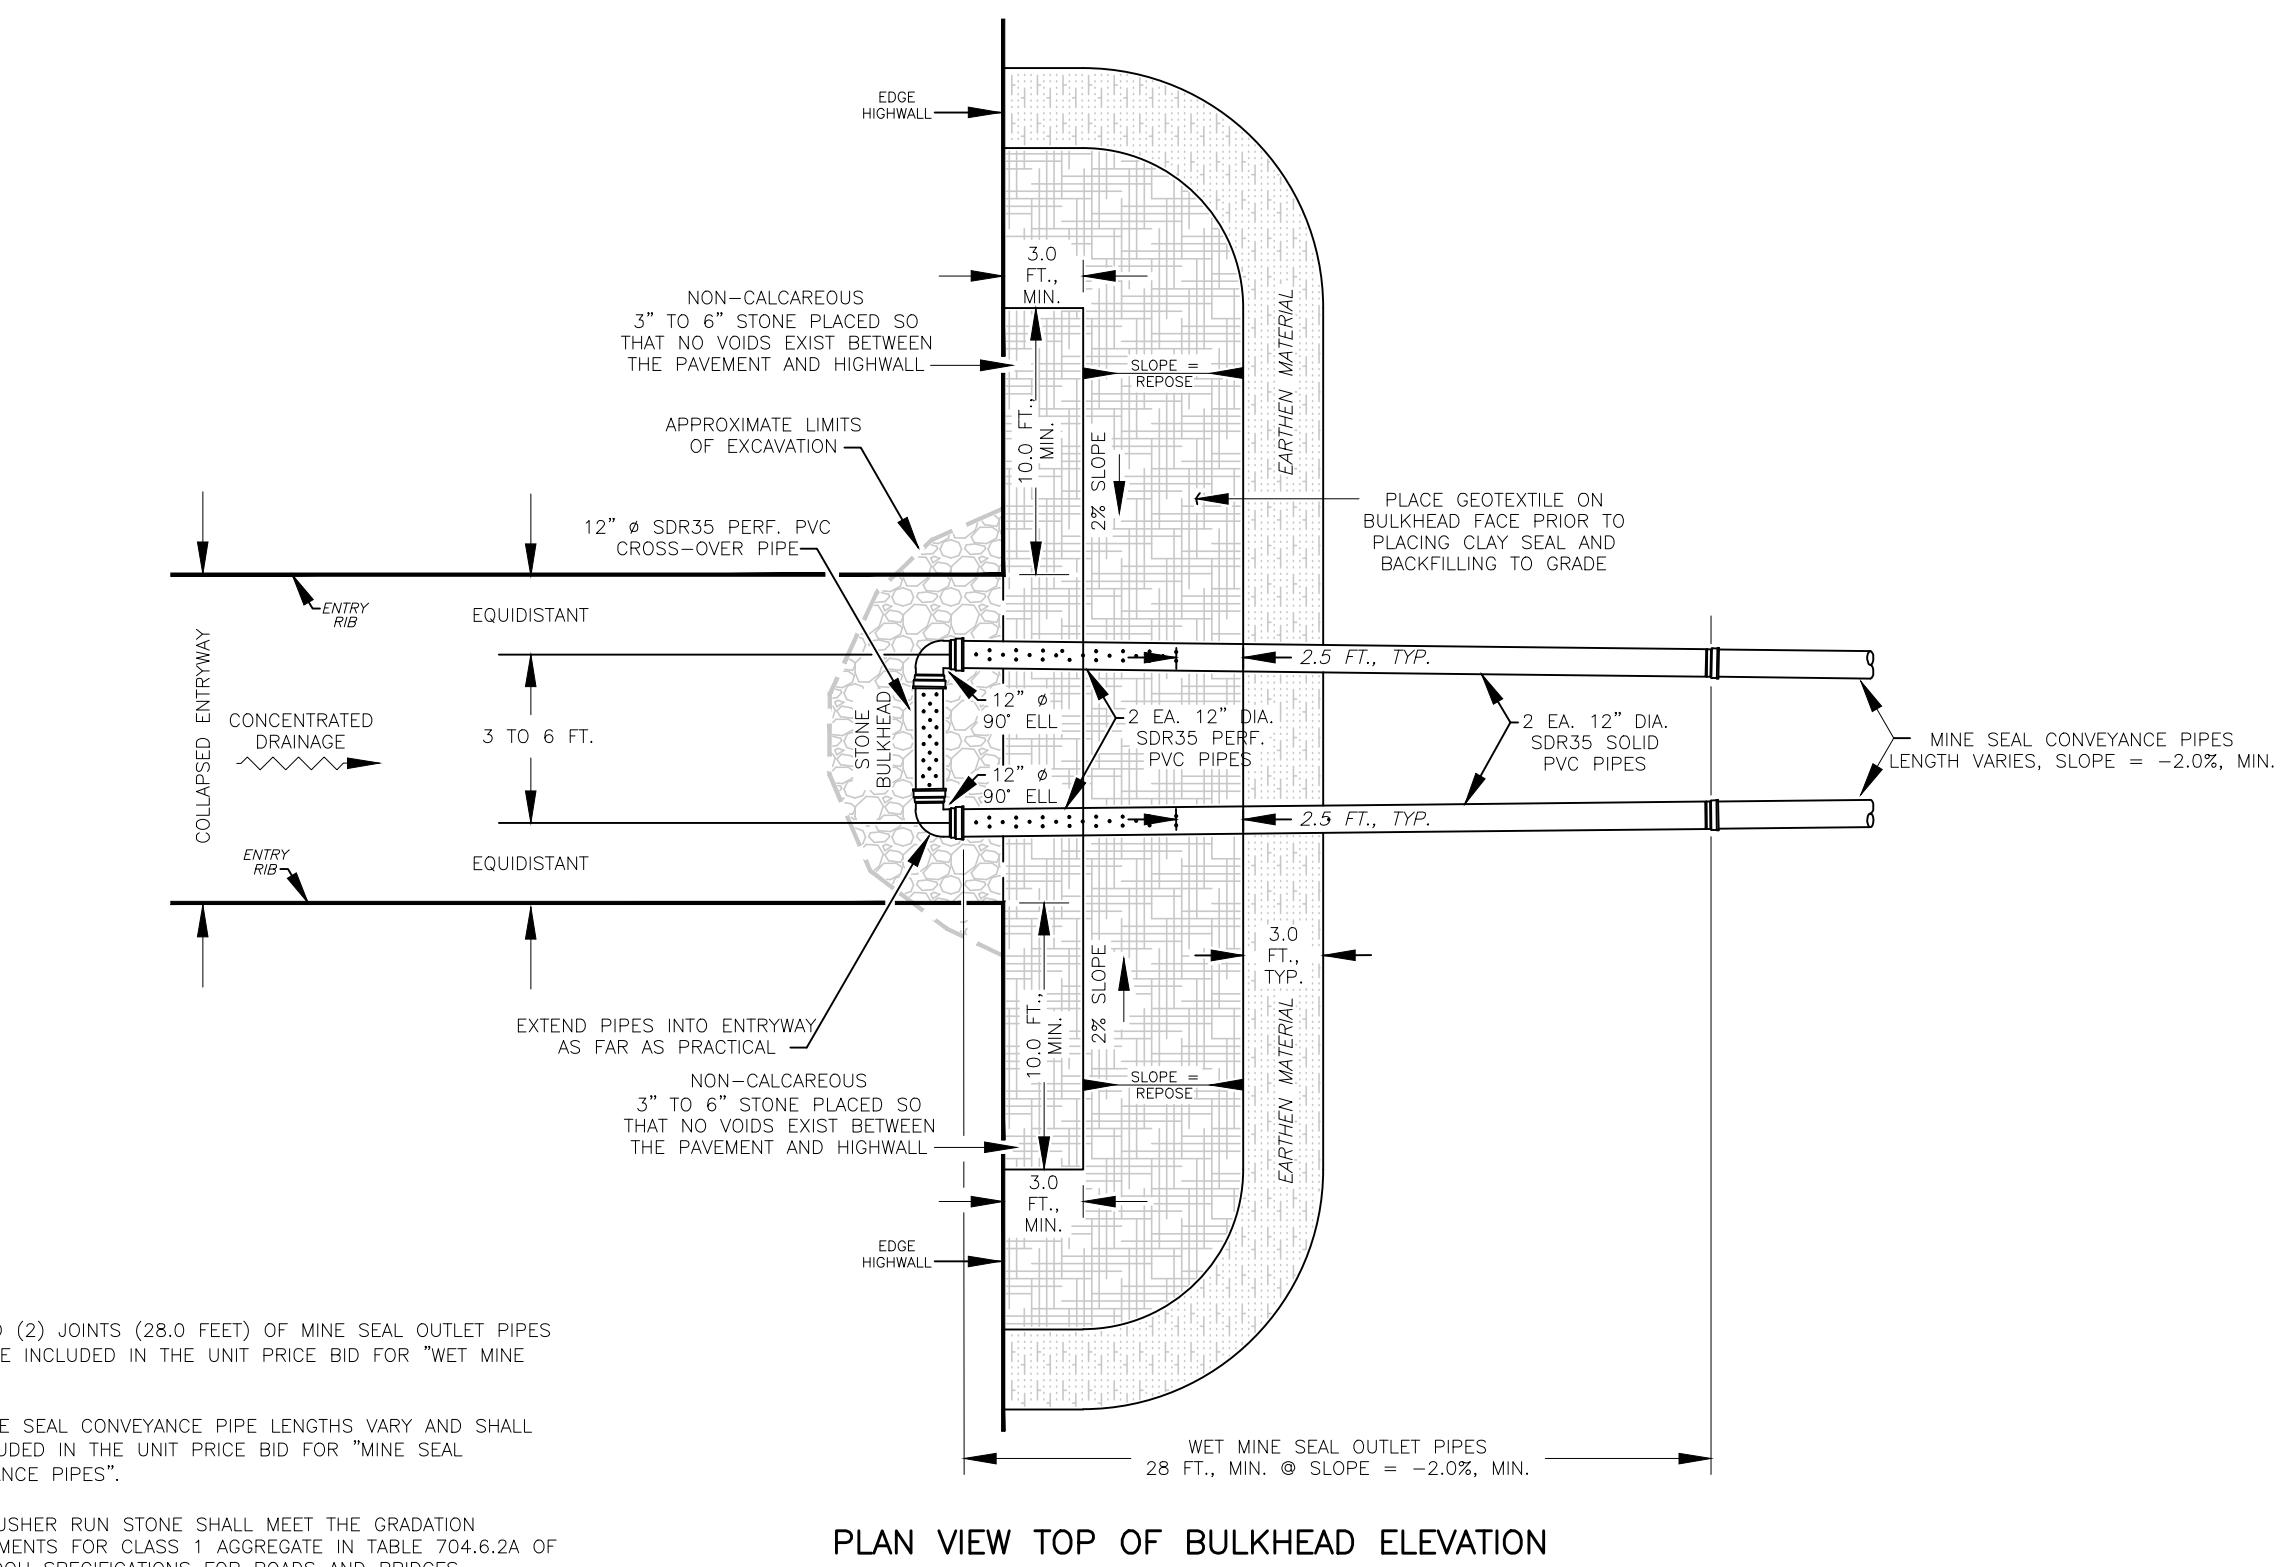SCALE AS SHOWN
DRAWING NUMBER
43LOW SLUMP CONCRETE DRY SEAL 3
43


PLAN VIEW TOP OF BULKHEAD ELEVATION

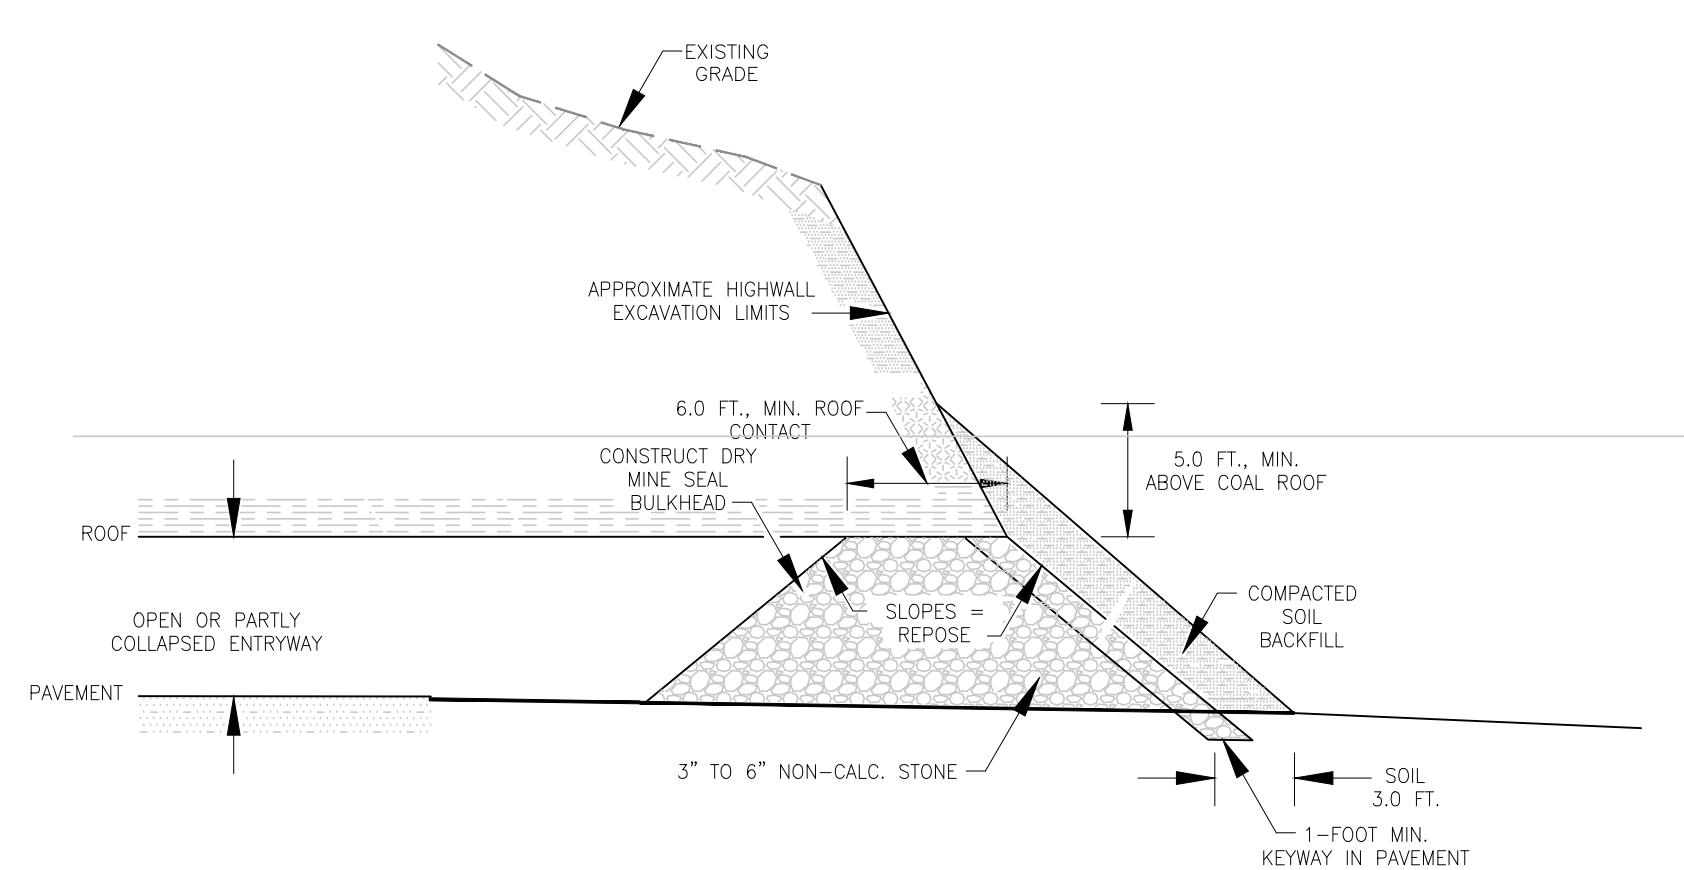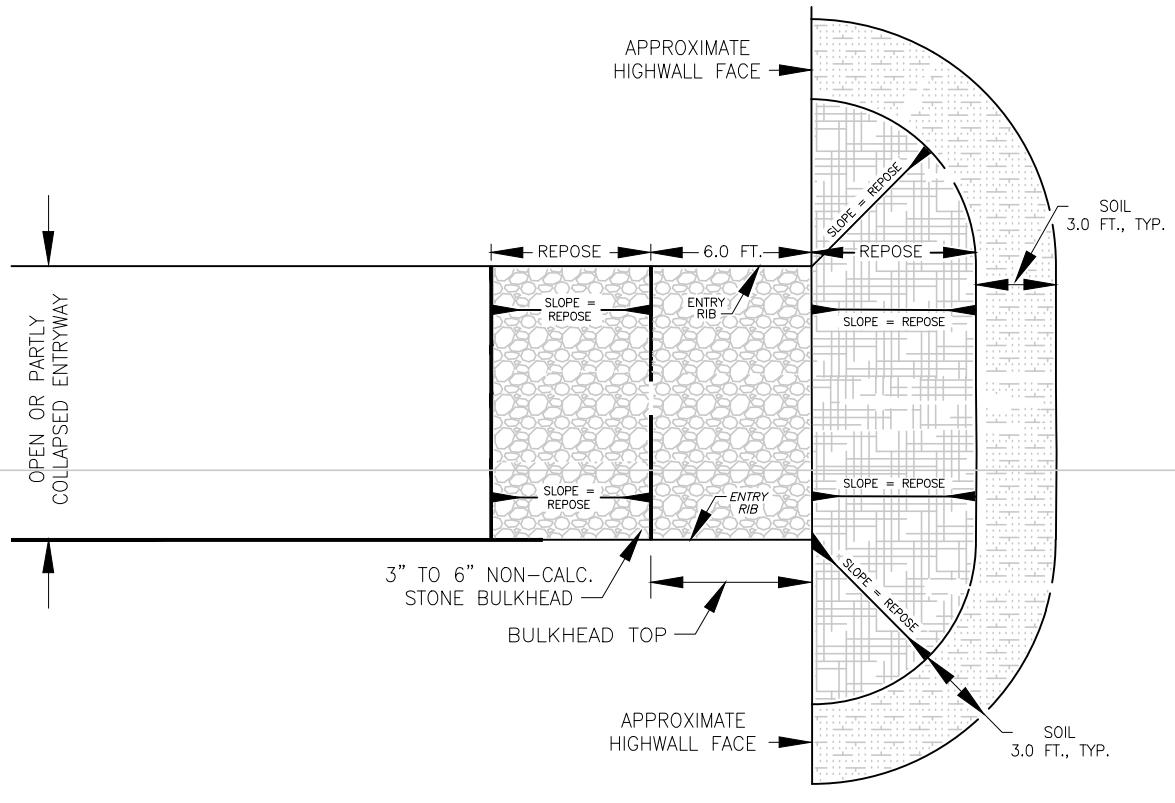PROFILE VIEW, TYP. 2
43


PLAN VIEW TOP OF BULKHEAD ELEVATION

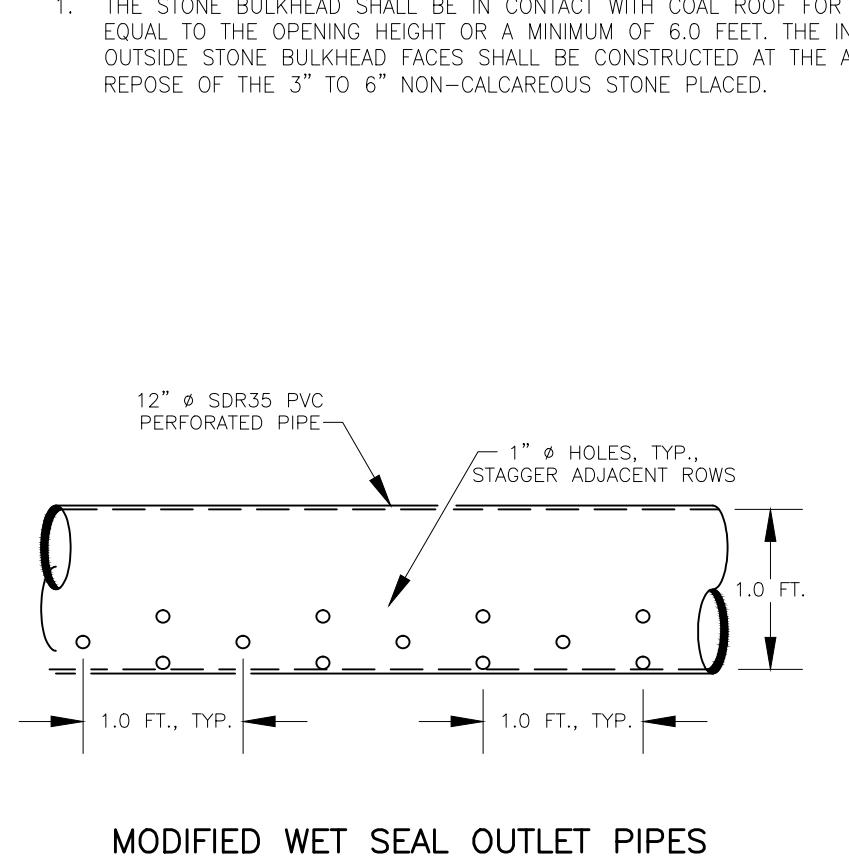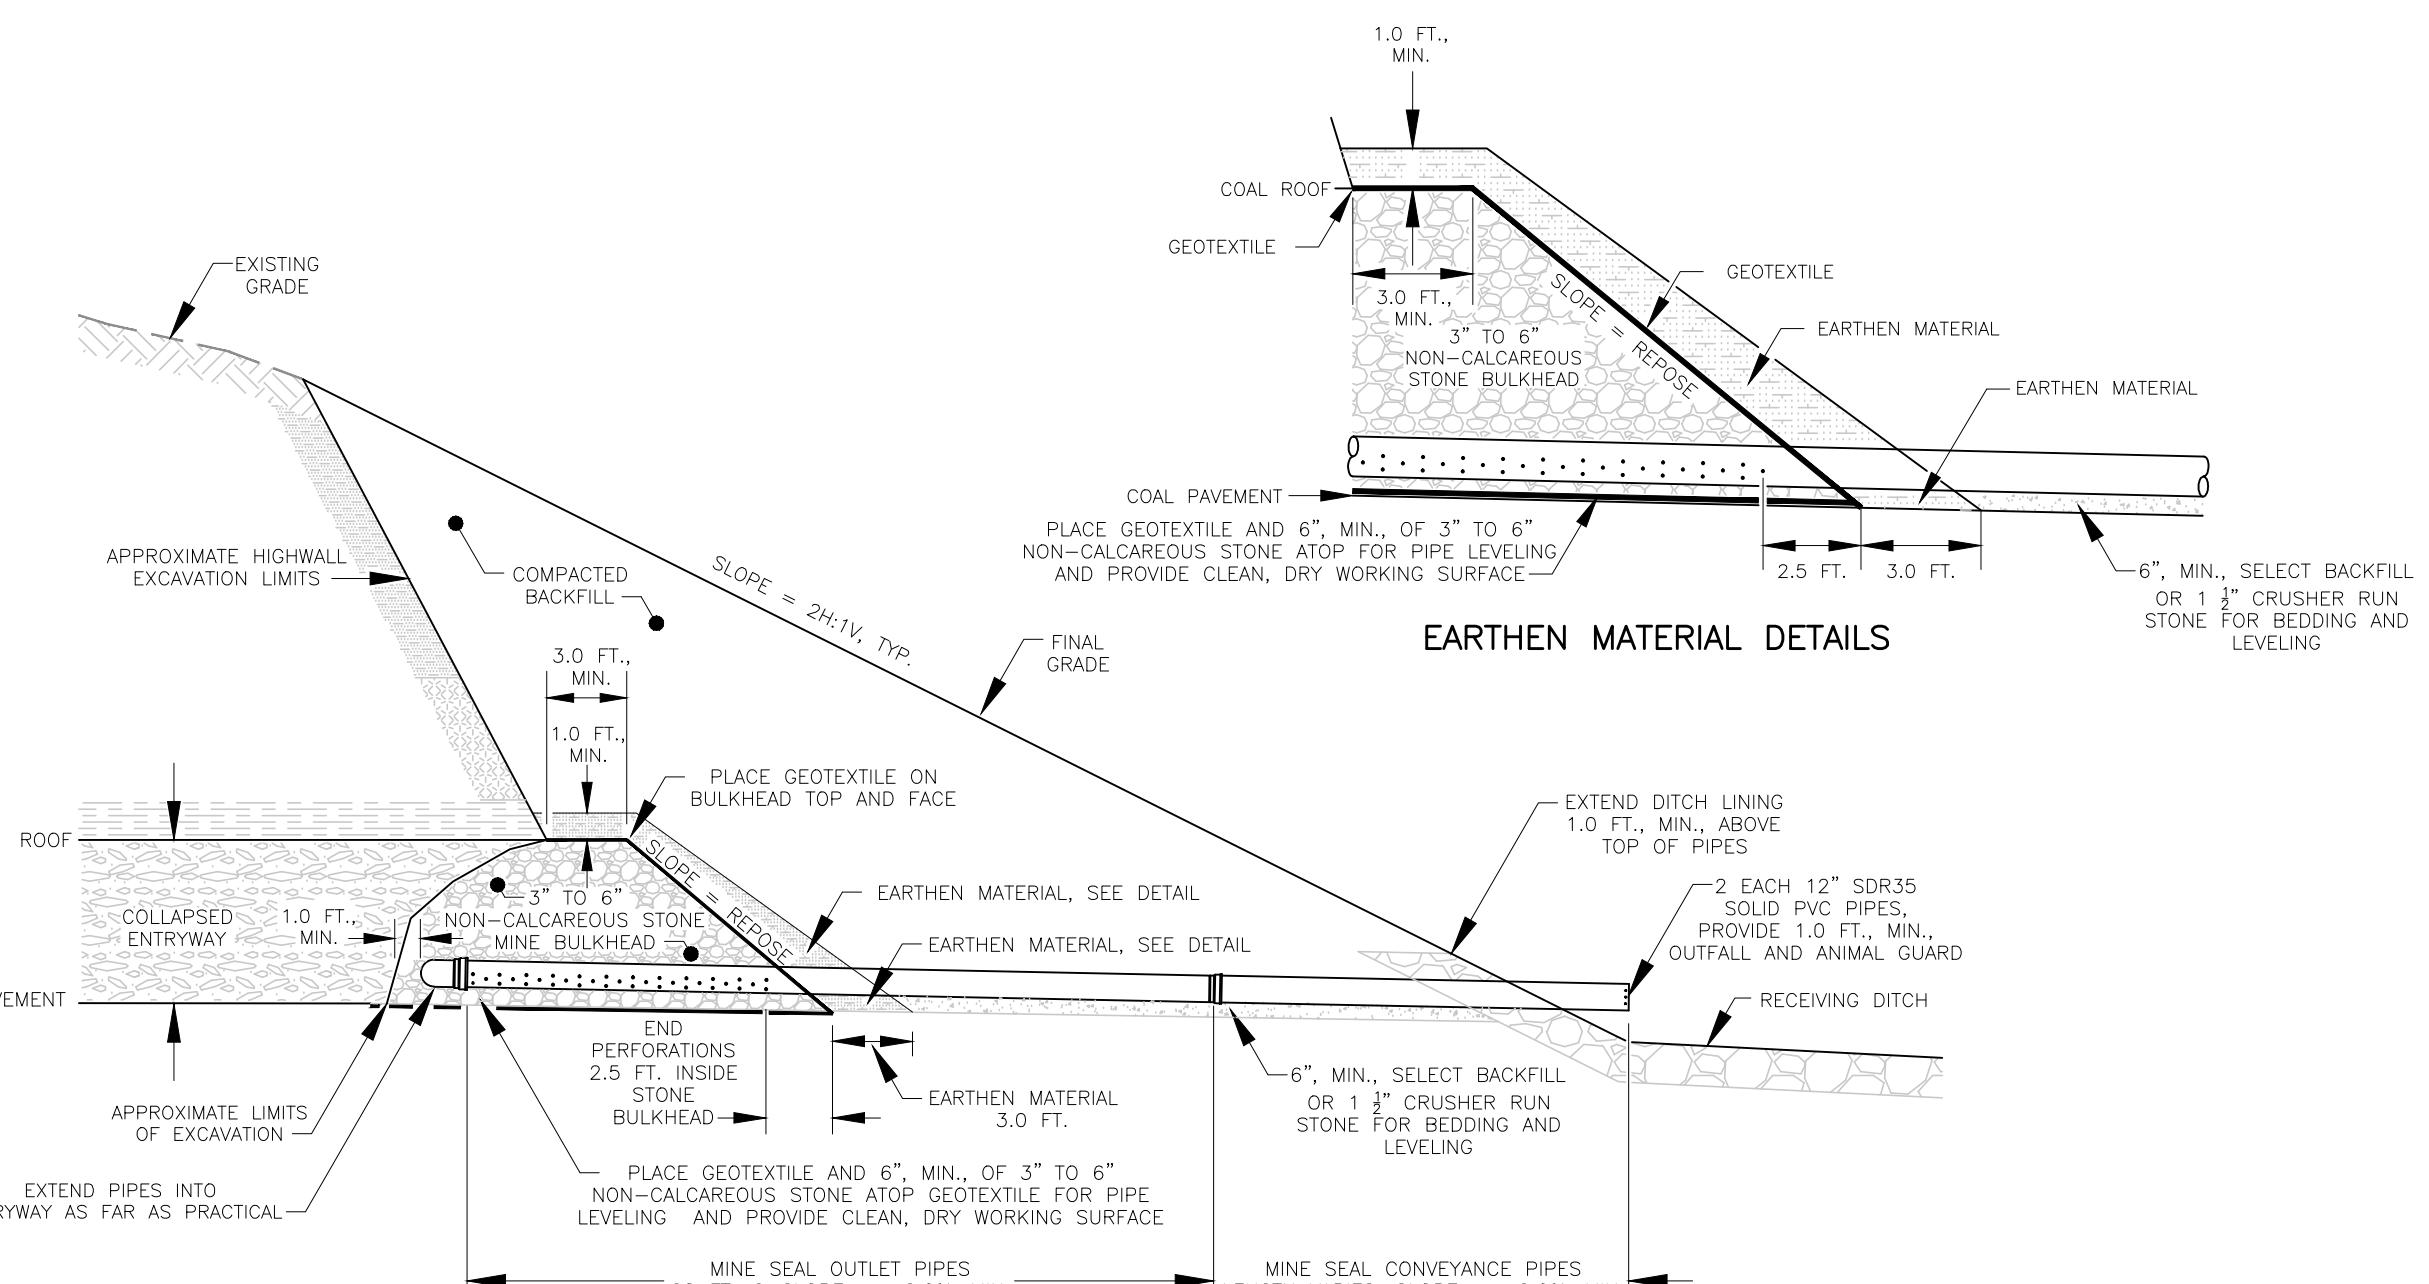


MODIFIED WET SEAL OUTLET PIPES LONGITUDINAL VIEW

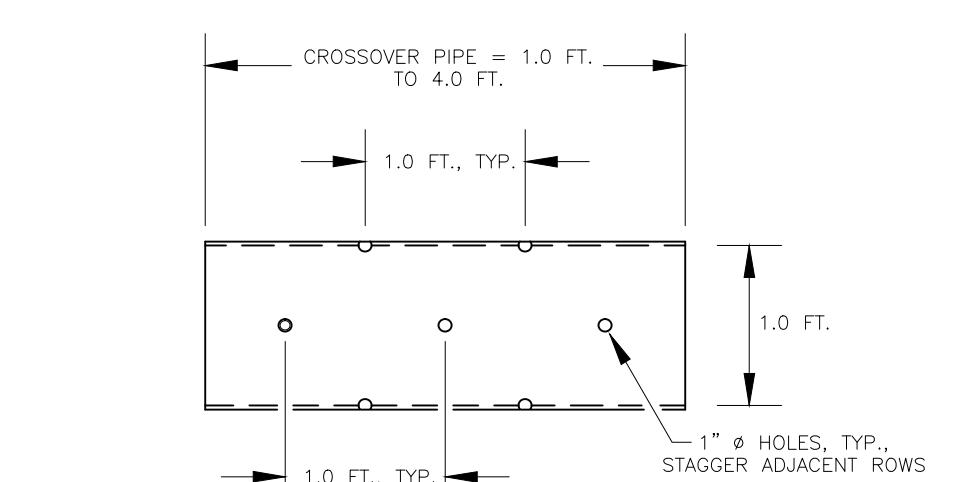

MODIFIED WET SEAL CROSS-OVER PIPE LONGITUDINAL VIEW

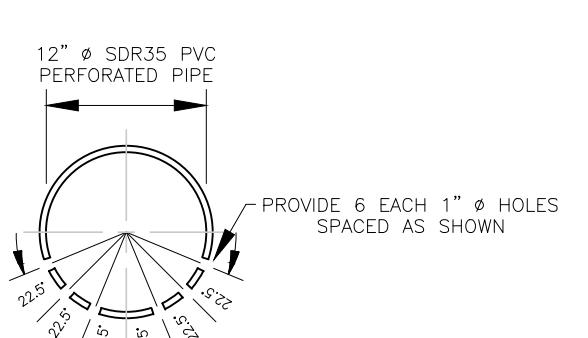


MODIFIED WET SEAL OUTLET PIPES CROSS SECTION

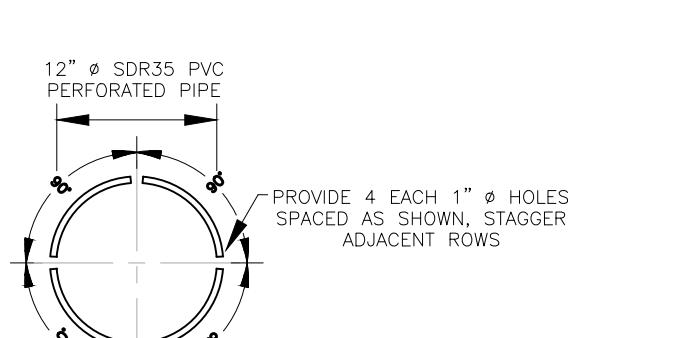


MODIFIED WET SEAL CROSS-OVER PIPE CROSS SECTION


MODIFIED WET SEAL 1
43MODIFIED WET SEAL PIPES NOT TO SCALE

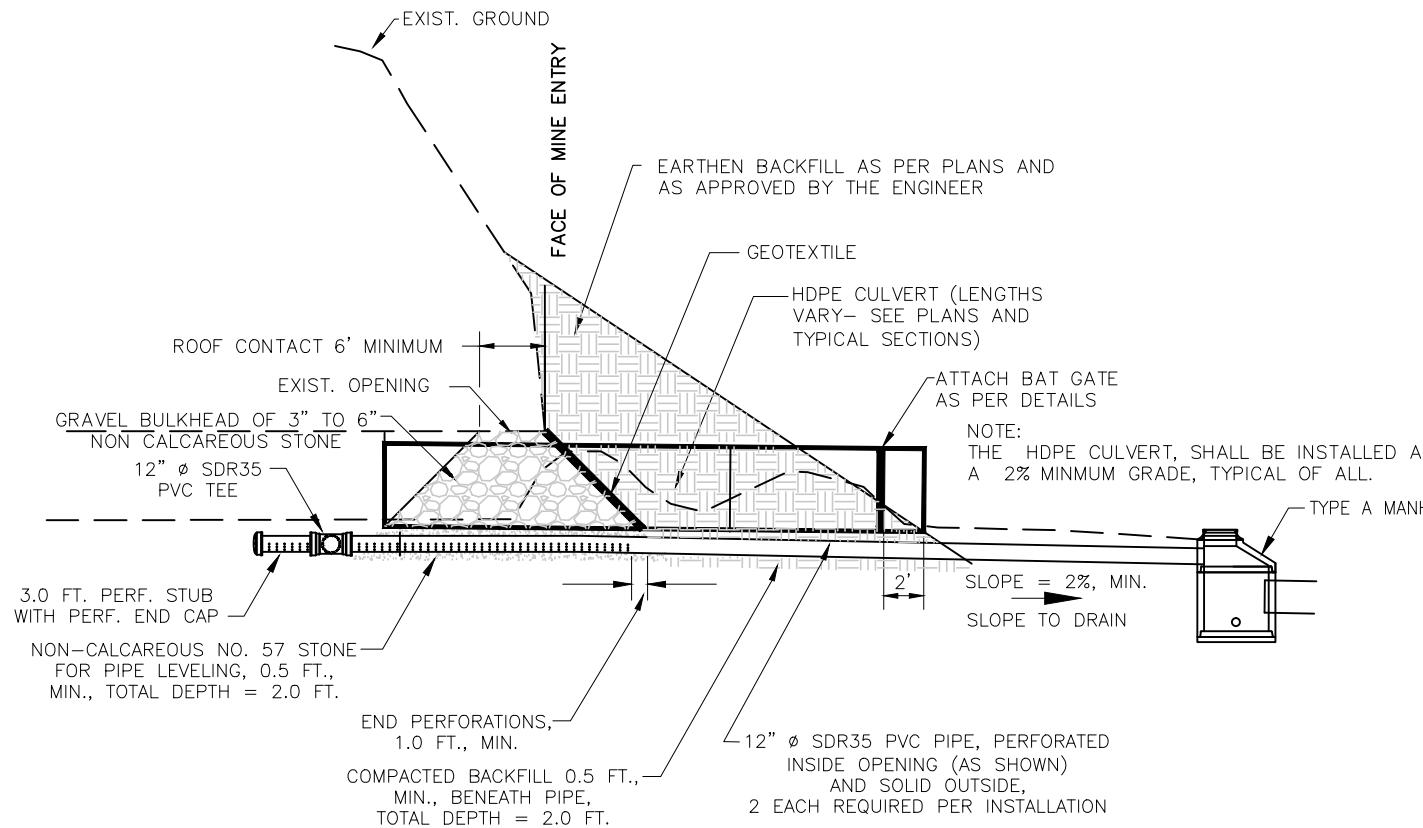


BAT GATE SEAL OUTLET PIPES CROSS SECTION

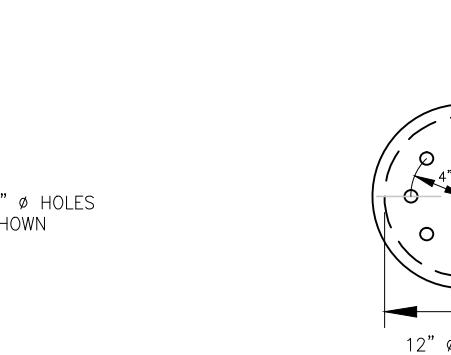


PERFORATED END CAP

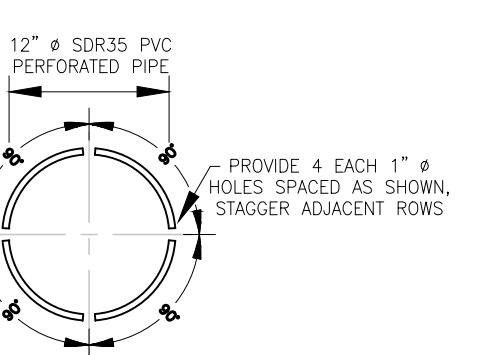

BAT GATE SEAL CROSS-OVER PIPE AND STUBS CROSS SECTION

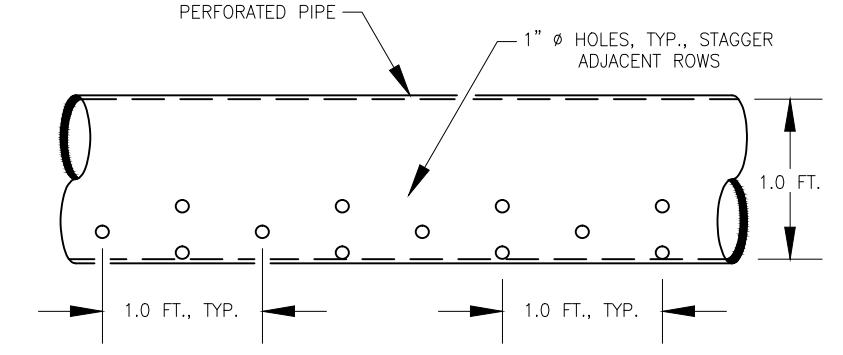


BAT GATE WITH DRAIN SEAL OUTLET PIPES LONGITUDINAL VIEW

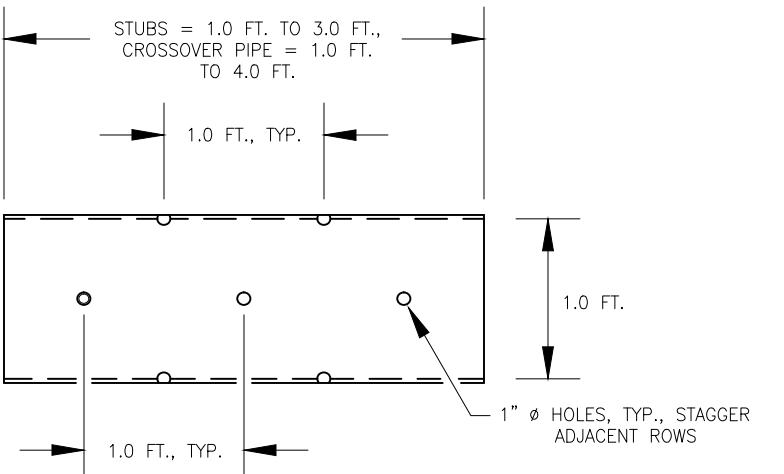

BAT GATE SEAL CROSS-OVER PIPE AND STUBS LONGITUDINAL VIEW


BAT GATE WITH DRAIN (ONLY TO BE USED ON PORTAL #4)

NOT TO SCALE

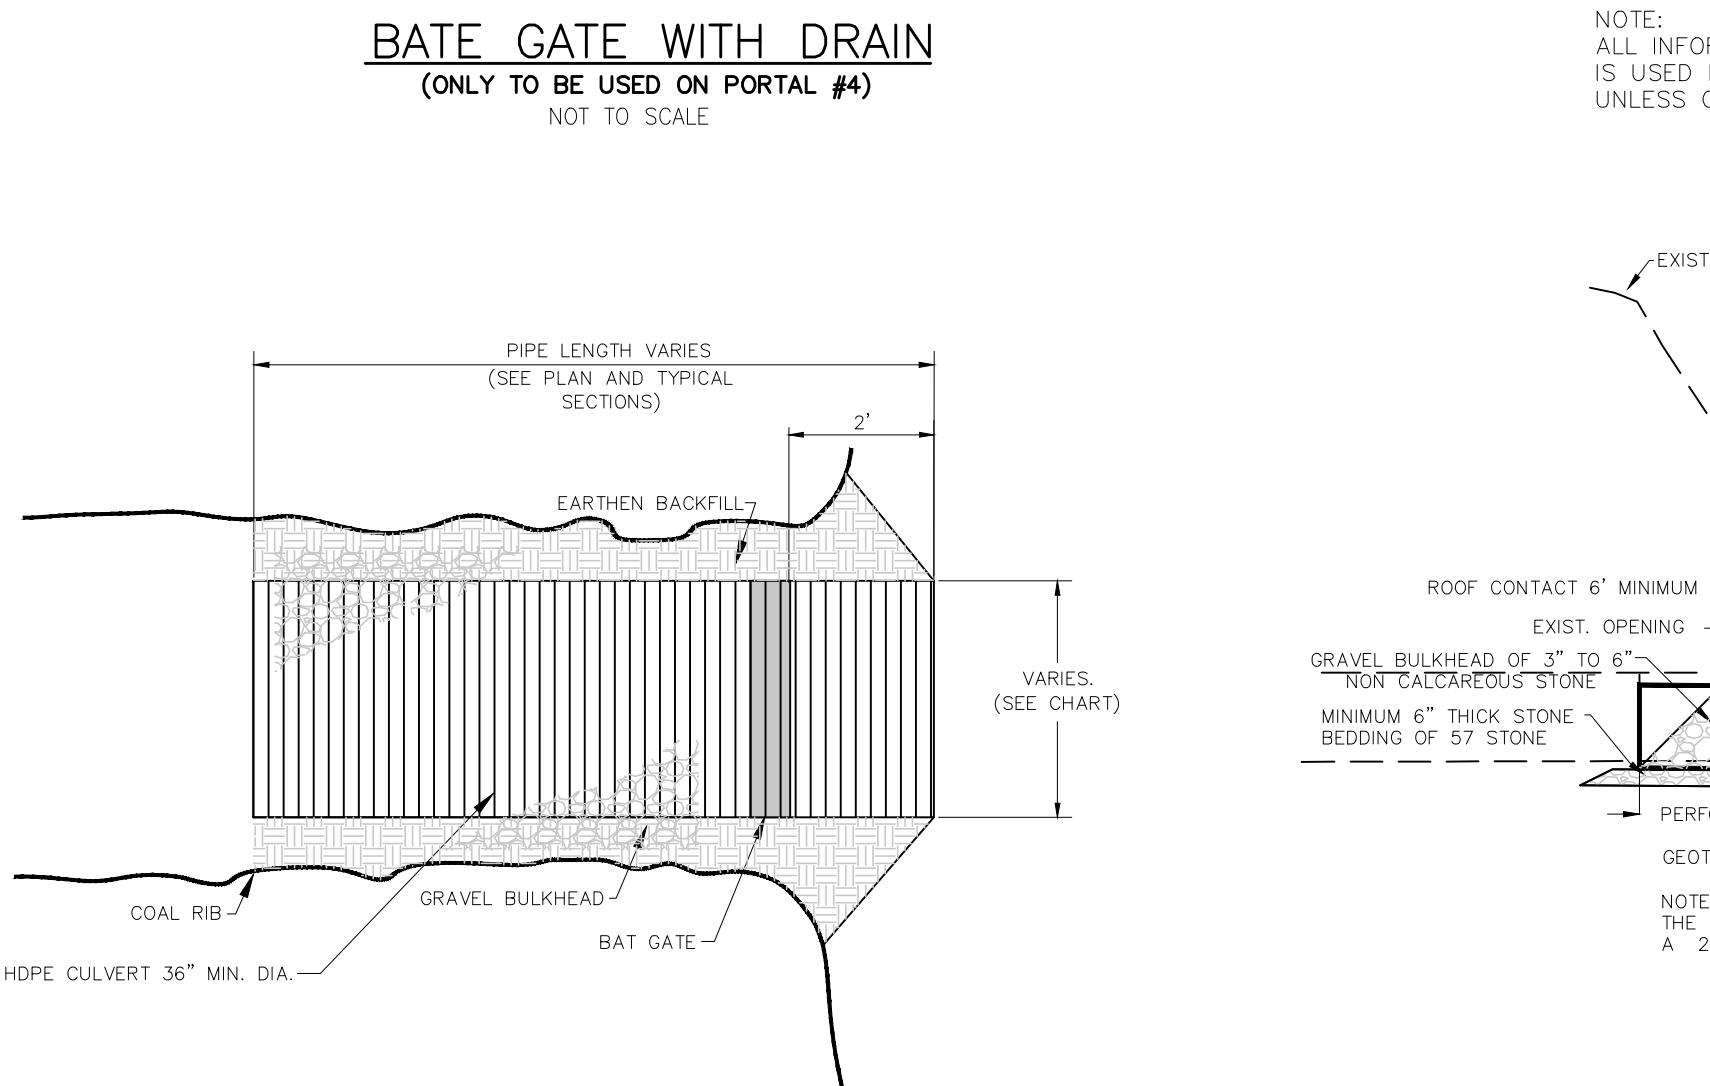


TYPICAL CONSTRUCTION DETAILS

(APPLICABLE TO ALL BAT GATES UNLESS NOTED)

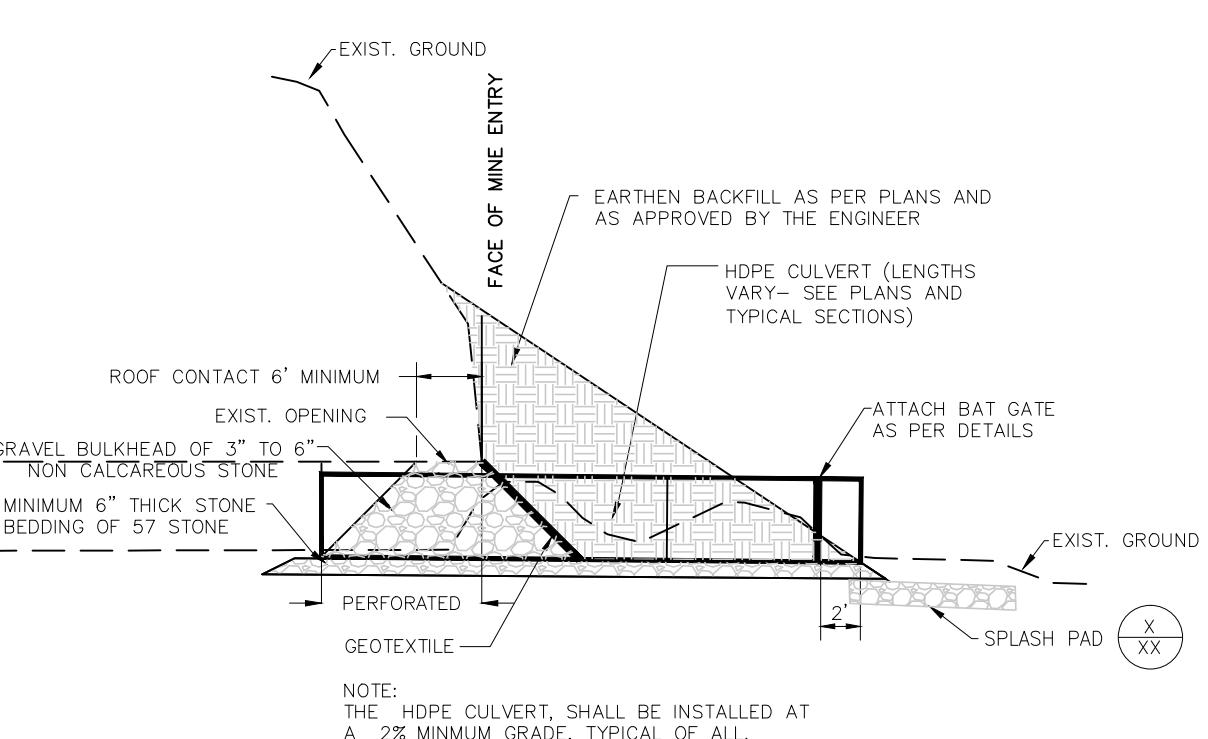

BAT GATE WITH DRAIN PIPES


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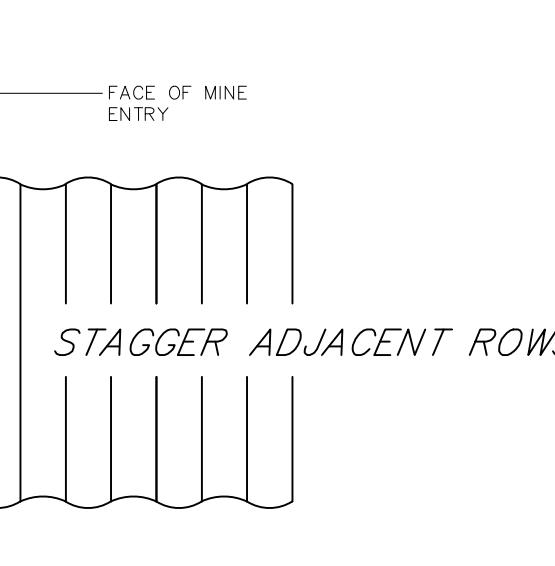
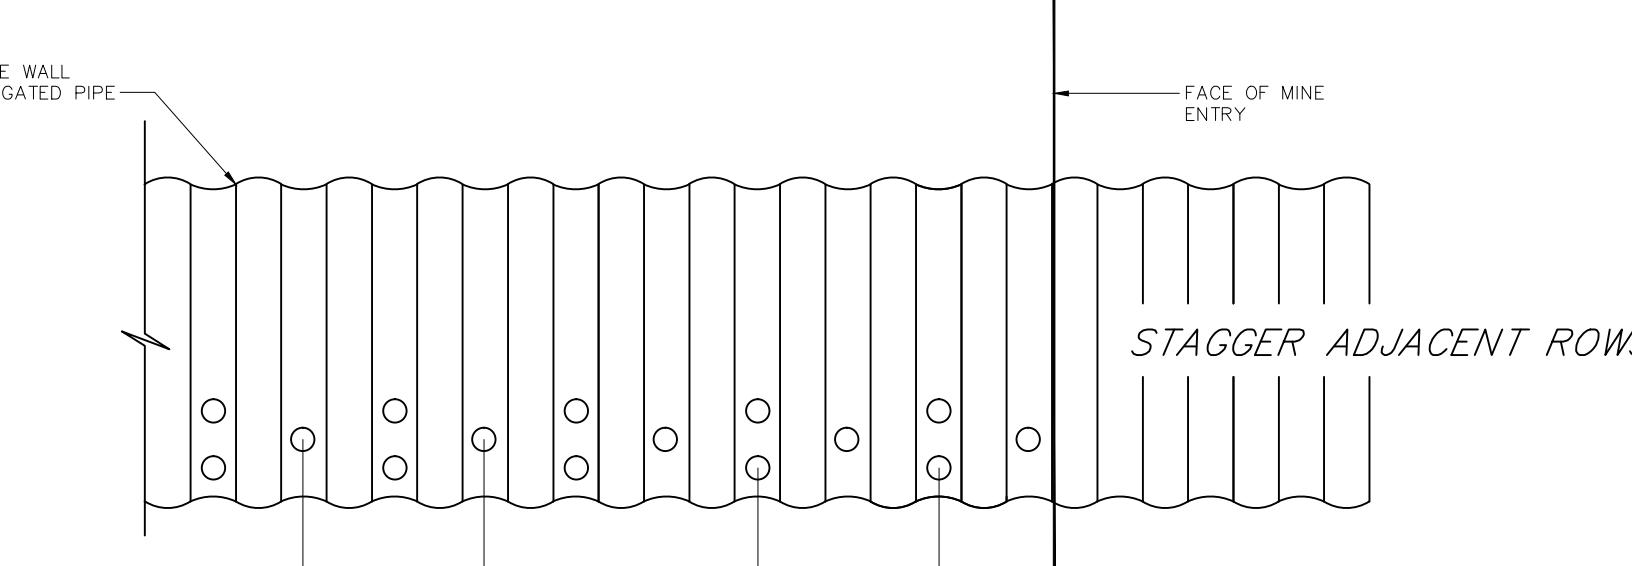
1

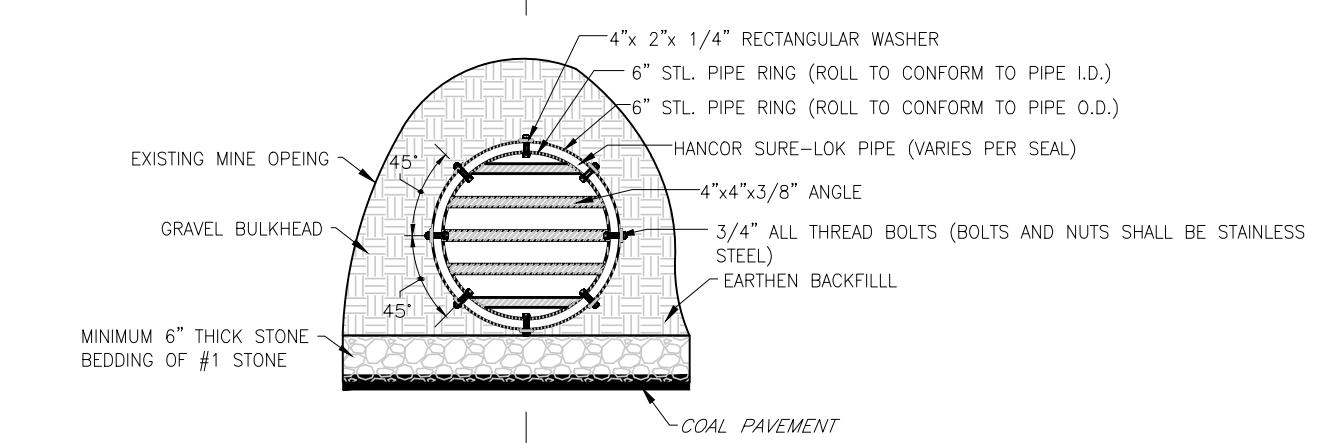HDPE PIPE	
PORTAL	PIPE (INCHES)
1	48
3	48
4	48
6	36
7	48
8	48
11	36
12	48
13	36
14	48
15	48
16	48


PLAN

NOTE:
PERFORATE ON PIPE WALLS NOT ON RIBS.


PERFORATION DETAIL

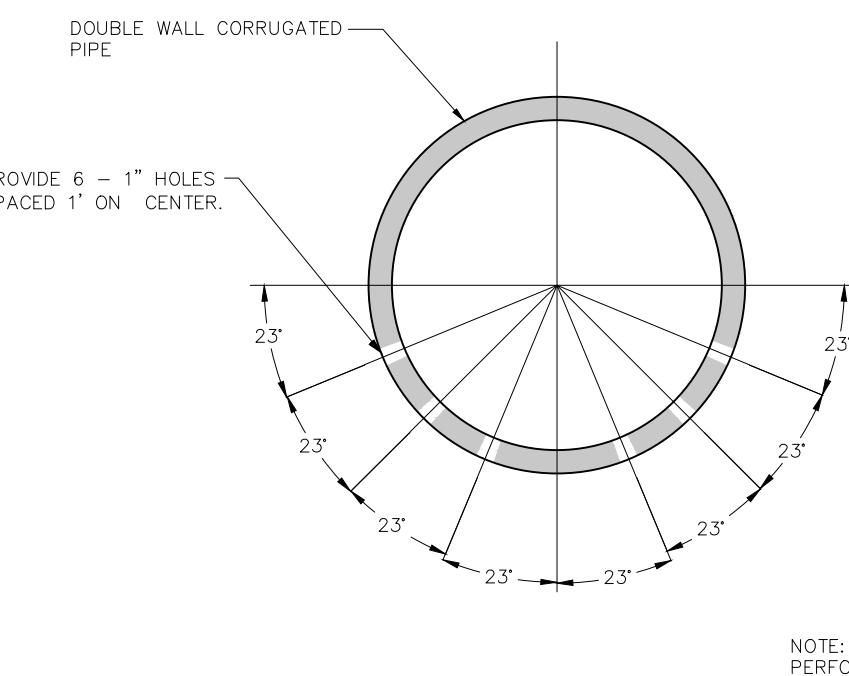

END VIEW

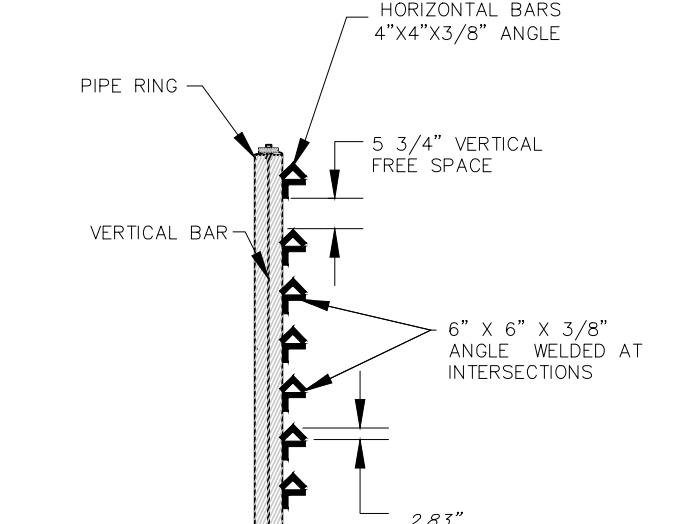


PIPE RING SECTION

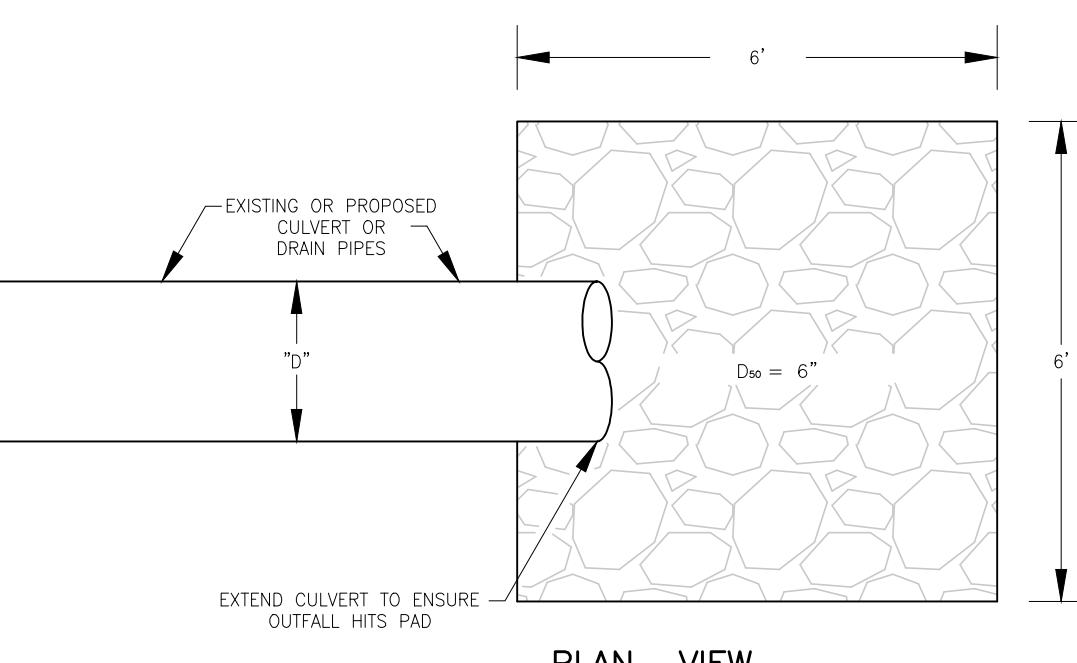



PLAN VIEW

VERTICAL BAR SIDE VIEW

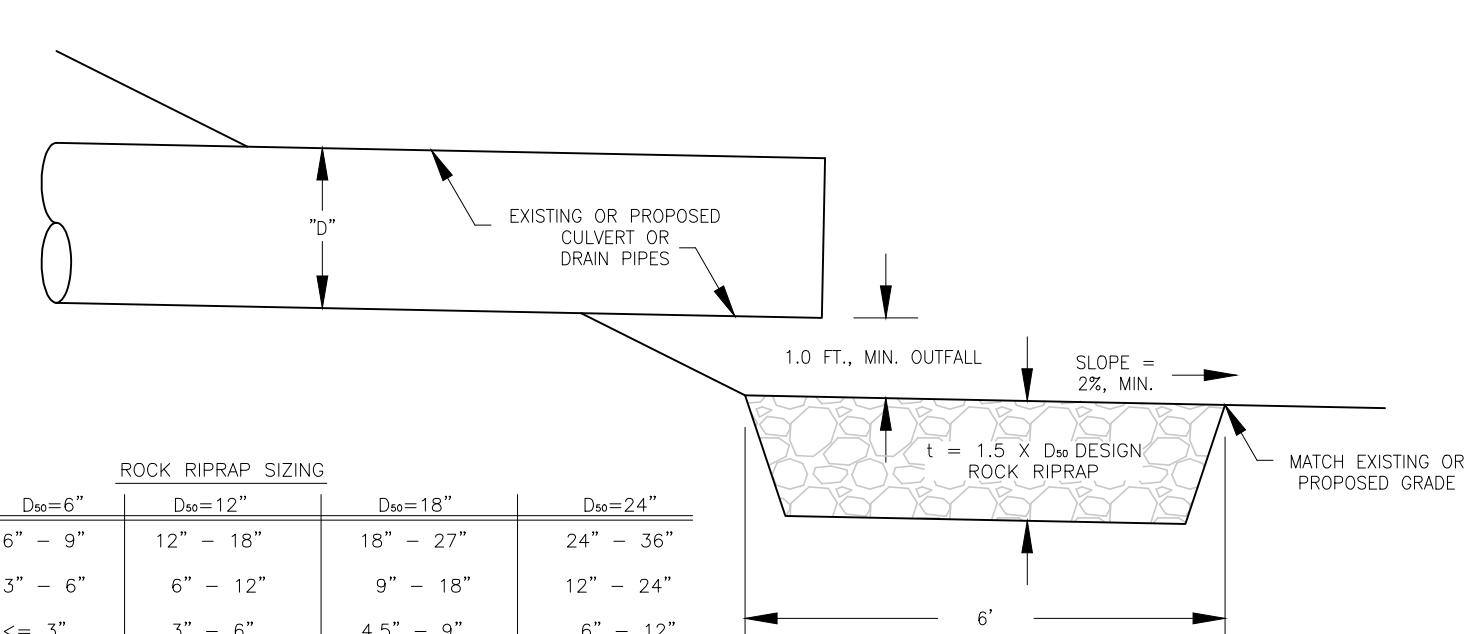

PROFILE

GRADATION	ROCK RIPRAP SIZING			
	D _o =6"	D _o =12"	D _o =18"	D _o =24"
50%	6"-9"	12"-18"	18"-27"	24"-36"
35%	3"-6"	6"-12"	9"-18"	12"-24"
15%	<= 3"	3"-6"	4.5"-9"	6"-12"

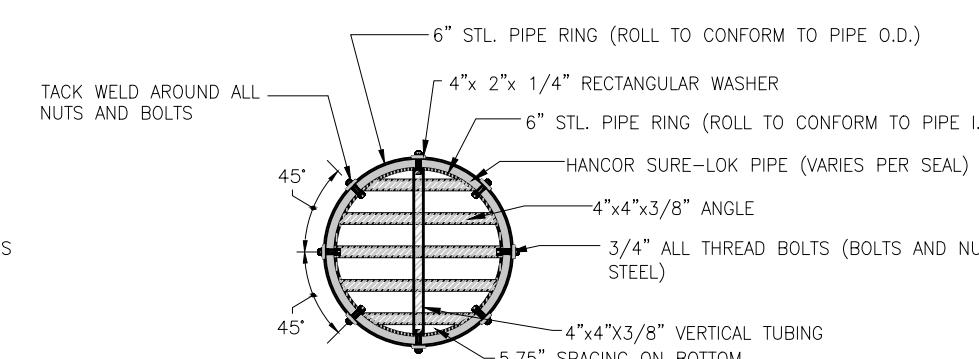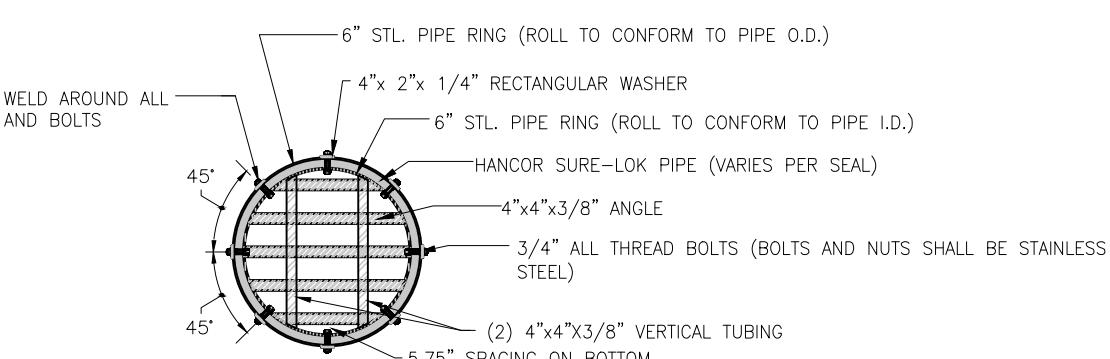GATE DETAIL
(CULVERT 36"-42" DIA)GATE DETAIL
(CULVERT 48"-60")GATE DETAIL
(CULVERT GREATER THAN 60" DIA)

NOTE:
HORIZONTAL BAR SPACINGS ARE NOT TO BE ALTERED. AN ADDITIONAL HORIZONTAL "FLAT" BAR MAY BE REQUIRED TO MAINTAIN SPACINGS THROUGH THE MINE SEAL. THIS IS THE ENGINEER'S RESPONSIBILITY. THESE MODIFICATIONS ARE TO BE APPROVED BY THE ENGINEER PRIOR TO BEING PERFORMED.

1

BAT GATE 1
44SPLASH PAD 2
44

NOTES:
"D" = CULVERT DIAMETER
"t" = THICKNESS

SCALE
AS SHOWN
DRAWING NUMBER
44