





DRAWING	1	COVER SHEET AND INDEX
DRAWING	2	OVERALL SITE PLAN
DRAWING	<b>2</b> A	COMPOSITE SITE MAP
DRAWING	3-5	EXISTING CONDITIONS
DRAWINGS	6-8	RECLAMATION PLANS
DRAWINGS	9	SOIL BORROW PLAN
DRAWINGS	10-12	CHANNEL PROFILES
DRAWINGS	13-24	BASELINE "A" CROSS SECTIONS
DRAWINGS	25	BASELINE "B" CROSS SECTIONS
DRAWINGS	26-28	EROSION AND SEDIMENT CONTROL PLANS
DRAWINGS	29-31	TAX MAP OVERLAYS
DRAWINGS	32-34	MISCELLANEOUS DETAILS

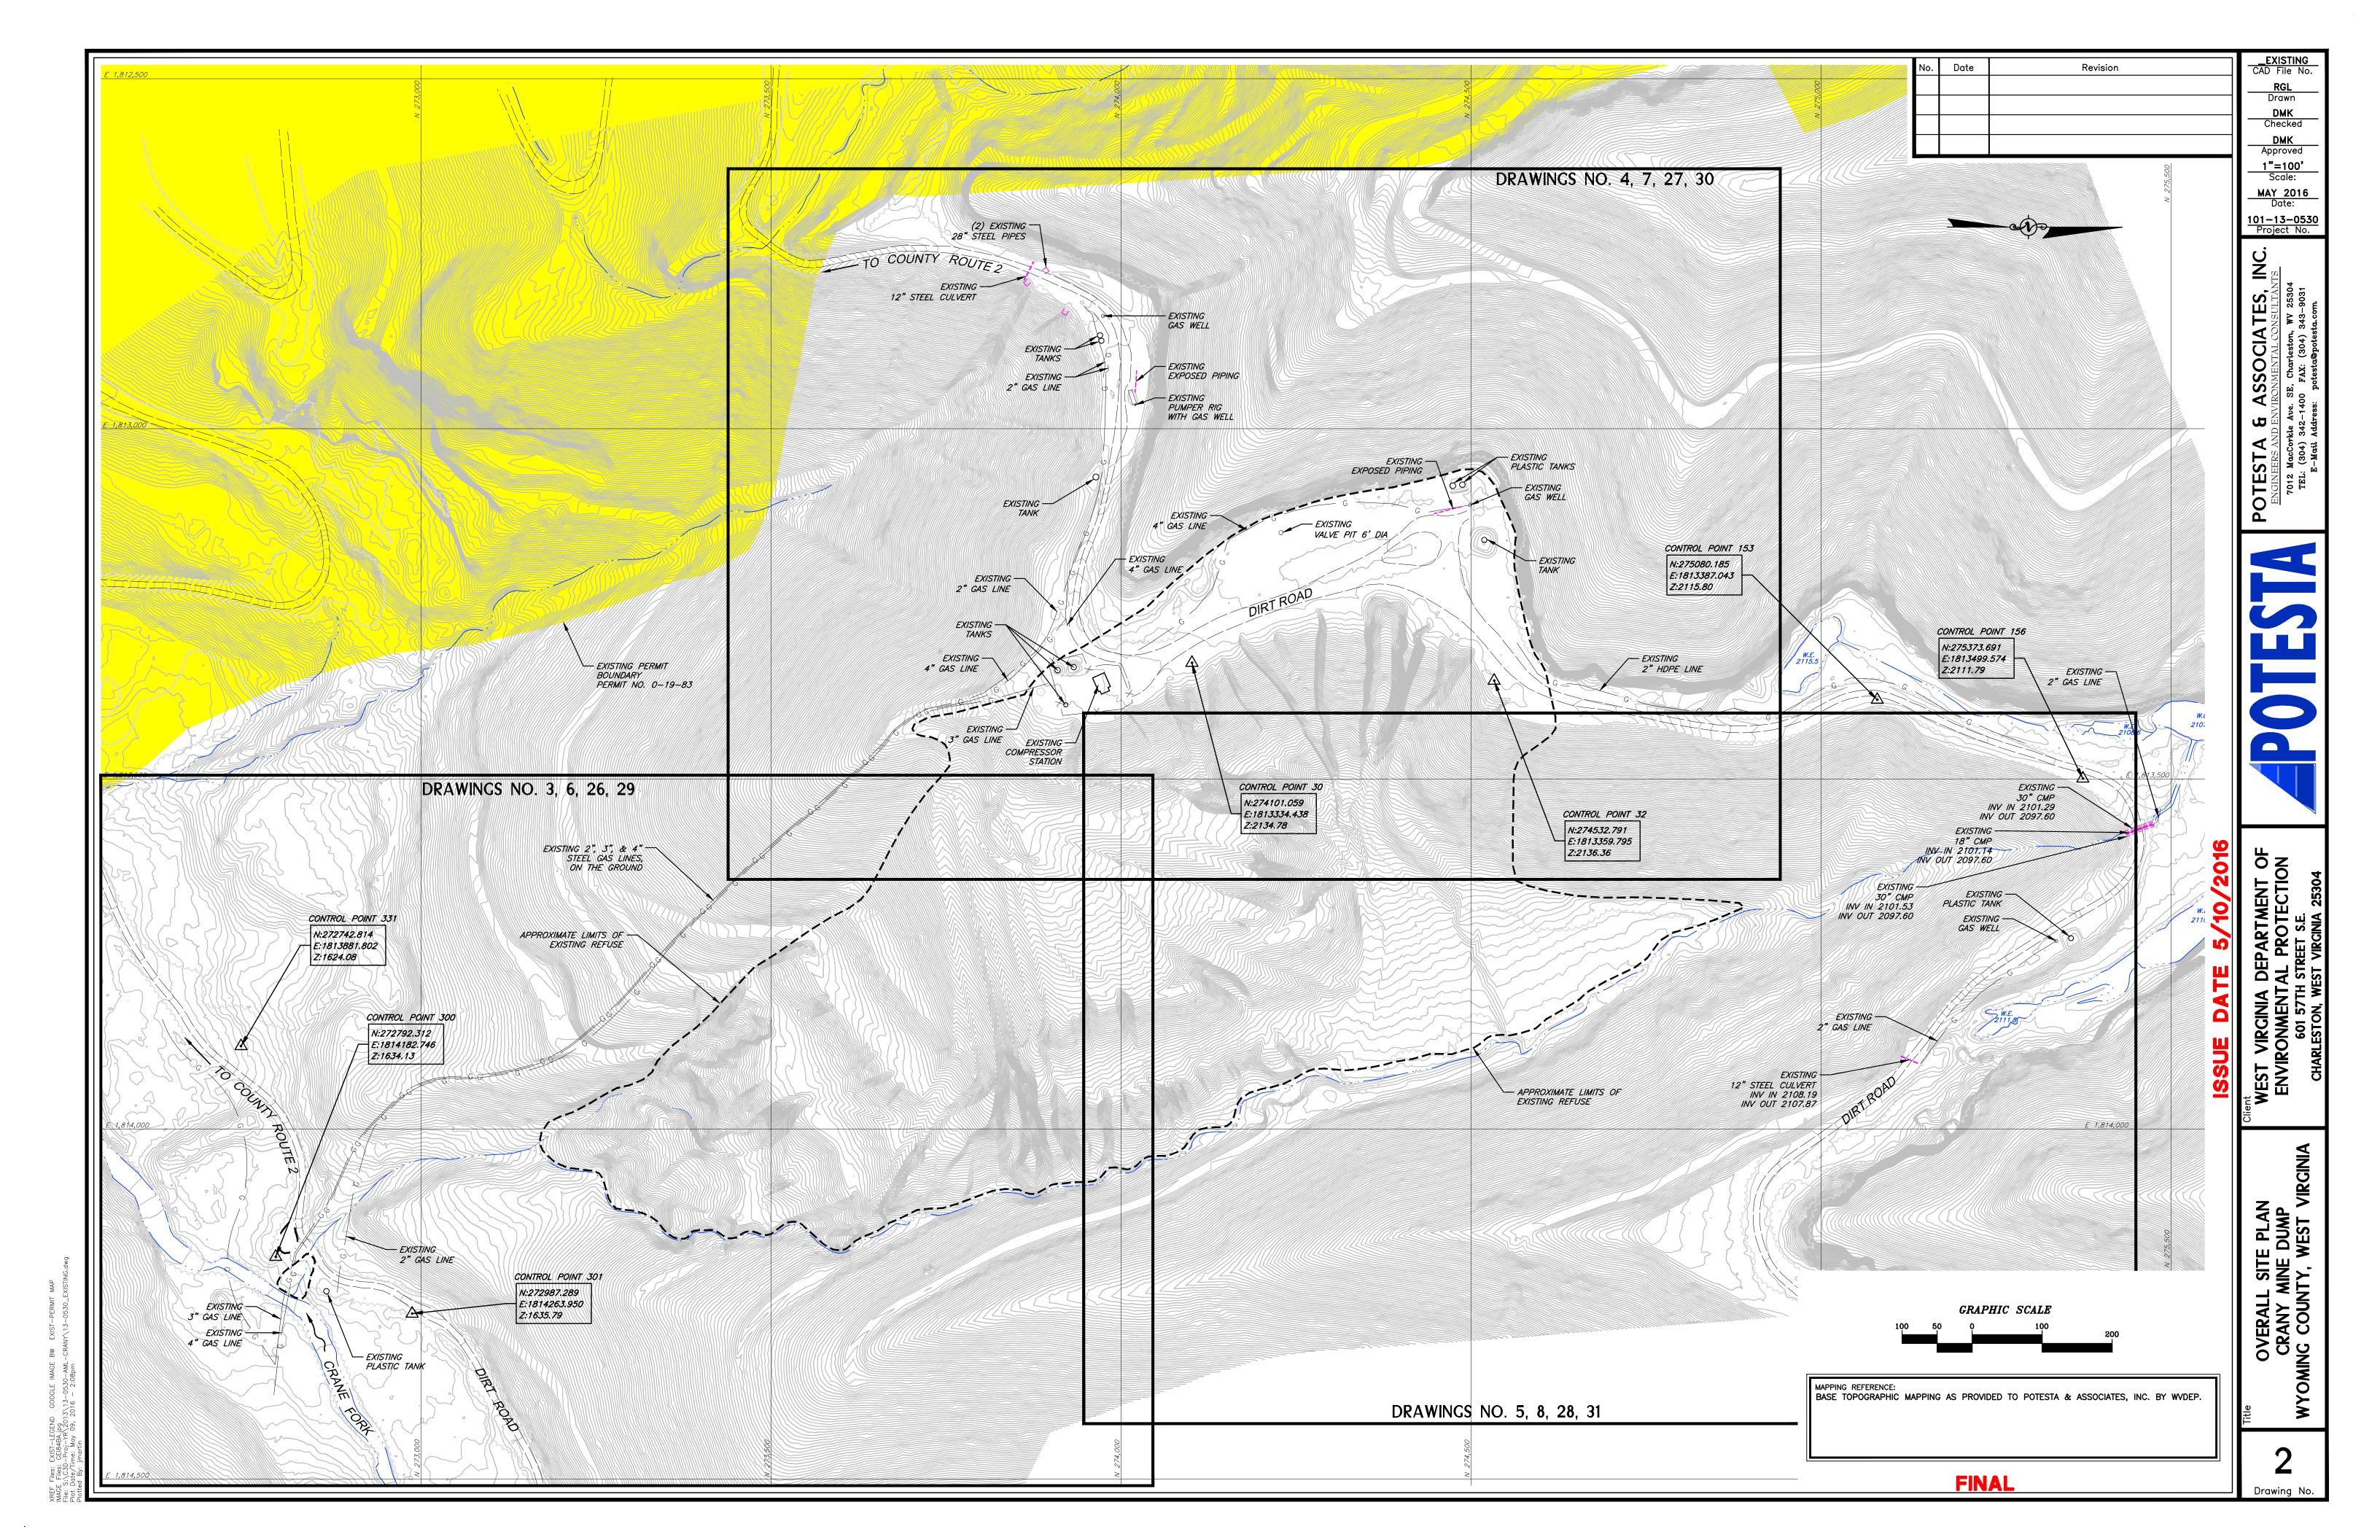


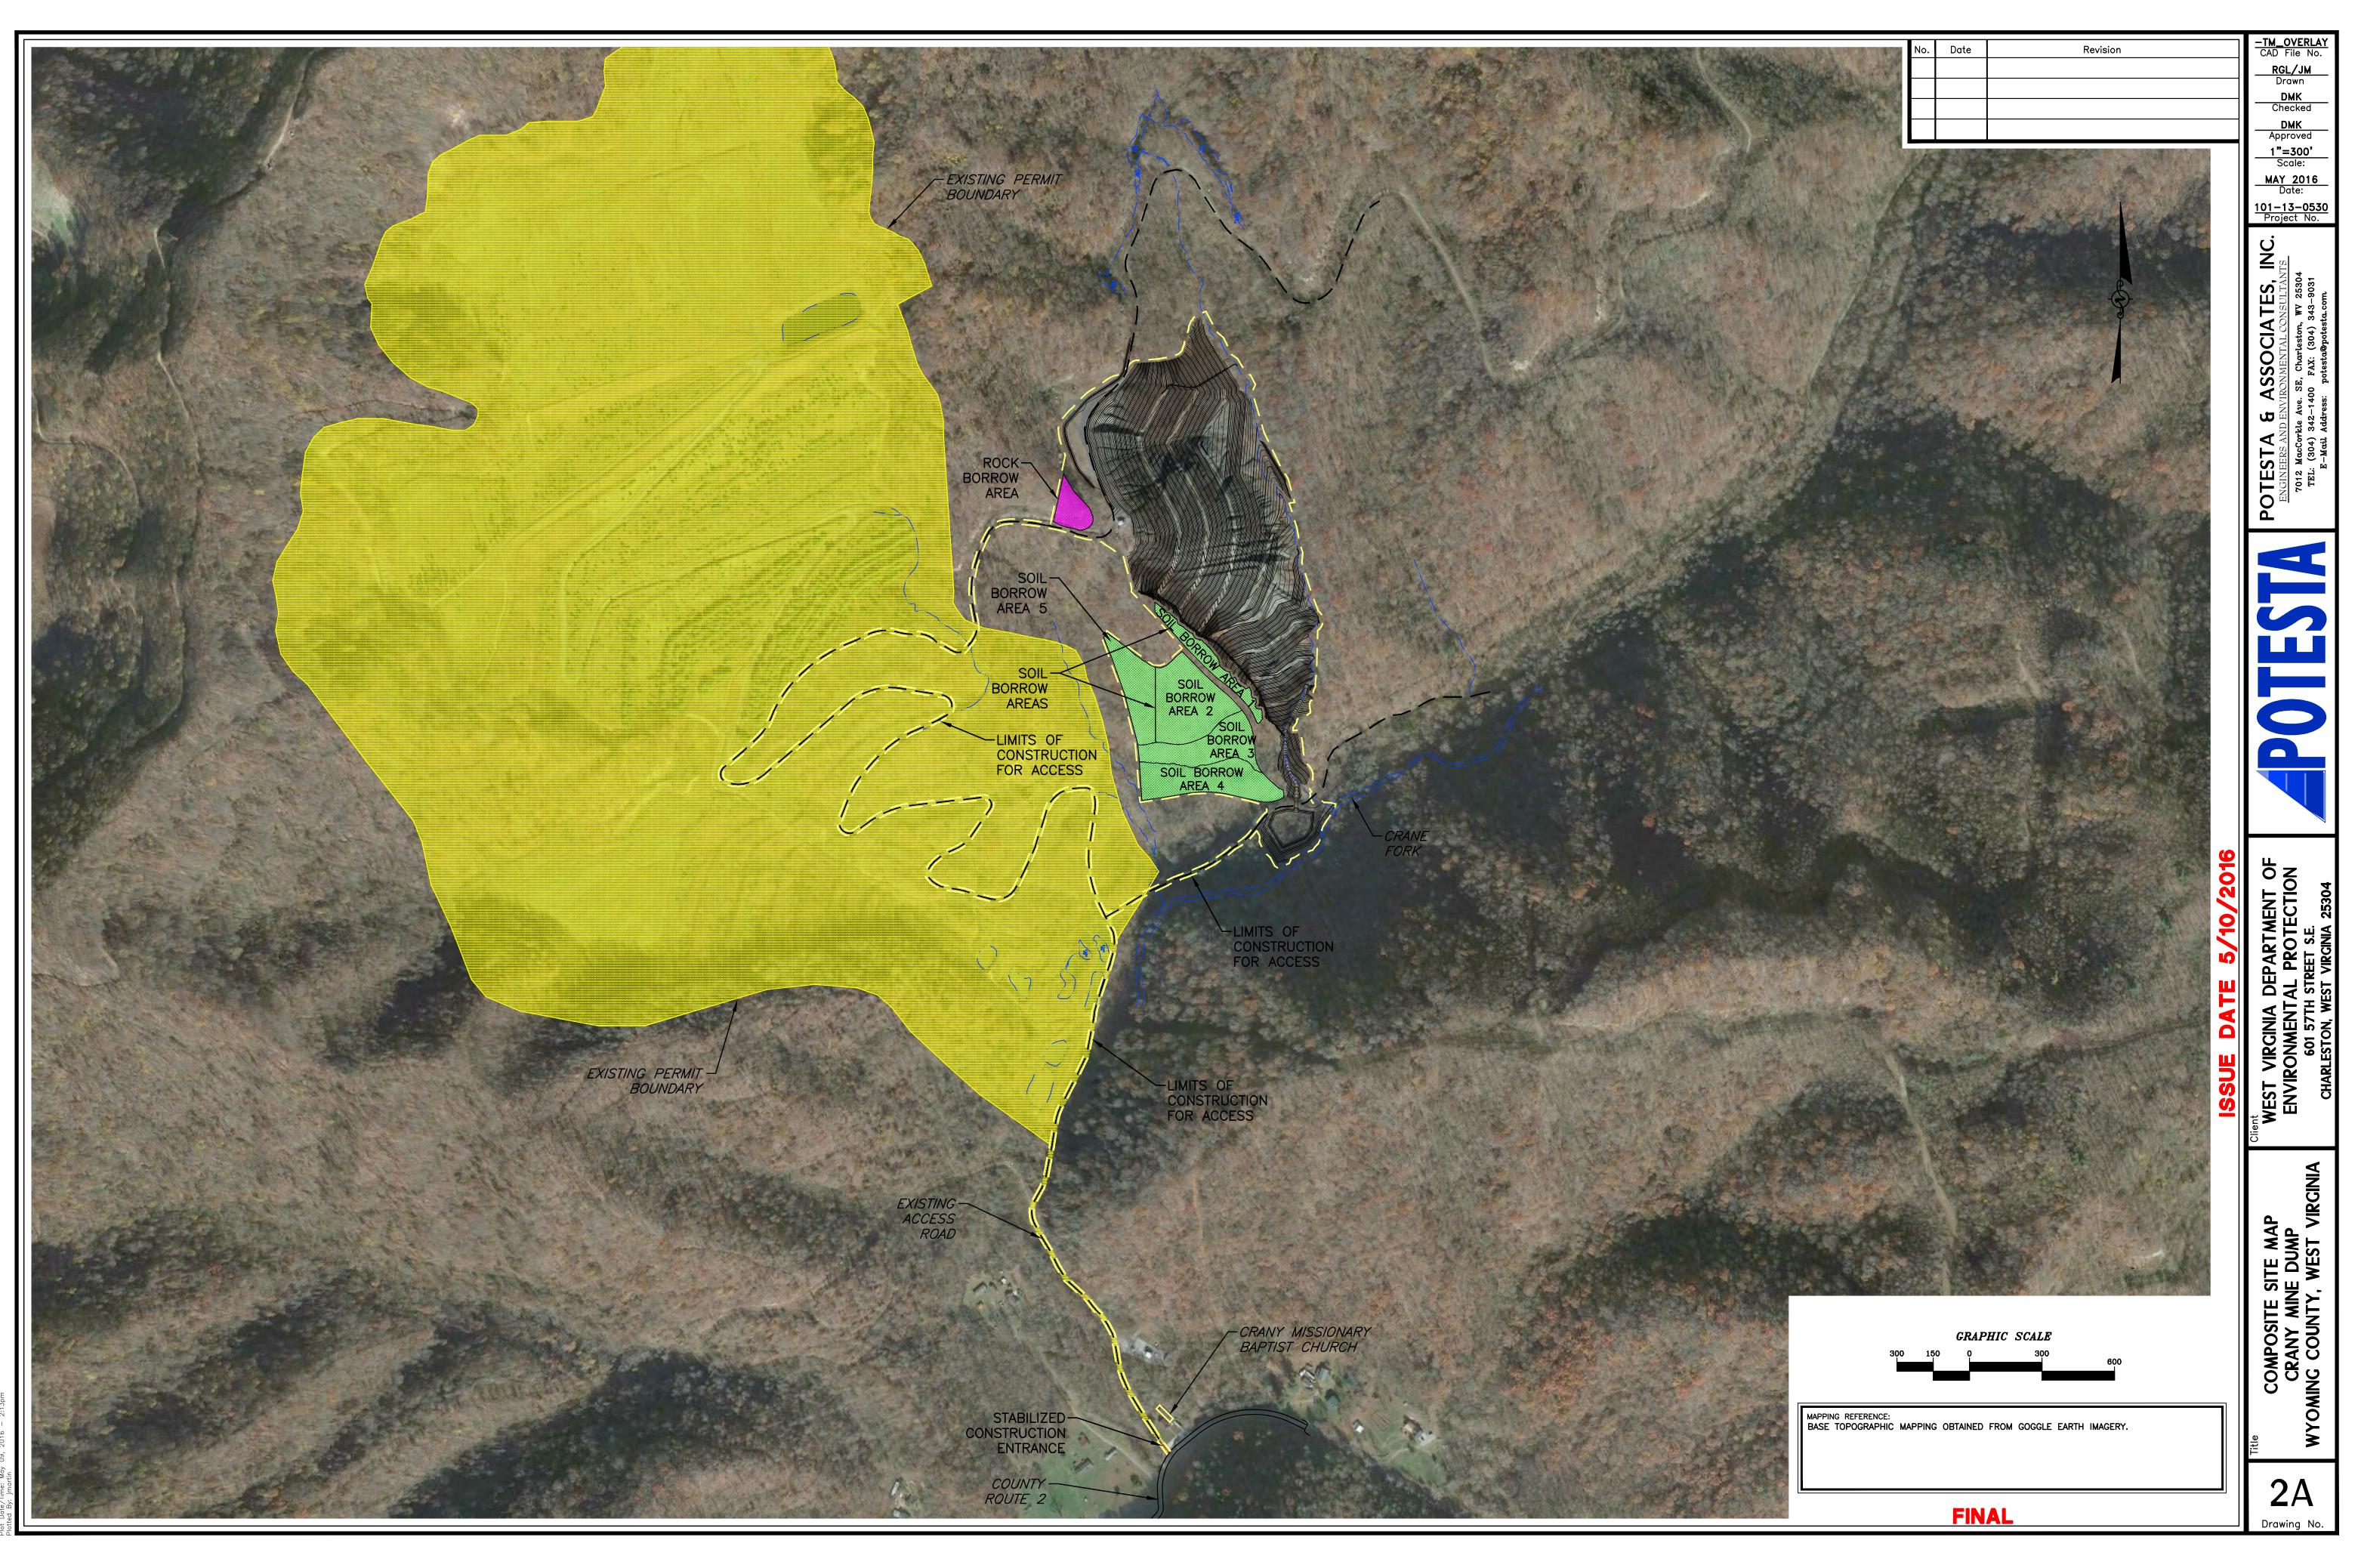


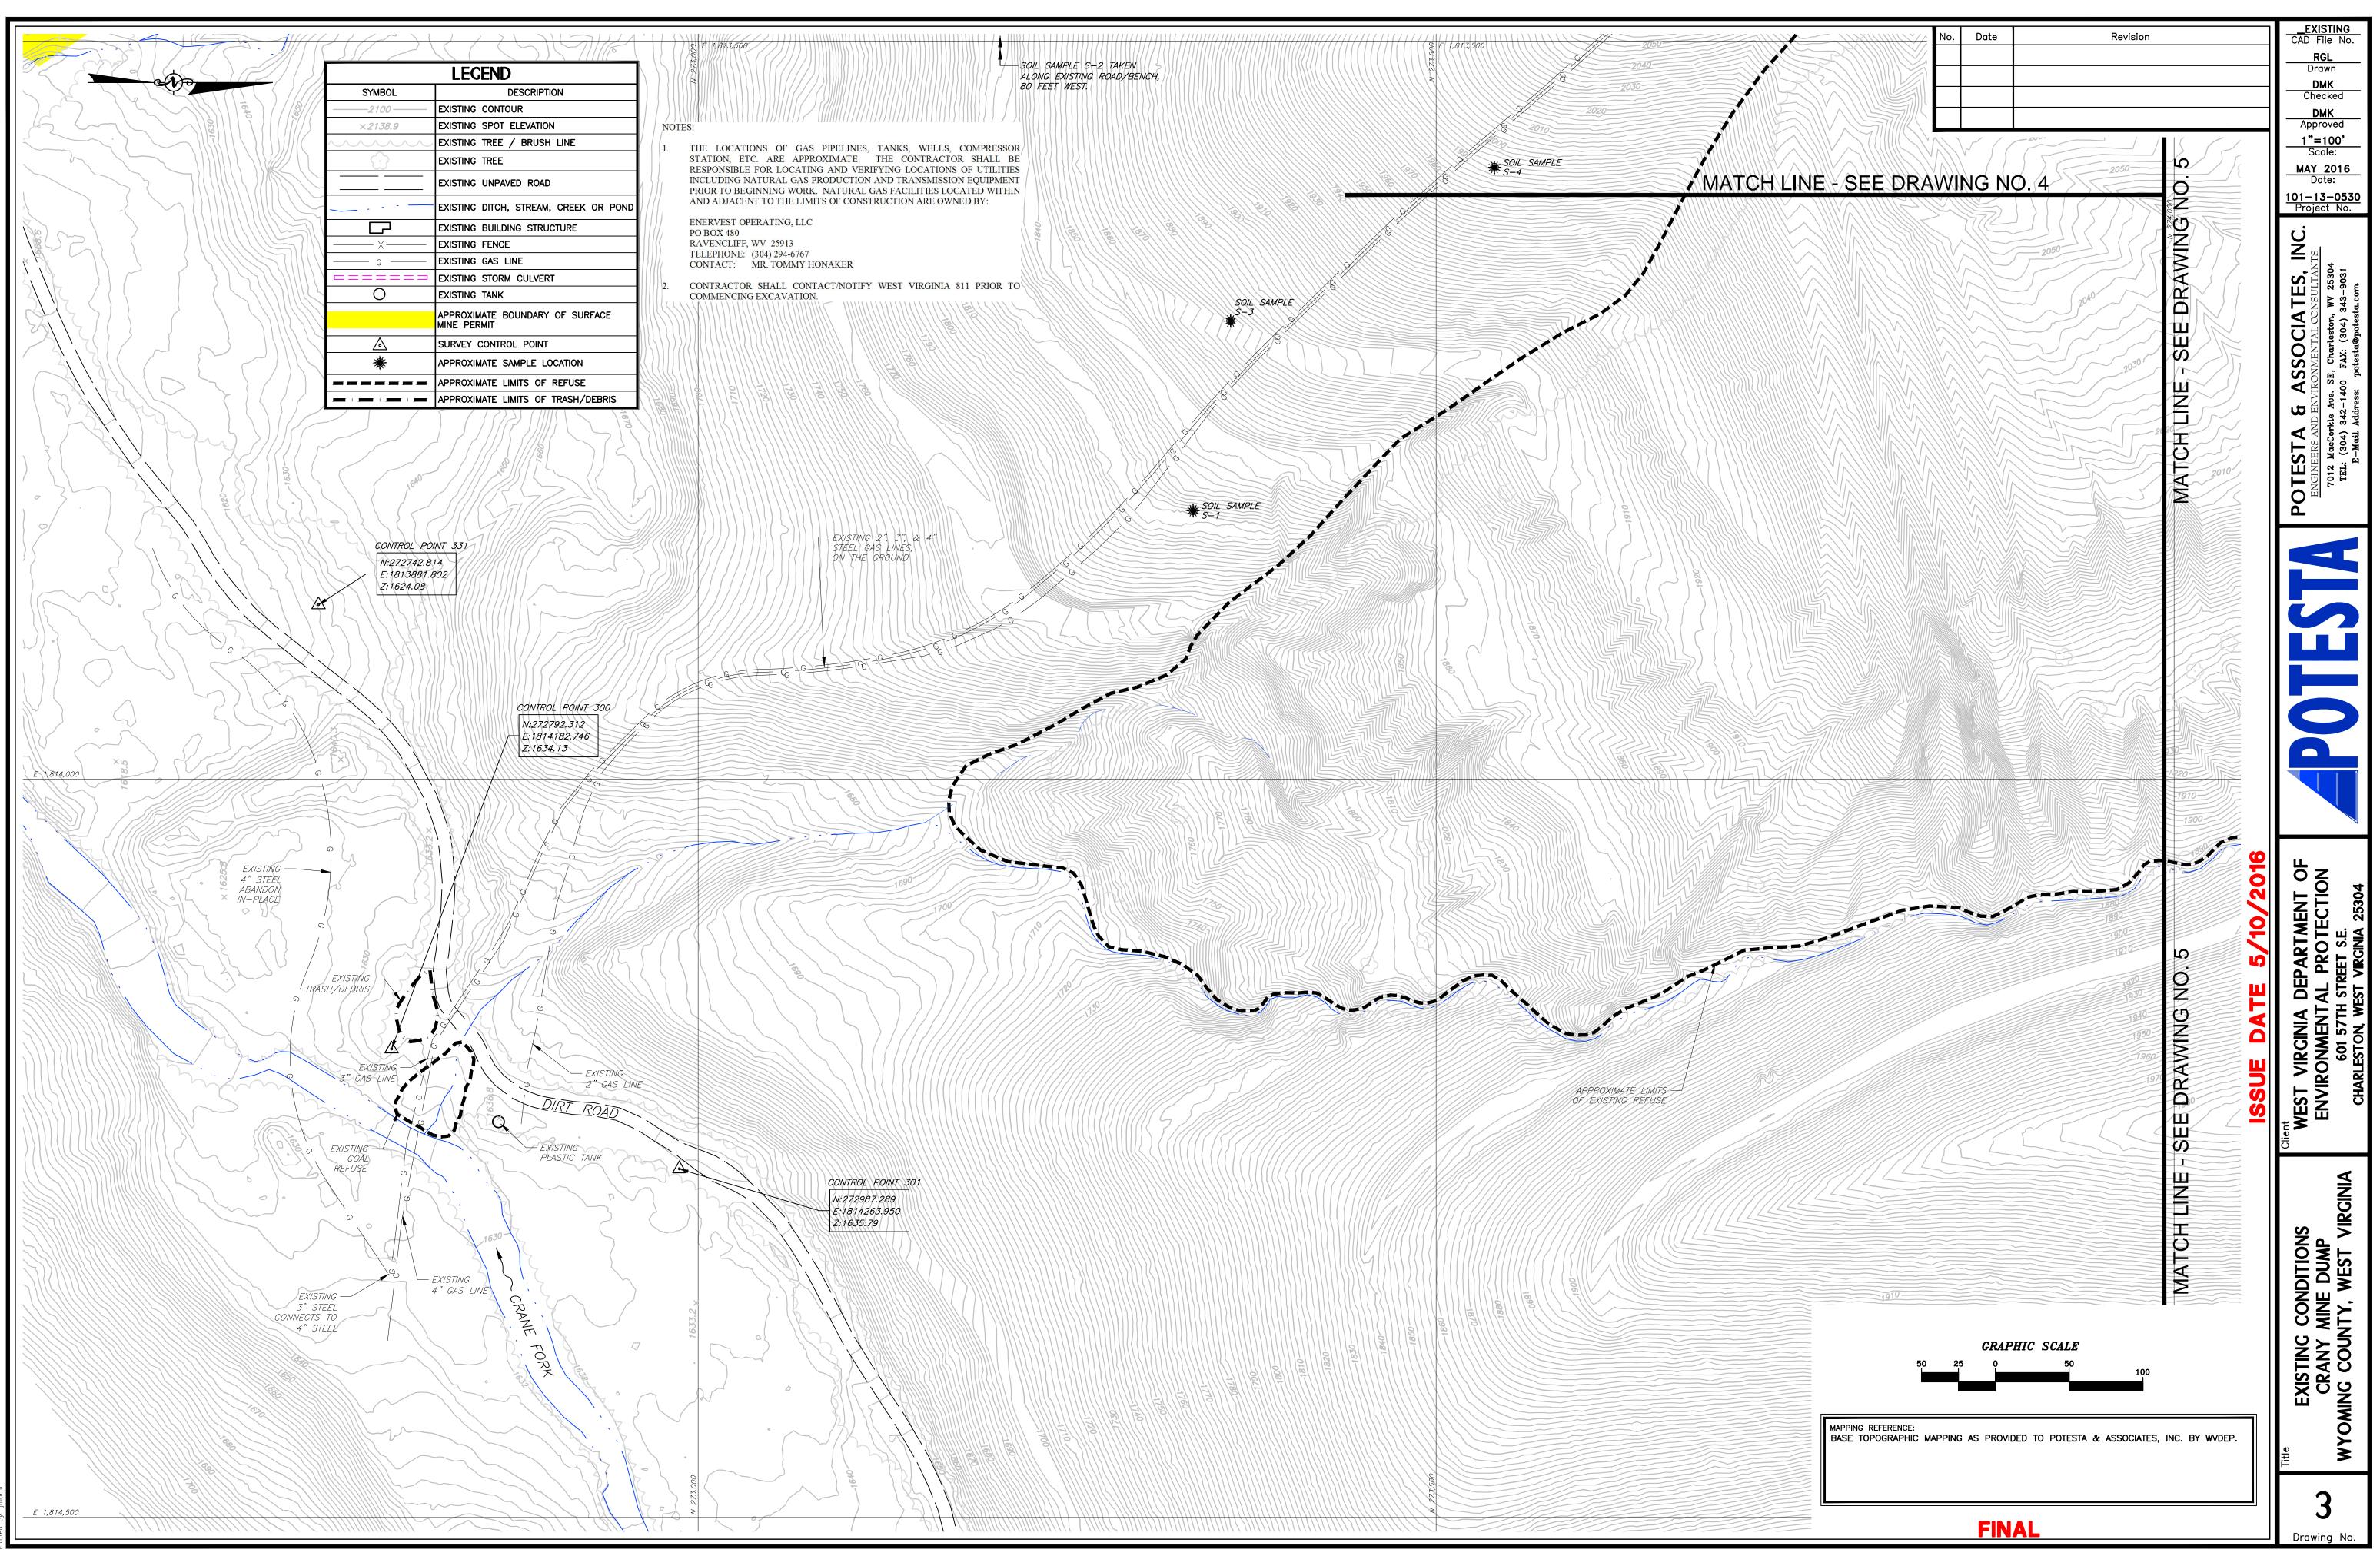


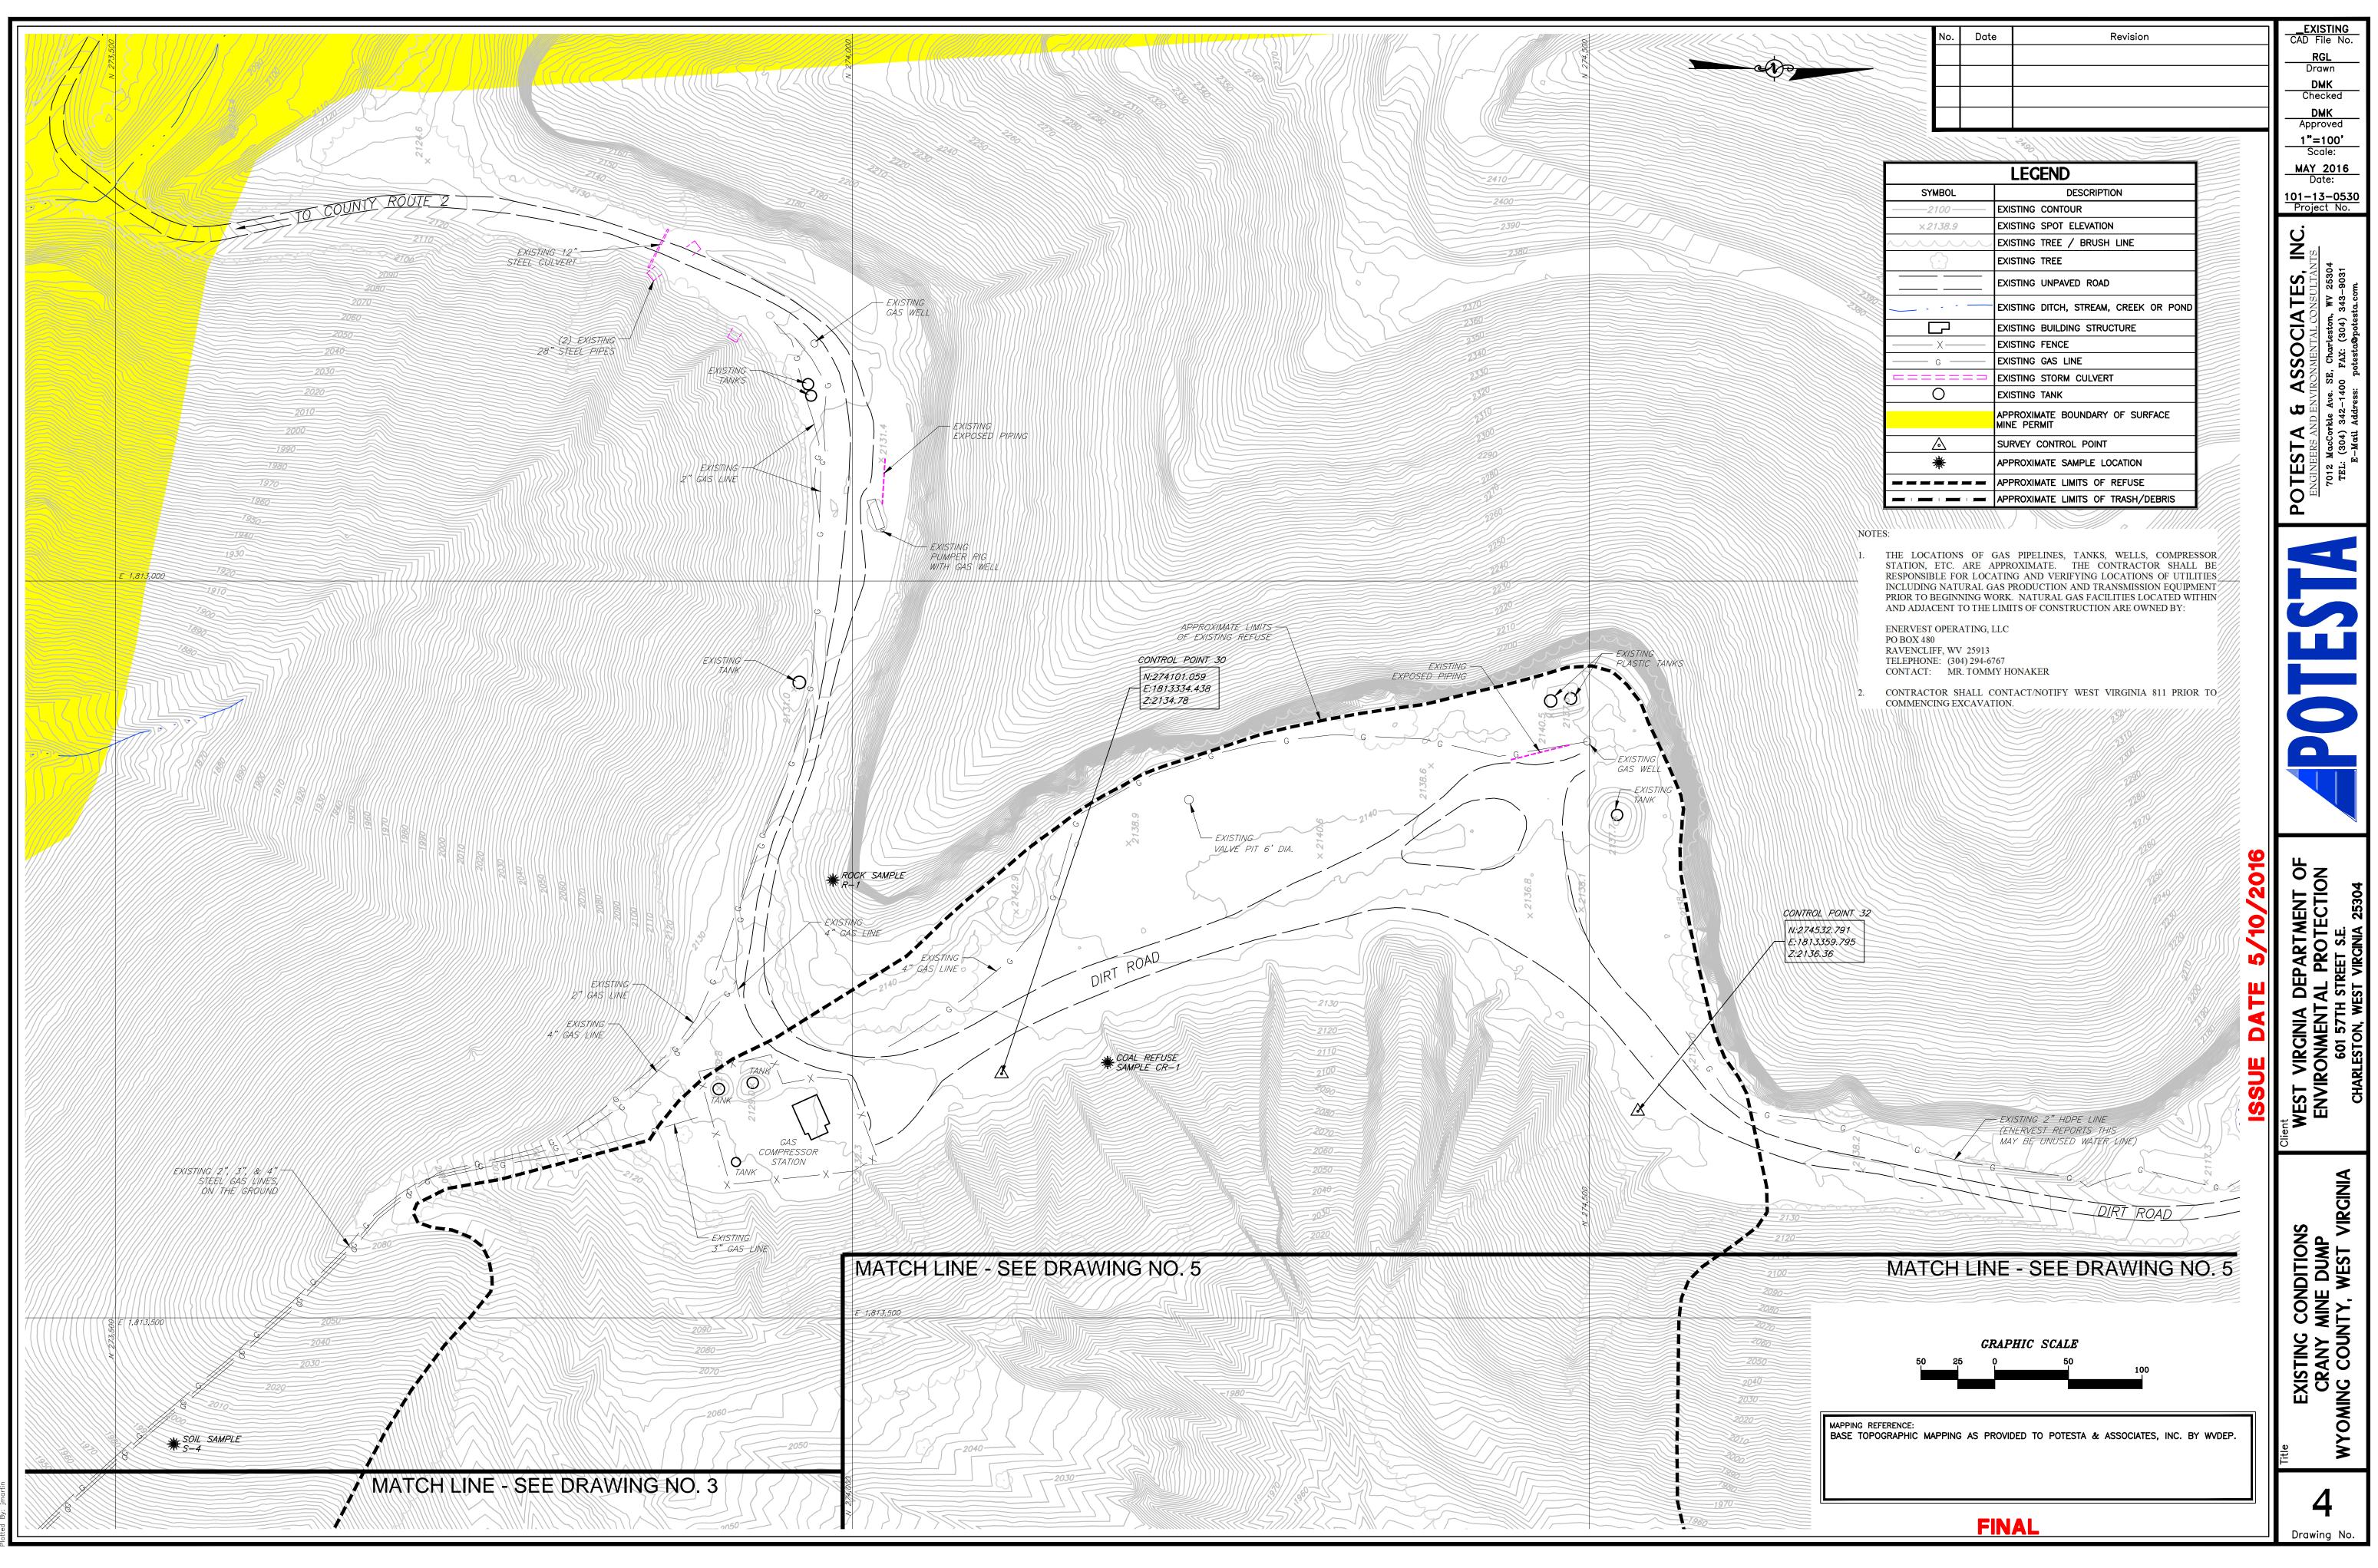


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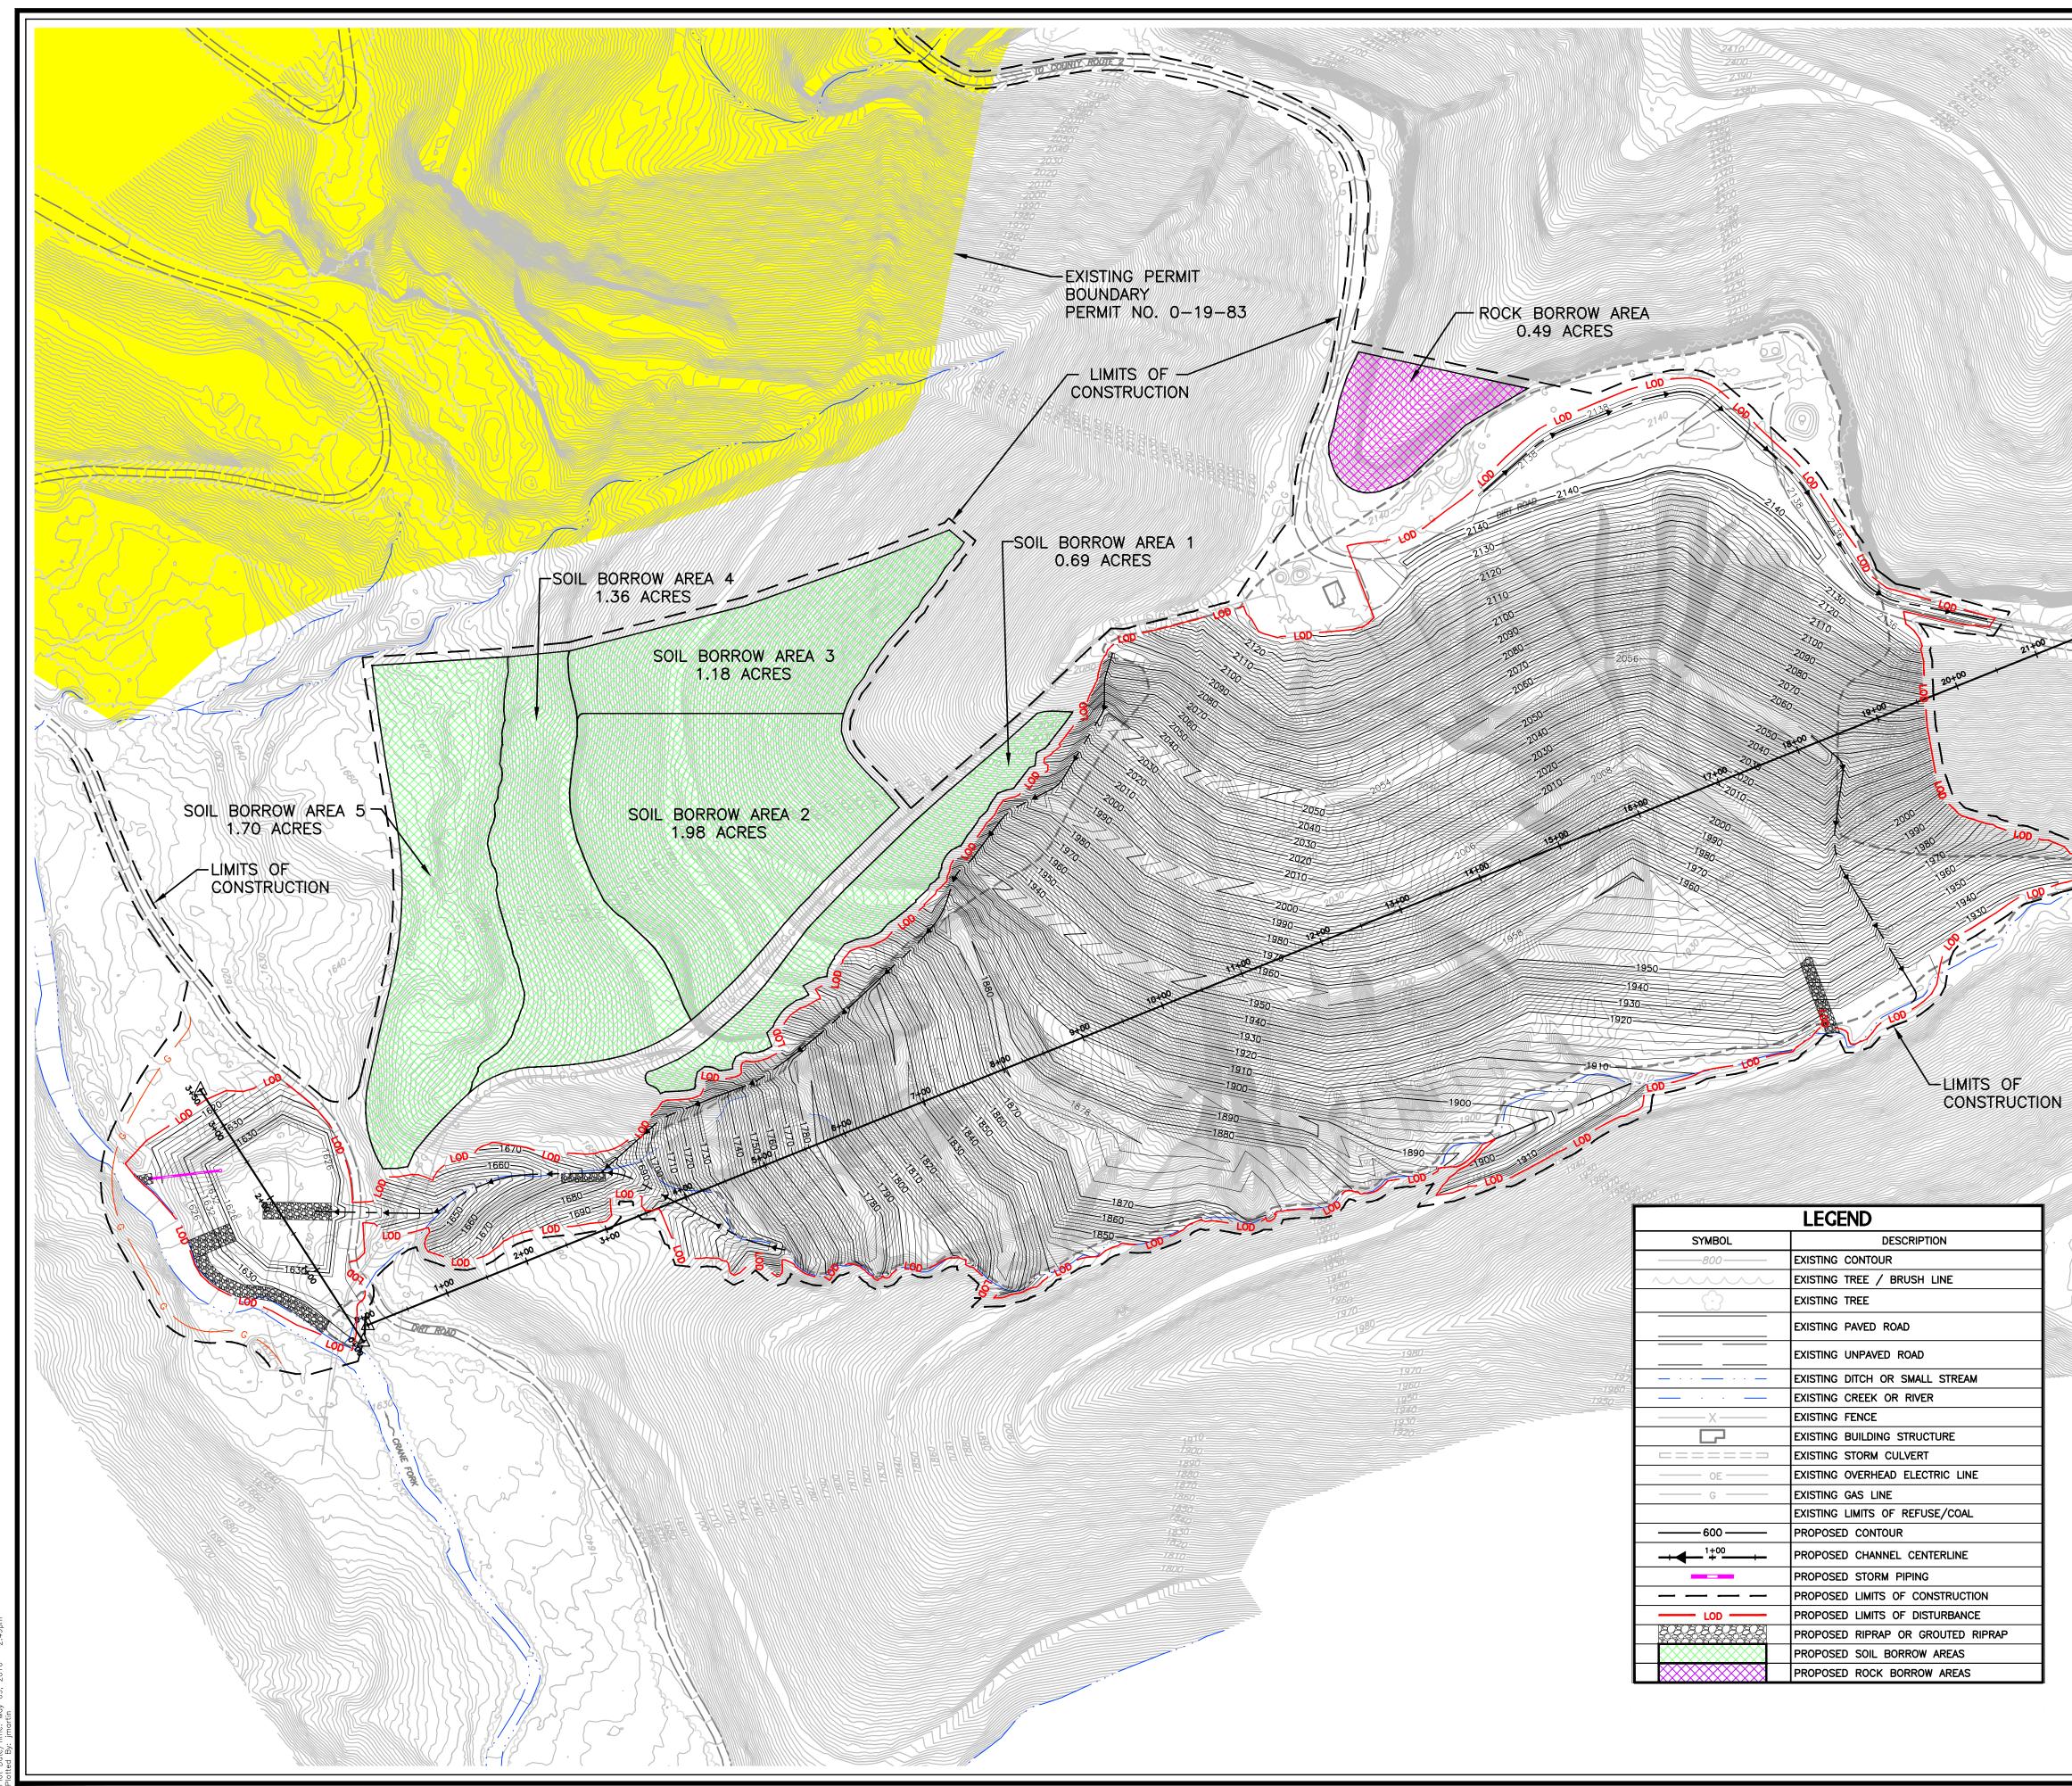


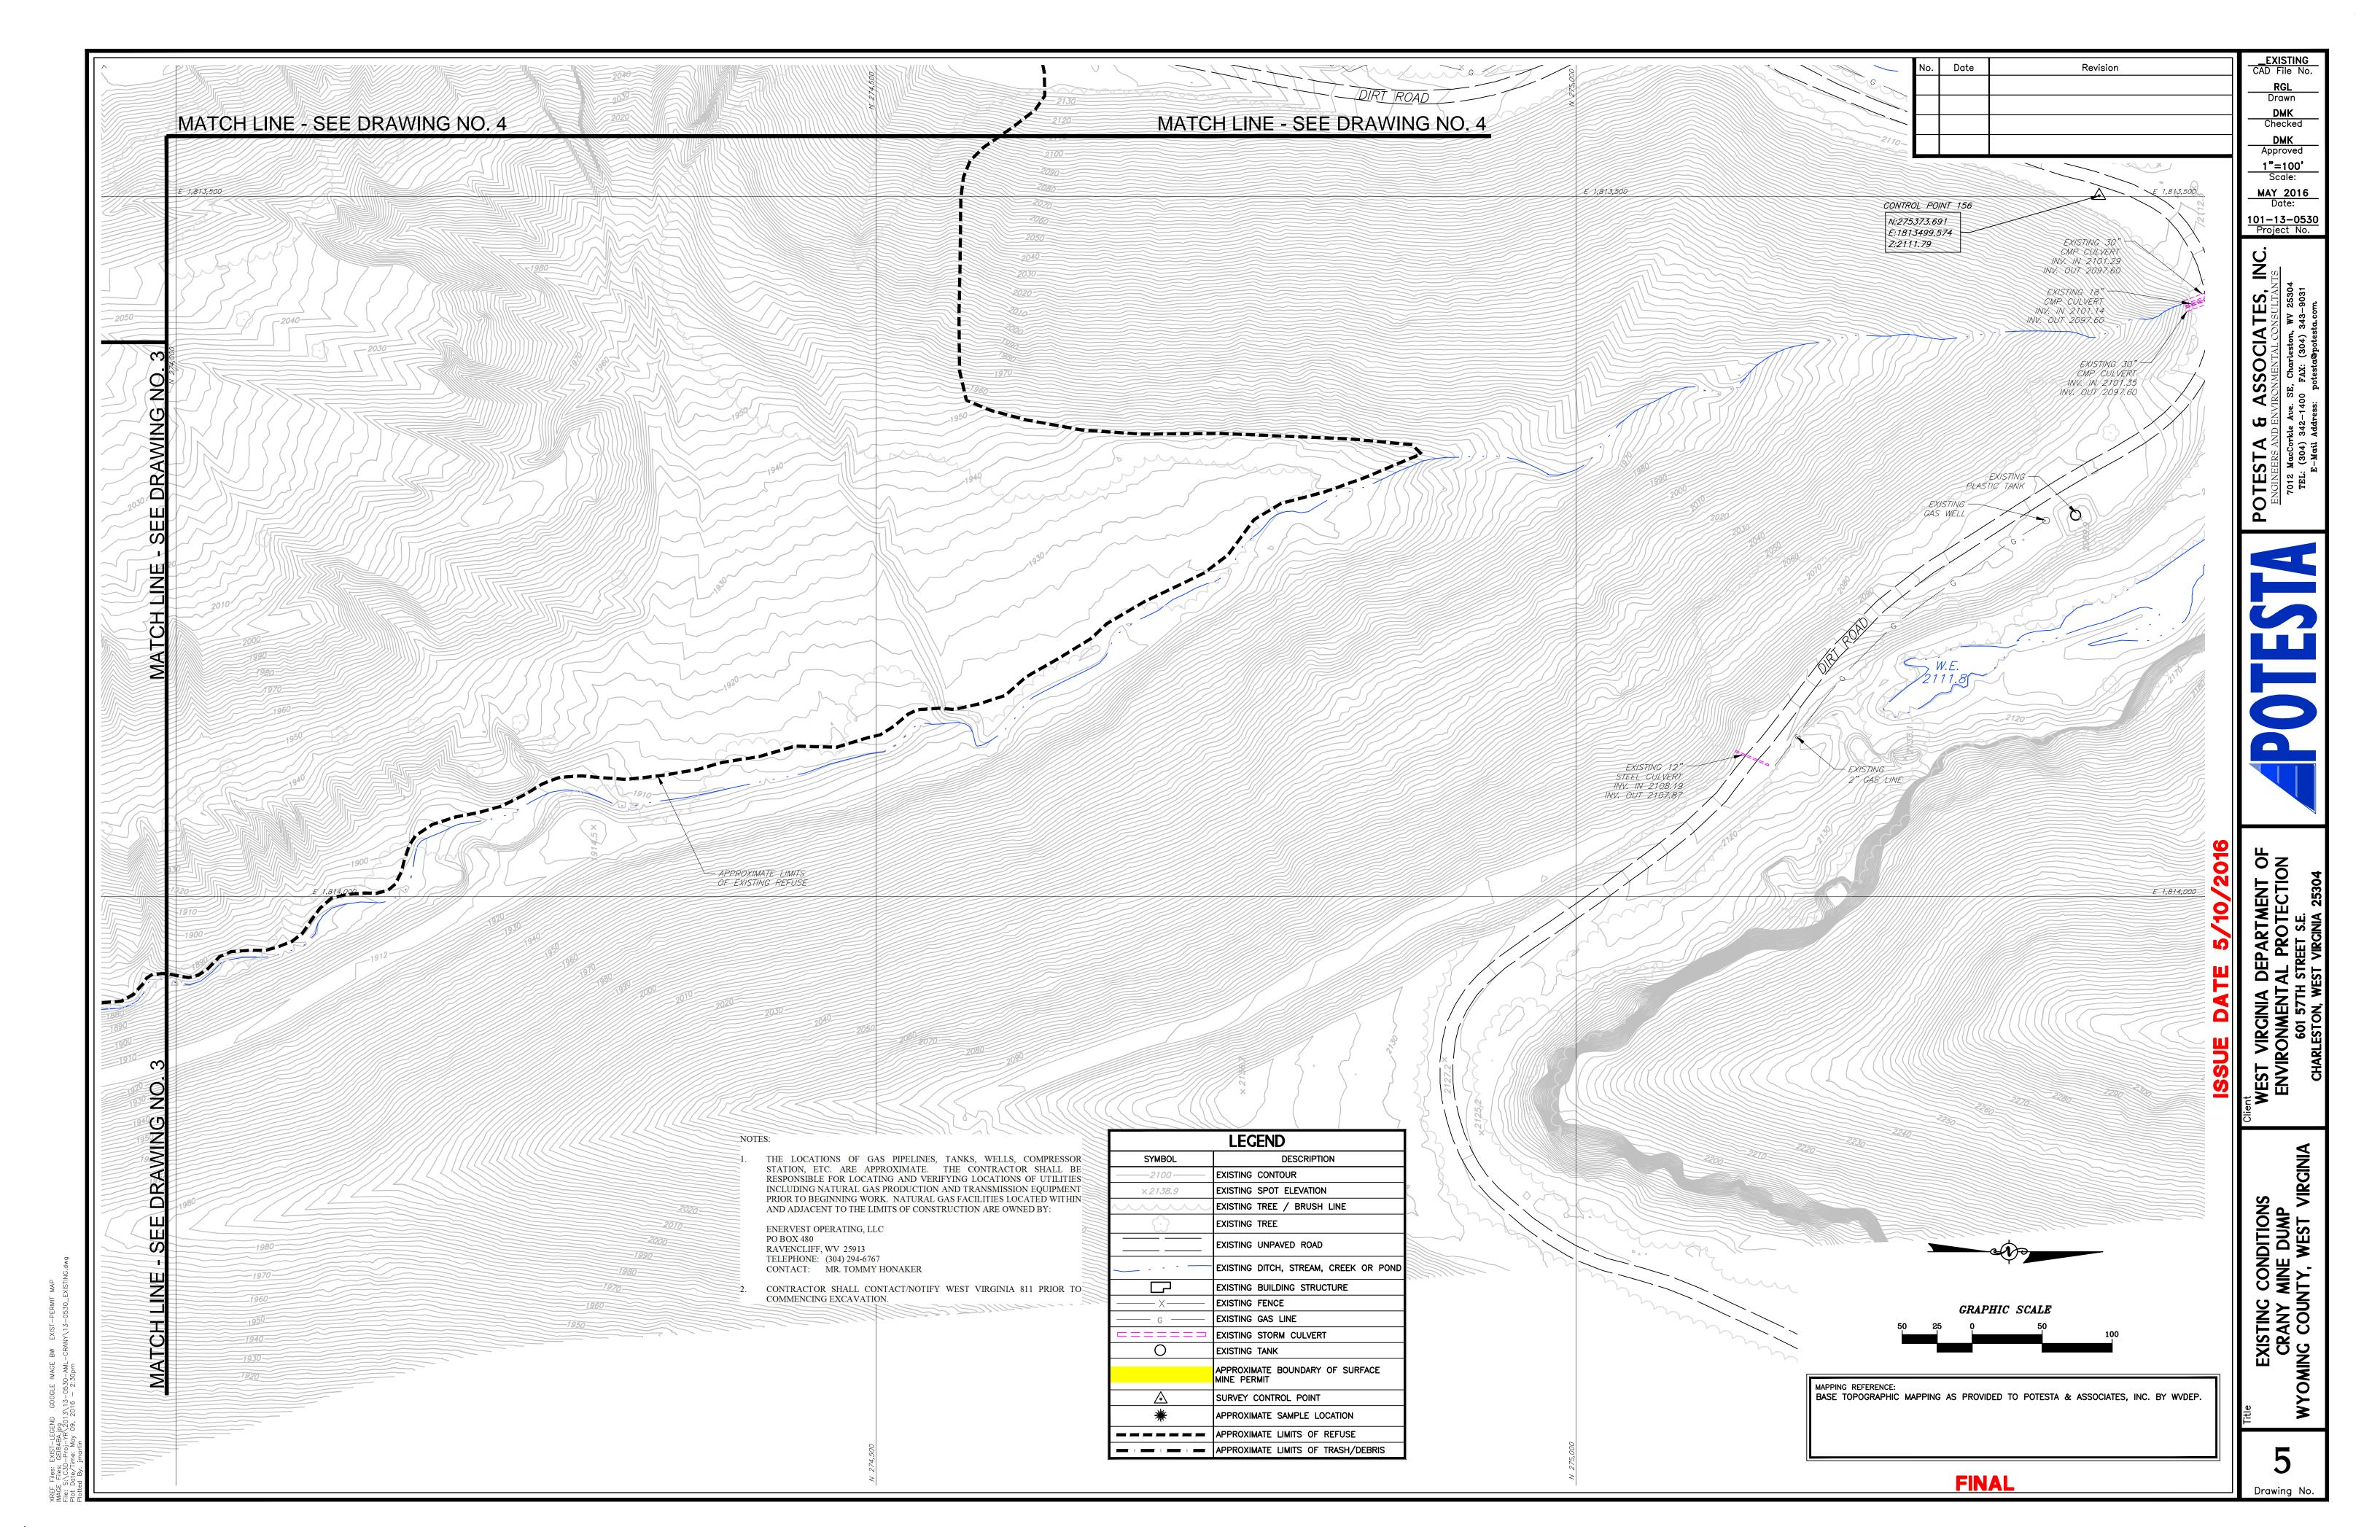

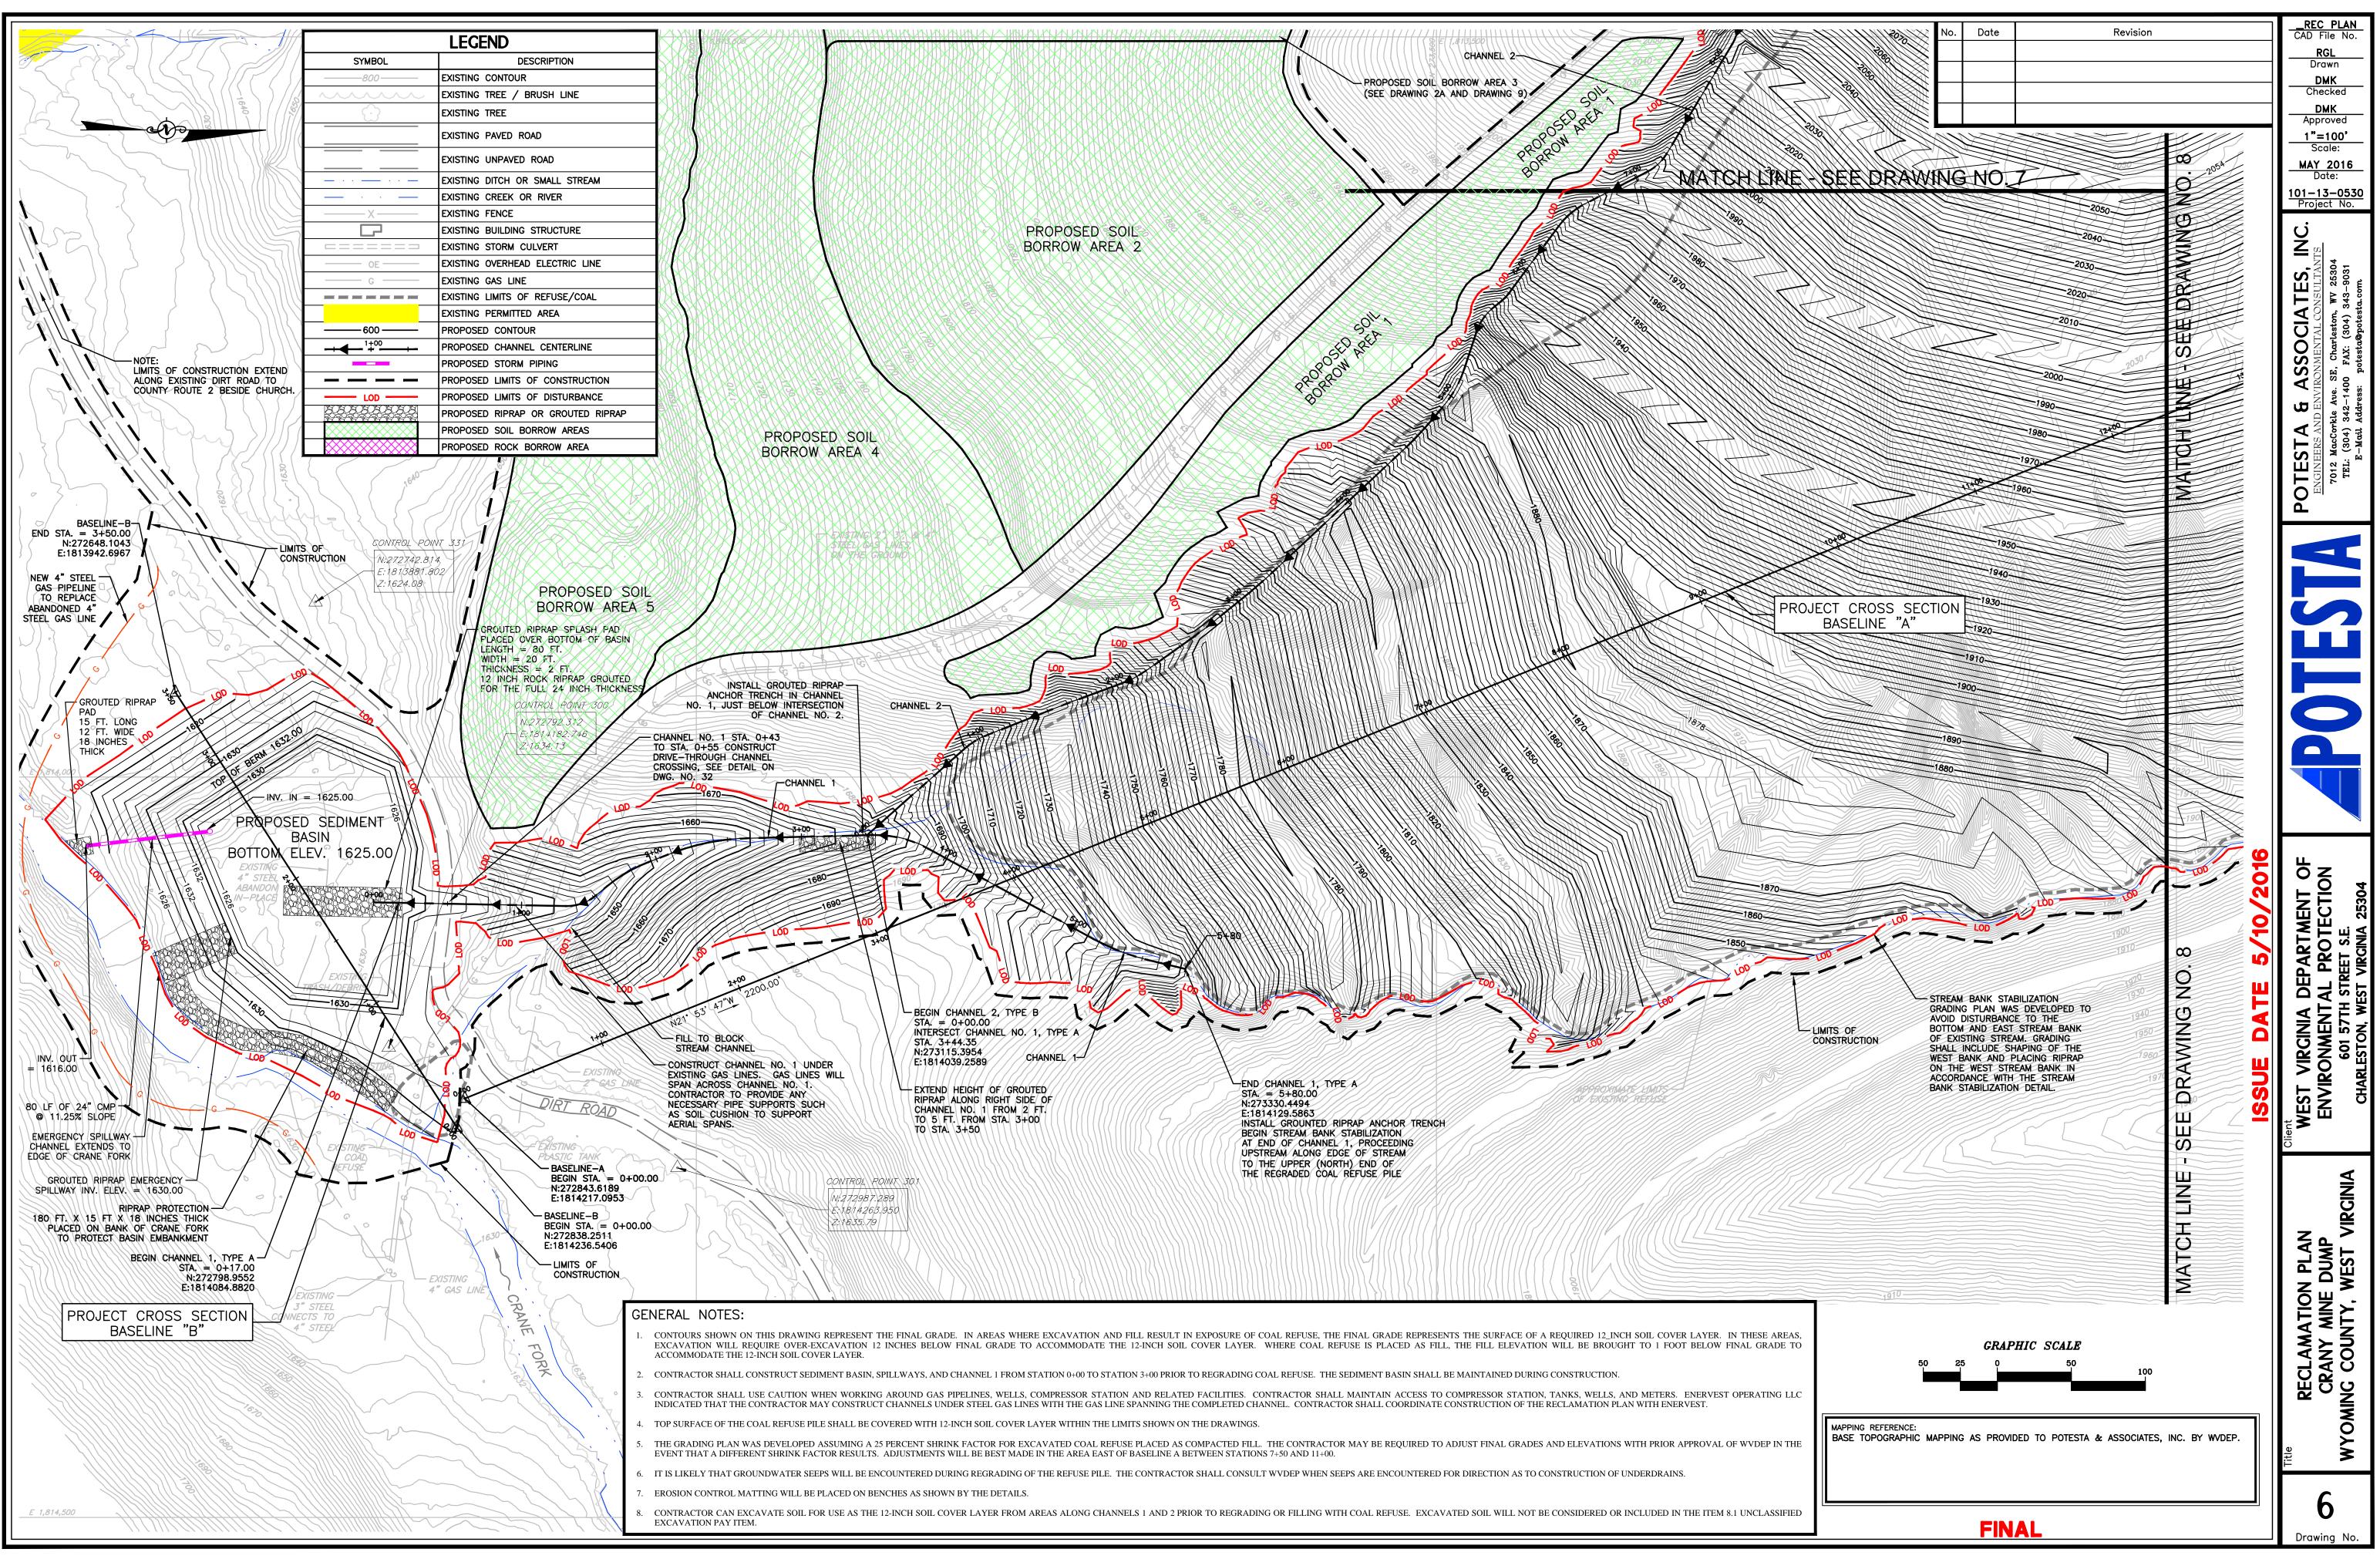	No.	Date	Revision	REC_PLAN CAD_File_No.
				RGL Drawn DMK
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	GENERA	L NOTE	S:	<u>1"=100'</u> Scale:
	AREAS	S WHERE EX	N ON THIS DRAWING REPRESENT THE FINAL GRADE. IN CAVATION AND FILL RESULT IN EXPOSURE OF COAL L GRADE REPRESENTS THE SURFACE OF A REQUIRED	<u>MAY 2016</u> Date: 101-13-0530
	REQUI ACCO	RE OVER-EX MMODATE T	VER LAYER. IN THESE AREAS, EXCAVATION WILL XCAVATION 12 INCHES BELOW FINAL GRADE TO HE 12-INCH SOIL COVER LAYER. WHERE COAL REFUSE 2, THE FILL ELEVATION WILL BE BROUGHT TO 1 FOOT	Project No.
	BELOV LAYEI	W FINAL GR R.	ADE TO ACCOMMODATE THE 12-INCH SOIL COVER	
	CHAN COAL	NEL 1 FROM	ALL CONSTRUCT SEDIMENT BASIN, SPILLWAYS, AND STATION 0+00 TO STATION 3+00 PRIOR TO REGRADING HE SEDIMENT BASIN SHALL BE MAINTAINED DURING	TES, NSULTAN W 2530- 343-9031 tu.com
	PIPELI	NES, WELLS	ALL USE CAUTION WHEN WORKING AROUND GAS , COMPRESSOR STATION AND RELATED FACILITIES. ALL MAINTAIN ACCESS TO COMPRESSOR STATION,	SSOCIATE NMENTAL CONSUL , charleston, WV 26 FAX: (304) 343-90 potesta@potesta.com
	THAT GAS L	THE CONTR INES WITH T	ND METERS. ENERVEST OPERATING LLC INDICATED ACTOR MAY CONSTRUCT CHANNELS UNDER STEEL THE GAS LINE SPANNING THE COMPLETED CHANNEL. HALL COORDINATE CONSTRUCTION OF THE	
	RECLA 4. TOP S	MATION PLA	AN WITH ENERVEST. THE COAL REFUSE PILE SHALL BE COVERED WITH	E A ENVIR Ave. 2–140 dress:
	DRAW	INGS.	VER LAYER WITHIN THE LIMITS SHOWN ON THE	
	THE C ELEVA	ONTRACTOR	AVATED COAL REFUSE PLACED AS COMPACTED FILL. A MAY BE REQUIRED TO ADJUST FINAL GRADES AND A PRIOR APPROVAL OF WVDEP IN THE EVENT THAT A K FACTOR RESULTS. ADJUSTMENTS WILL BE BEST	
	MADE 11+00.	IN THE ARE	A EAST OF BASELINE A BETWEEN STATIONS 7+50 AND	LOd DNE DNE
	DURIN CONSU	IG REGRADII JLT WVDEP	AT GROUNDWATER SEEPS WILL BE ENCOUNTERED NG OF THE REFUSE PILE. THE CONTRACTOR SHALL WHEN SEEPS ARE ENCOUNTERED FOR DIRECTION AS N OF UNDERDRAINS.	
		ON CONTROI E DETAILS.	L MATTING WILL BE PLACED ON BENCHES AS SHOWN	POTESTA
	COVE REGRA	R LAYER FR ADING OR FI	N EXCAVATE SOIL FOR USE AS THE 12-INCH SOIL ROM AREAS ALONG CHANNELS 1 AND 2 PRIOR TO ILLING WITH COAL REFUSE. EXCAVATED SOIL WILL	5
		VATION PAY	RED OR INCLUDED IN THE ITEM 8.1 UNCLASSIFIED ITEM.	
				$\mathbf{O}$
- NO. 3A STA. 3+50 3+70 CONSTRUCT HROUGH CHANNEL IG, SEE DETAIL ON				
. 32 	OF			
COAL REFUSE PILE INCLUD ROAD SHALL BE COVERED INCHES OF SOIL AND REVE	WITH 12			
			010	PON <sup>4</sup>
CONTROL POINT 32				RTMENT OF OTECTION S.E. S.E.
W:274532.791 E:1813359.795 Z:2136.36				PARTA PROTI REET S.E. VIRGINIA
MAINTAIN ACCESS AL	ONG FYISTING			
ROAD, UPON COMPLE RECLAMATION, A 15- ACCESS WAY SHALL	FOOT WIDE		BASELINE - A - END STA. = 22+00.00 N:274884 9097	NIA DI ENTAL 57th S1 N, WEST
-CHANNEL 3A			E:1813396.6492	EST VIRGINIA ENVIRONMEN 601 5771 CHARLESTON, V
L.		/ STA. = N:2747	EL 3A, TYPE C 0+00.00 35.0431 395.7808	WEST V ENVIR
Troe Lop			XER DRUSED WATER LINE	Elient BE
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		£77	1400 DIRT ROAD	/IRGINIA
	G EXISTING F			AN P VIR
20+0	ATCH	LINE	- SEE DRAWING NO. 8	4 PL/ DUM NEST
				RECLAMATION PLAN CRANY MINE DUMP NG COUNTY, WEST V
10- 82-		GRAP	HIC SCALE	AMA VV VUC
	50 2	5 0	50 100	RECLAM CRANY IG COU
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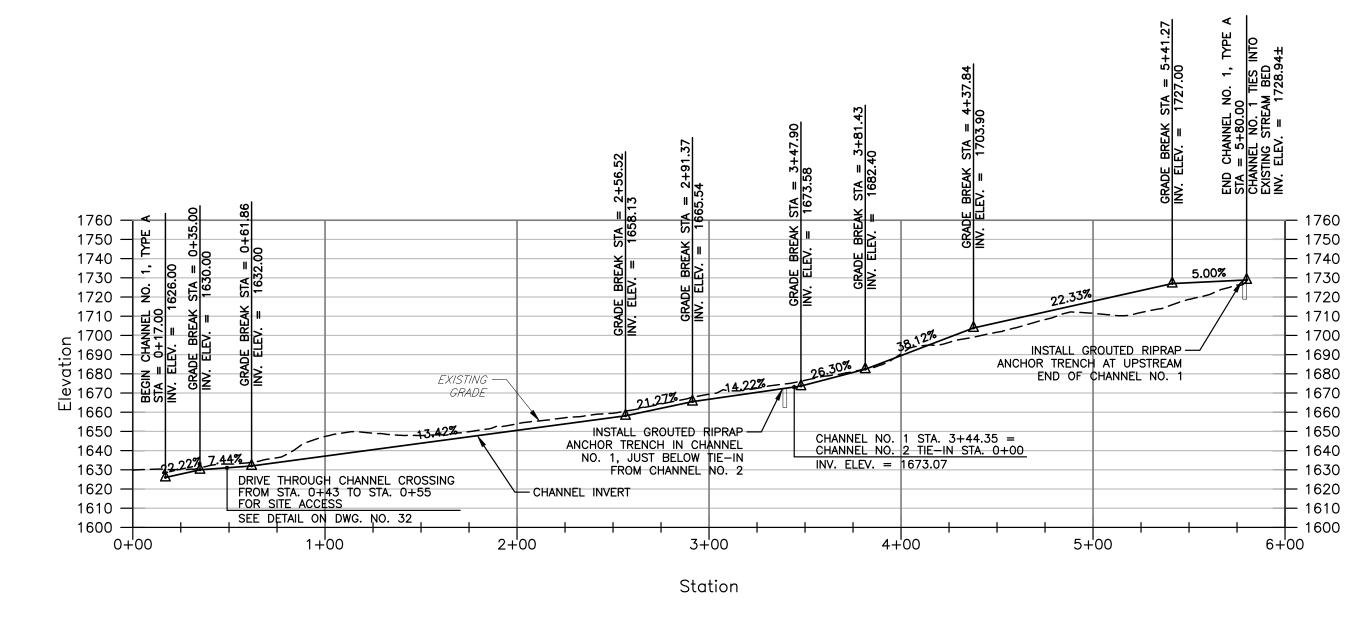

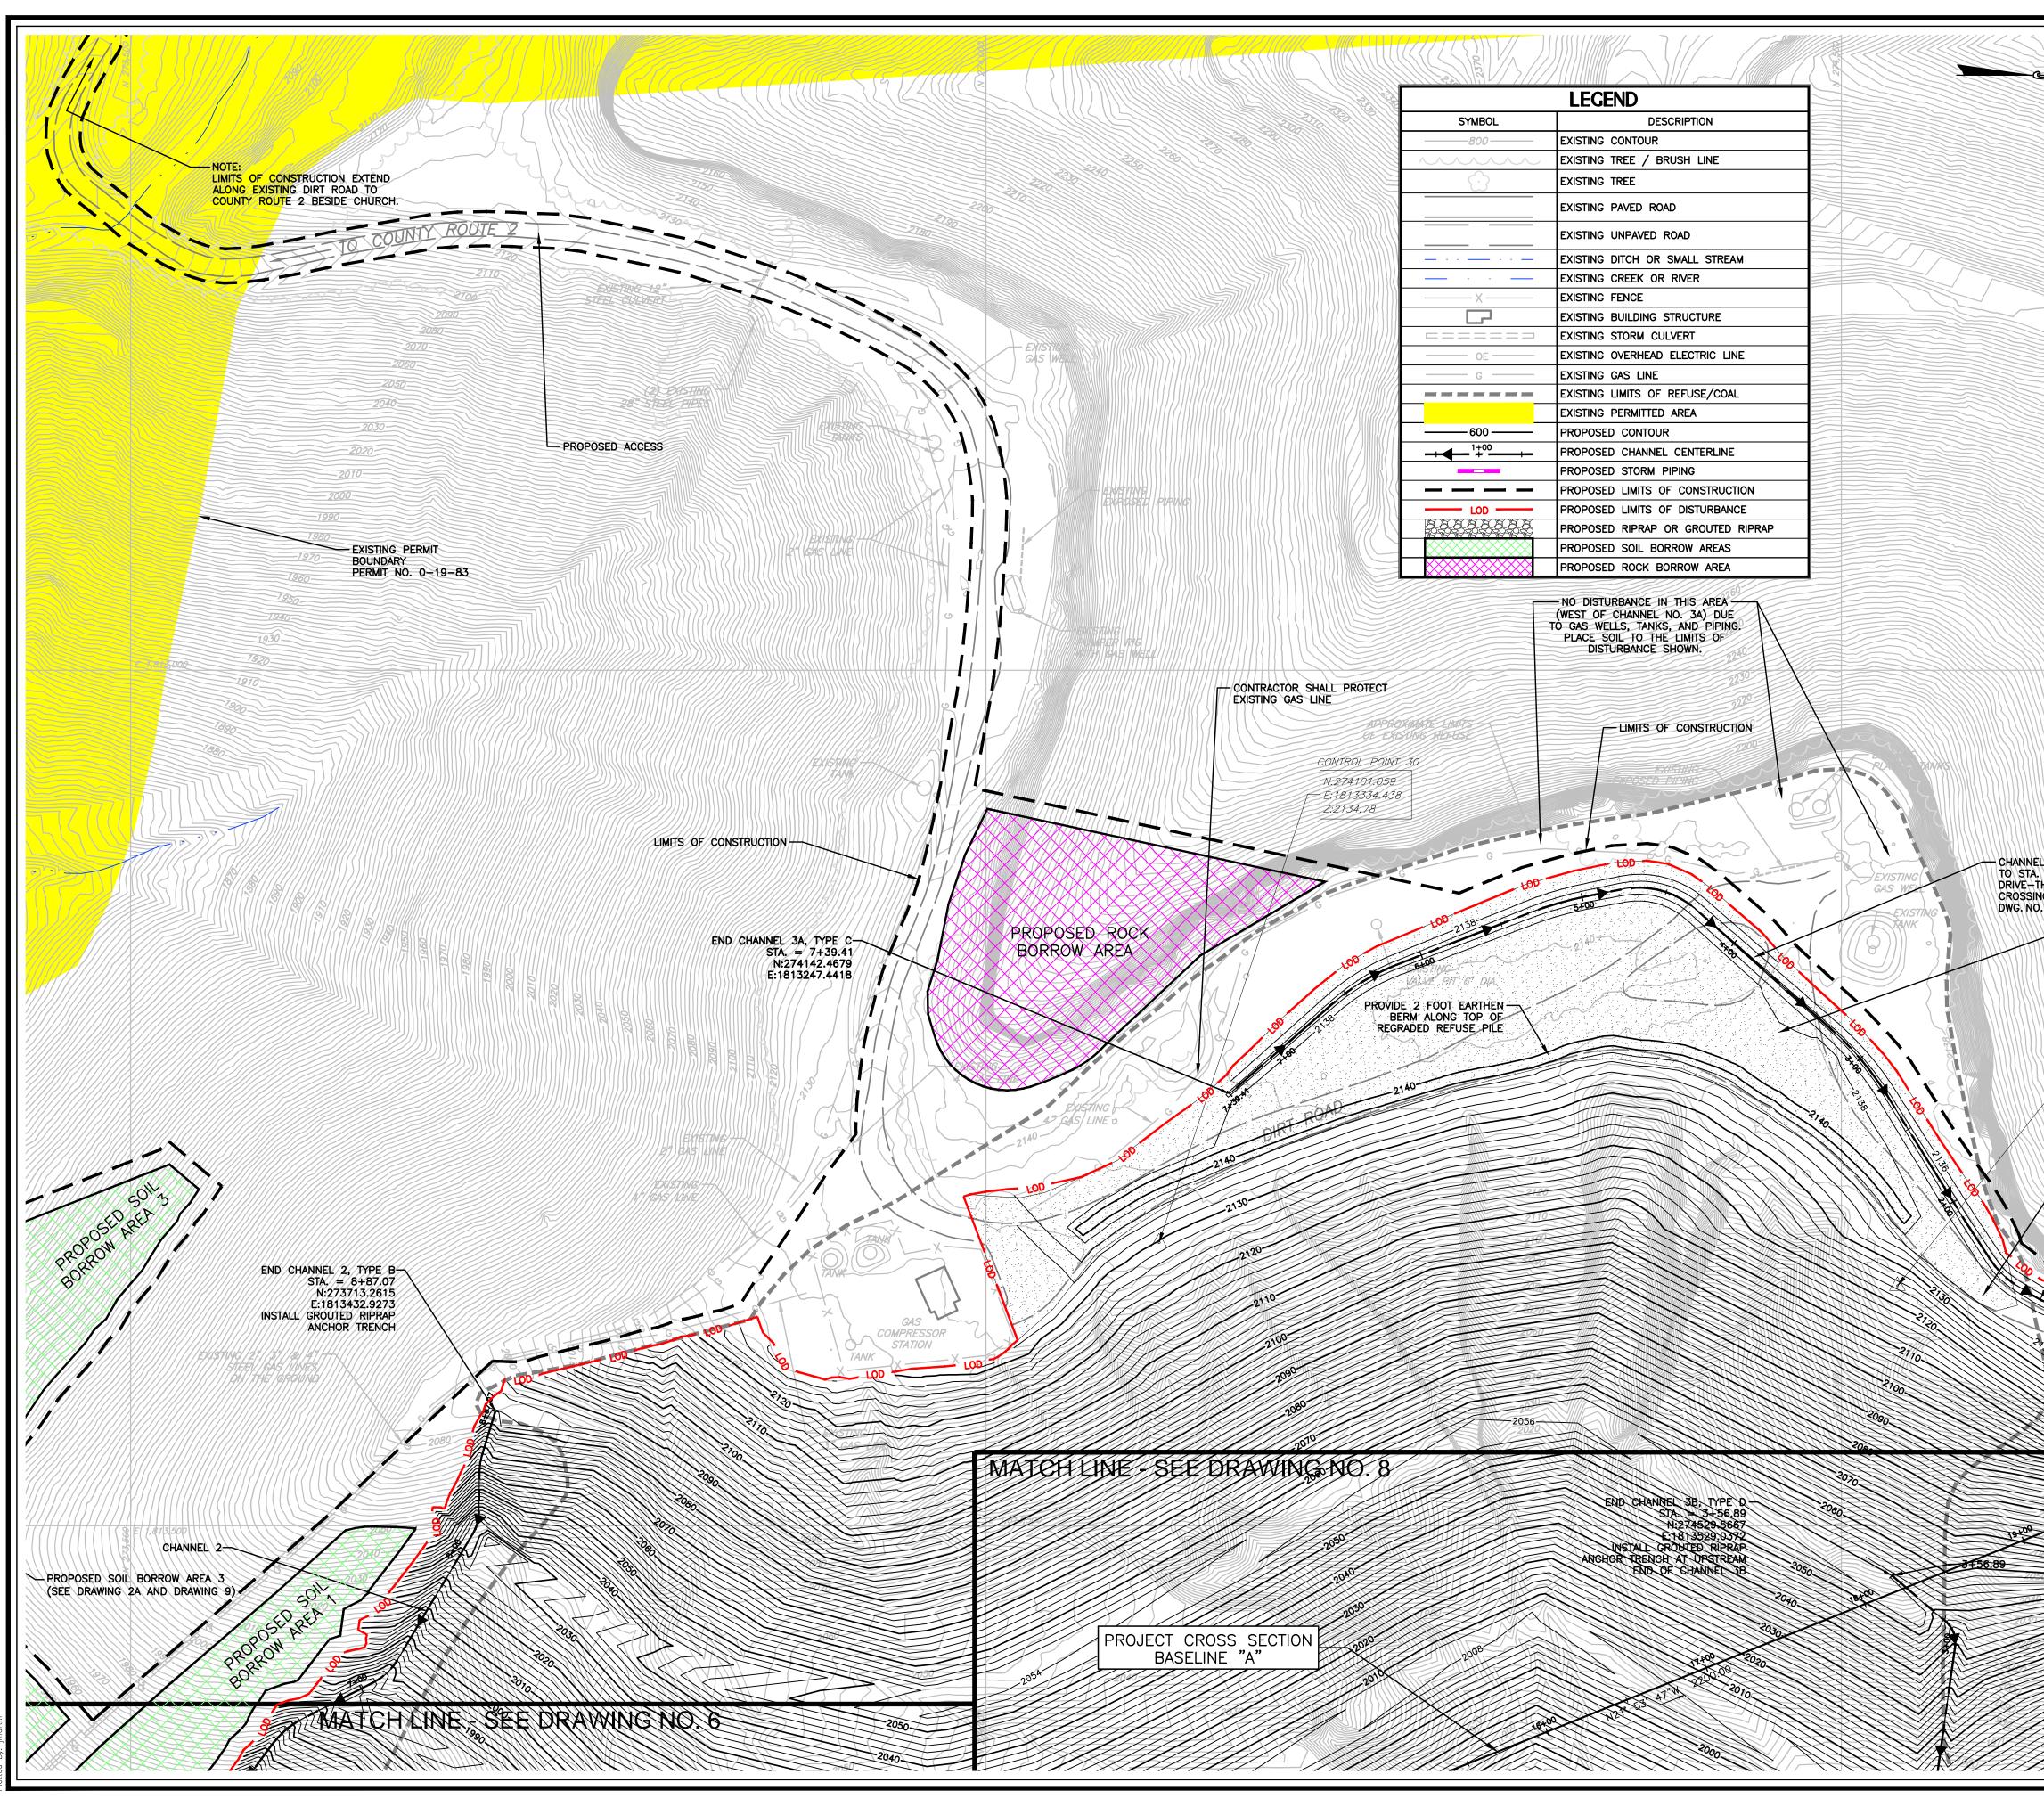
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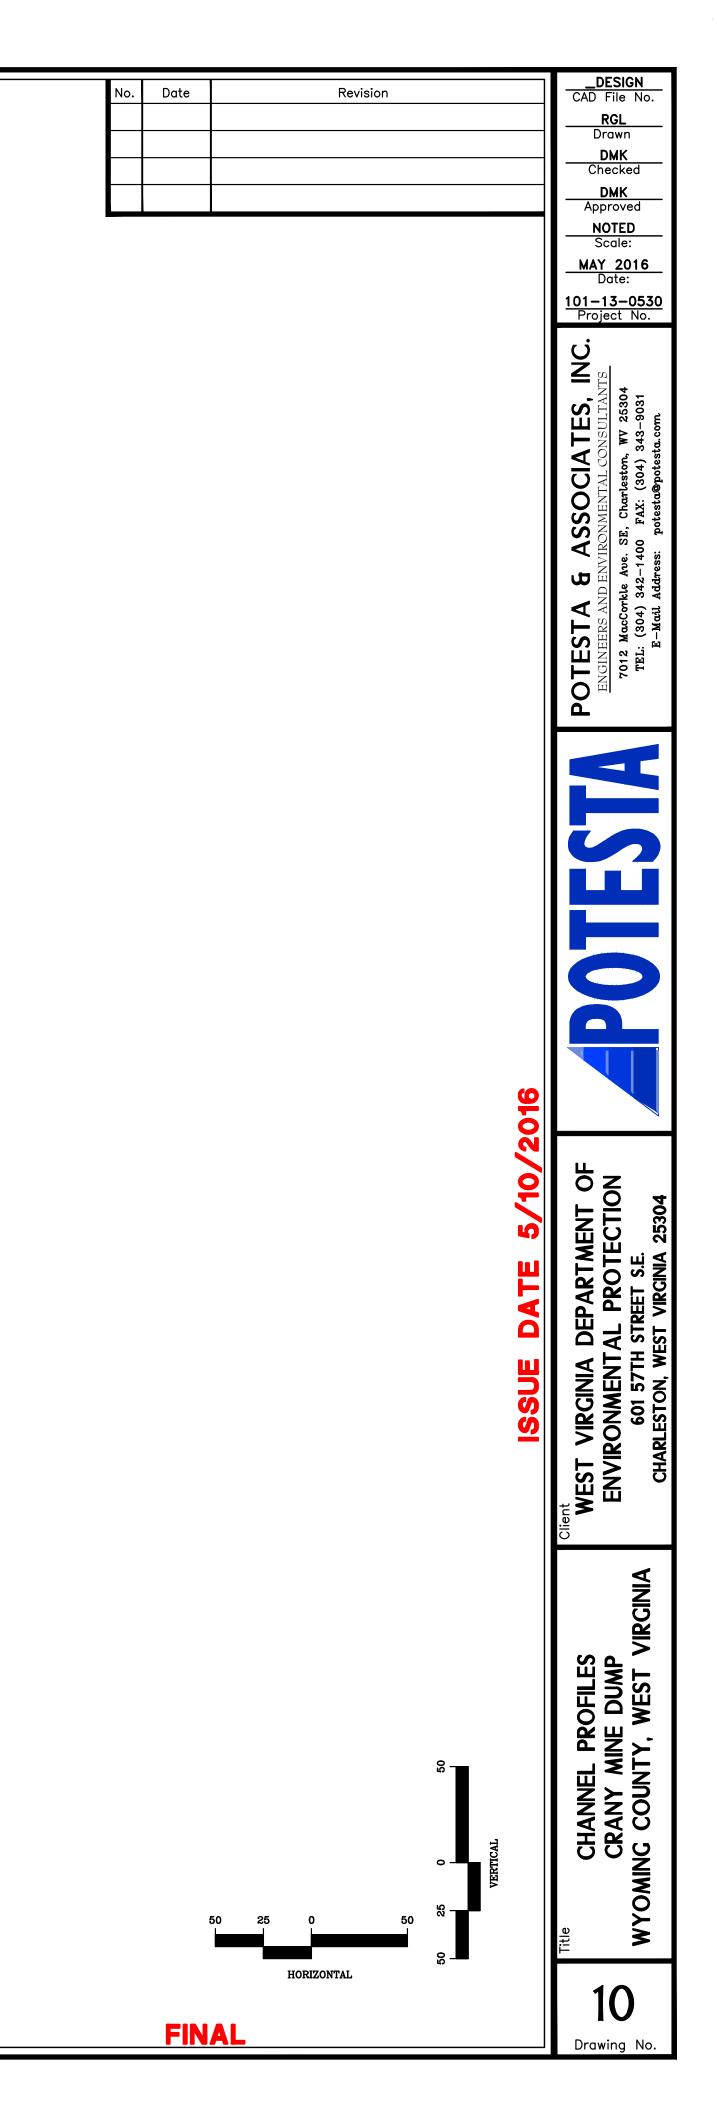



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		No.	Date	Revision	REC_PLAN CAD File No.
					RGL Drawn DMK
		///////////////////////////////////////			Checked DMK
NOTES	:				Approved 1"=100'
1.	THIS PLAN IS INTI			THE CONTRACTOR IN THE PROGRESSION OF THE	Scale: MAY 2016
	OF THE 12-INCH SO	DIL COV	ER LAYER	FOR SOIL BORROW REQUIRED FOR CONSTRUCTION OVER AREAS OF EXPOSED AND REGRADED COAL IITED TO THE DISTURBANCE OF A SINGLE SOIL	Date: 101-13-0530
	BORROW AREA AT BORROW AREAS 1			THIS DRAWING SHOWS THE LOCATION OF SOIL	Project No.
2.				GRUB SOIL BORROW AREAS ONE AREA AT A TIME CUT SHALL BE HANDLED PER THE TECHNICAL	
	AND TRANSPORT T	O THE R	EGRADED	SHALL THEN PROCEED WITH SOIL EXCAVATION COAL REFUSE PILE WHERE IT SHALL BE PLACED AS ALL COMPLETE SOIL REMOVAL IN SOIL BORROW	ES, ULLTAN 25304 -9031
	AREA 1 PRIOR TO SHALL ALSO REVE	CLEARI GETATE	NG SOIL B (LIME, FEF	ORROW AREA 2 AND SO ON. THE CONTRACTOR RTILIZE, SEED, AND MULCH) THE DISTURBED AREA	
	IN EACH SOIL BORI BORROW AREA.	ROW AR	EA PRIOR 1	O ADVANCING/MOVING TO THE SUBSEQUENT SOIL	ASSOCIAT IRONMENTAL CONS SE, Charleston, WV 100 FAX: (304) 343
3.				FIVE SOIL BORROW AREAS, SOIL BORROW AREAS 1 EE TO DEVELOP AND USE SOIL BORROW AREAS IN	E, Chan Potesta
				ACTOR, ONE AT A TIME, WITH EACH SOIL BORROW TO THE NEXT SOIL BORROW AREA.	
ŀ.	SEDIMENT CONTRO	OLS PRIC	R TO GROU	ST MANAGEMENT PRACTICES (BMPs) EROSION AND JND DISTURBANCE IN EACH SOIL BORROW AREA IN	Add
				L MEASURES AND AS EACH BORROW AREA IS IS AND REVEGETATION.	TESTA IGINEERS AN 7012 MucCon TEL: (304) E-Mail
5.	NEARS COMPLETIC	N, THE	CONTRACT	SOIL COVER LAYER OVER EXPOSED COAL REFUSE OR SHALL ACCORDINGLY PLAN AND ADJUST SOIL	
	BORROW OPERATI RESULTS THAN REC			MORE DISTURBANCE OF SOIL BORROW AREAS ETE THE PROJECT.	<b>DO</b>
ó.	GAS PIPELINES, CO	MPRESS	OR STATIO	SOIL BORROW AREAS ARE IN CLOSE PROXIMITY TO N, WELLS, TANKS AND RELATED FACILITIES. THE	
	RESULT OF RECLA	MATION	ACTIVITI	, AND PROTECT FACILITIES FROM DAMAGE AS A ES. SHOULD THE CONTRACTOR NEED TO CROSS RUCTION EQUIPMENT, THE CONTRACTOR SHALL	
	THE PIPELINE, AND	PRESE	NT THE PLA	LINE(S) FROM DAMAGE, MEET WITH THE OWNER OF AN TO THE PIPELINE OWNER PRIOR TO BEGINNING	
	MAY BE CROSSE	D PROV	IDED THA	E PIPELINE. ENERVEST INDICATED THAT PIPELINES AT PROTECTION IS MAINTAINED. A POSSIBLE DE COVERING THE PIPELINE WITH 3 FEET MINIMUM	
	ROCK RIPRAP TO	PROVID	E A STABL	PIPE. THE SOIL PAD SHOULD BE SURFACED WITH E, DURABLE SURFACE FOR THE CROSSING. THE INSPECT AND MAINTAIN THE CROSSING IN A	
	MANNER TO PROT	ECT THI GAS PI	E PIPELINE. RODUCTION	THE CONTRACTOR SHALL BE RESPONSIBLE FOR N/TRANSMISSION FACILITIES CAUSED BY OR AS A	
	RESULT OF THE CO	NTRACT	OR'S OPER	ATIONS.	$\mathbf{O}$
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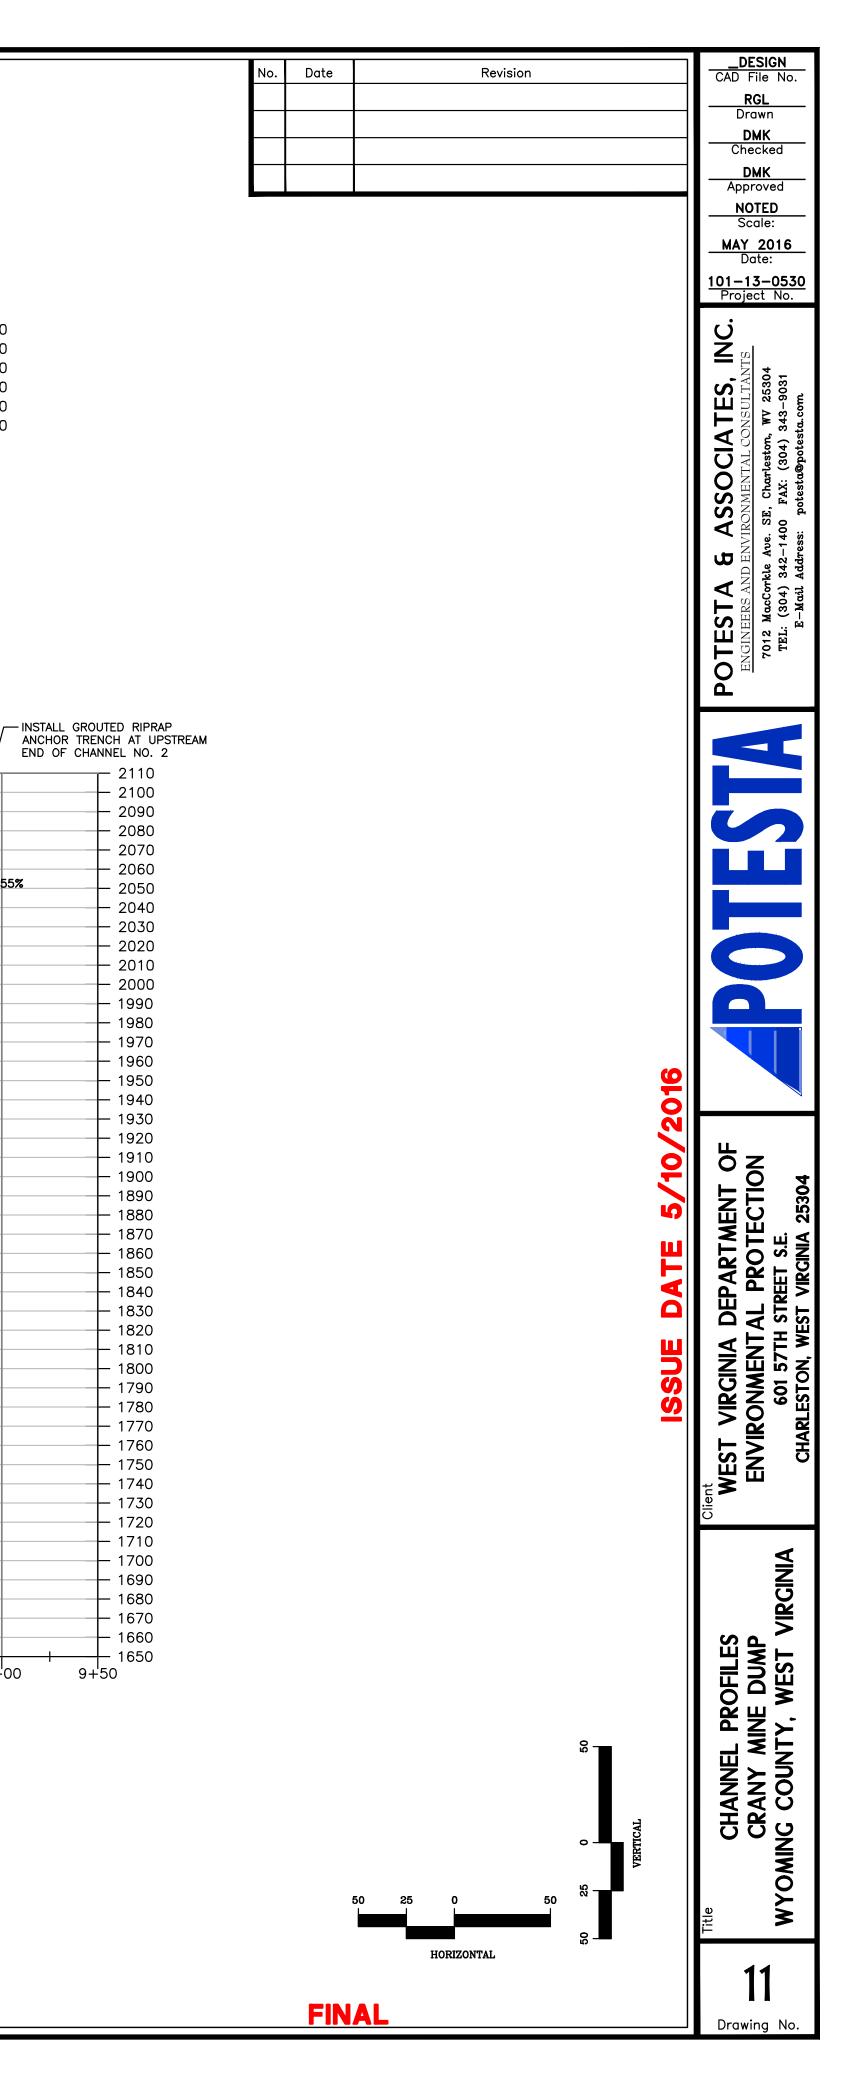


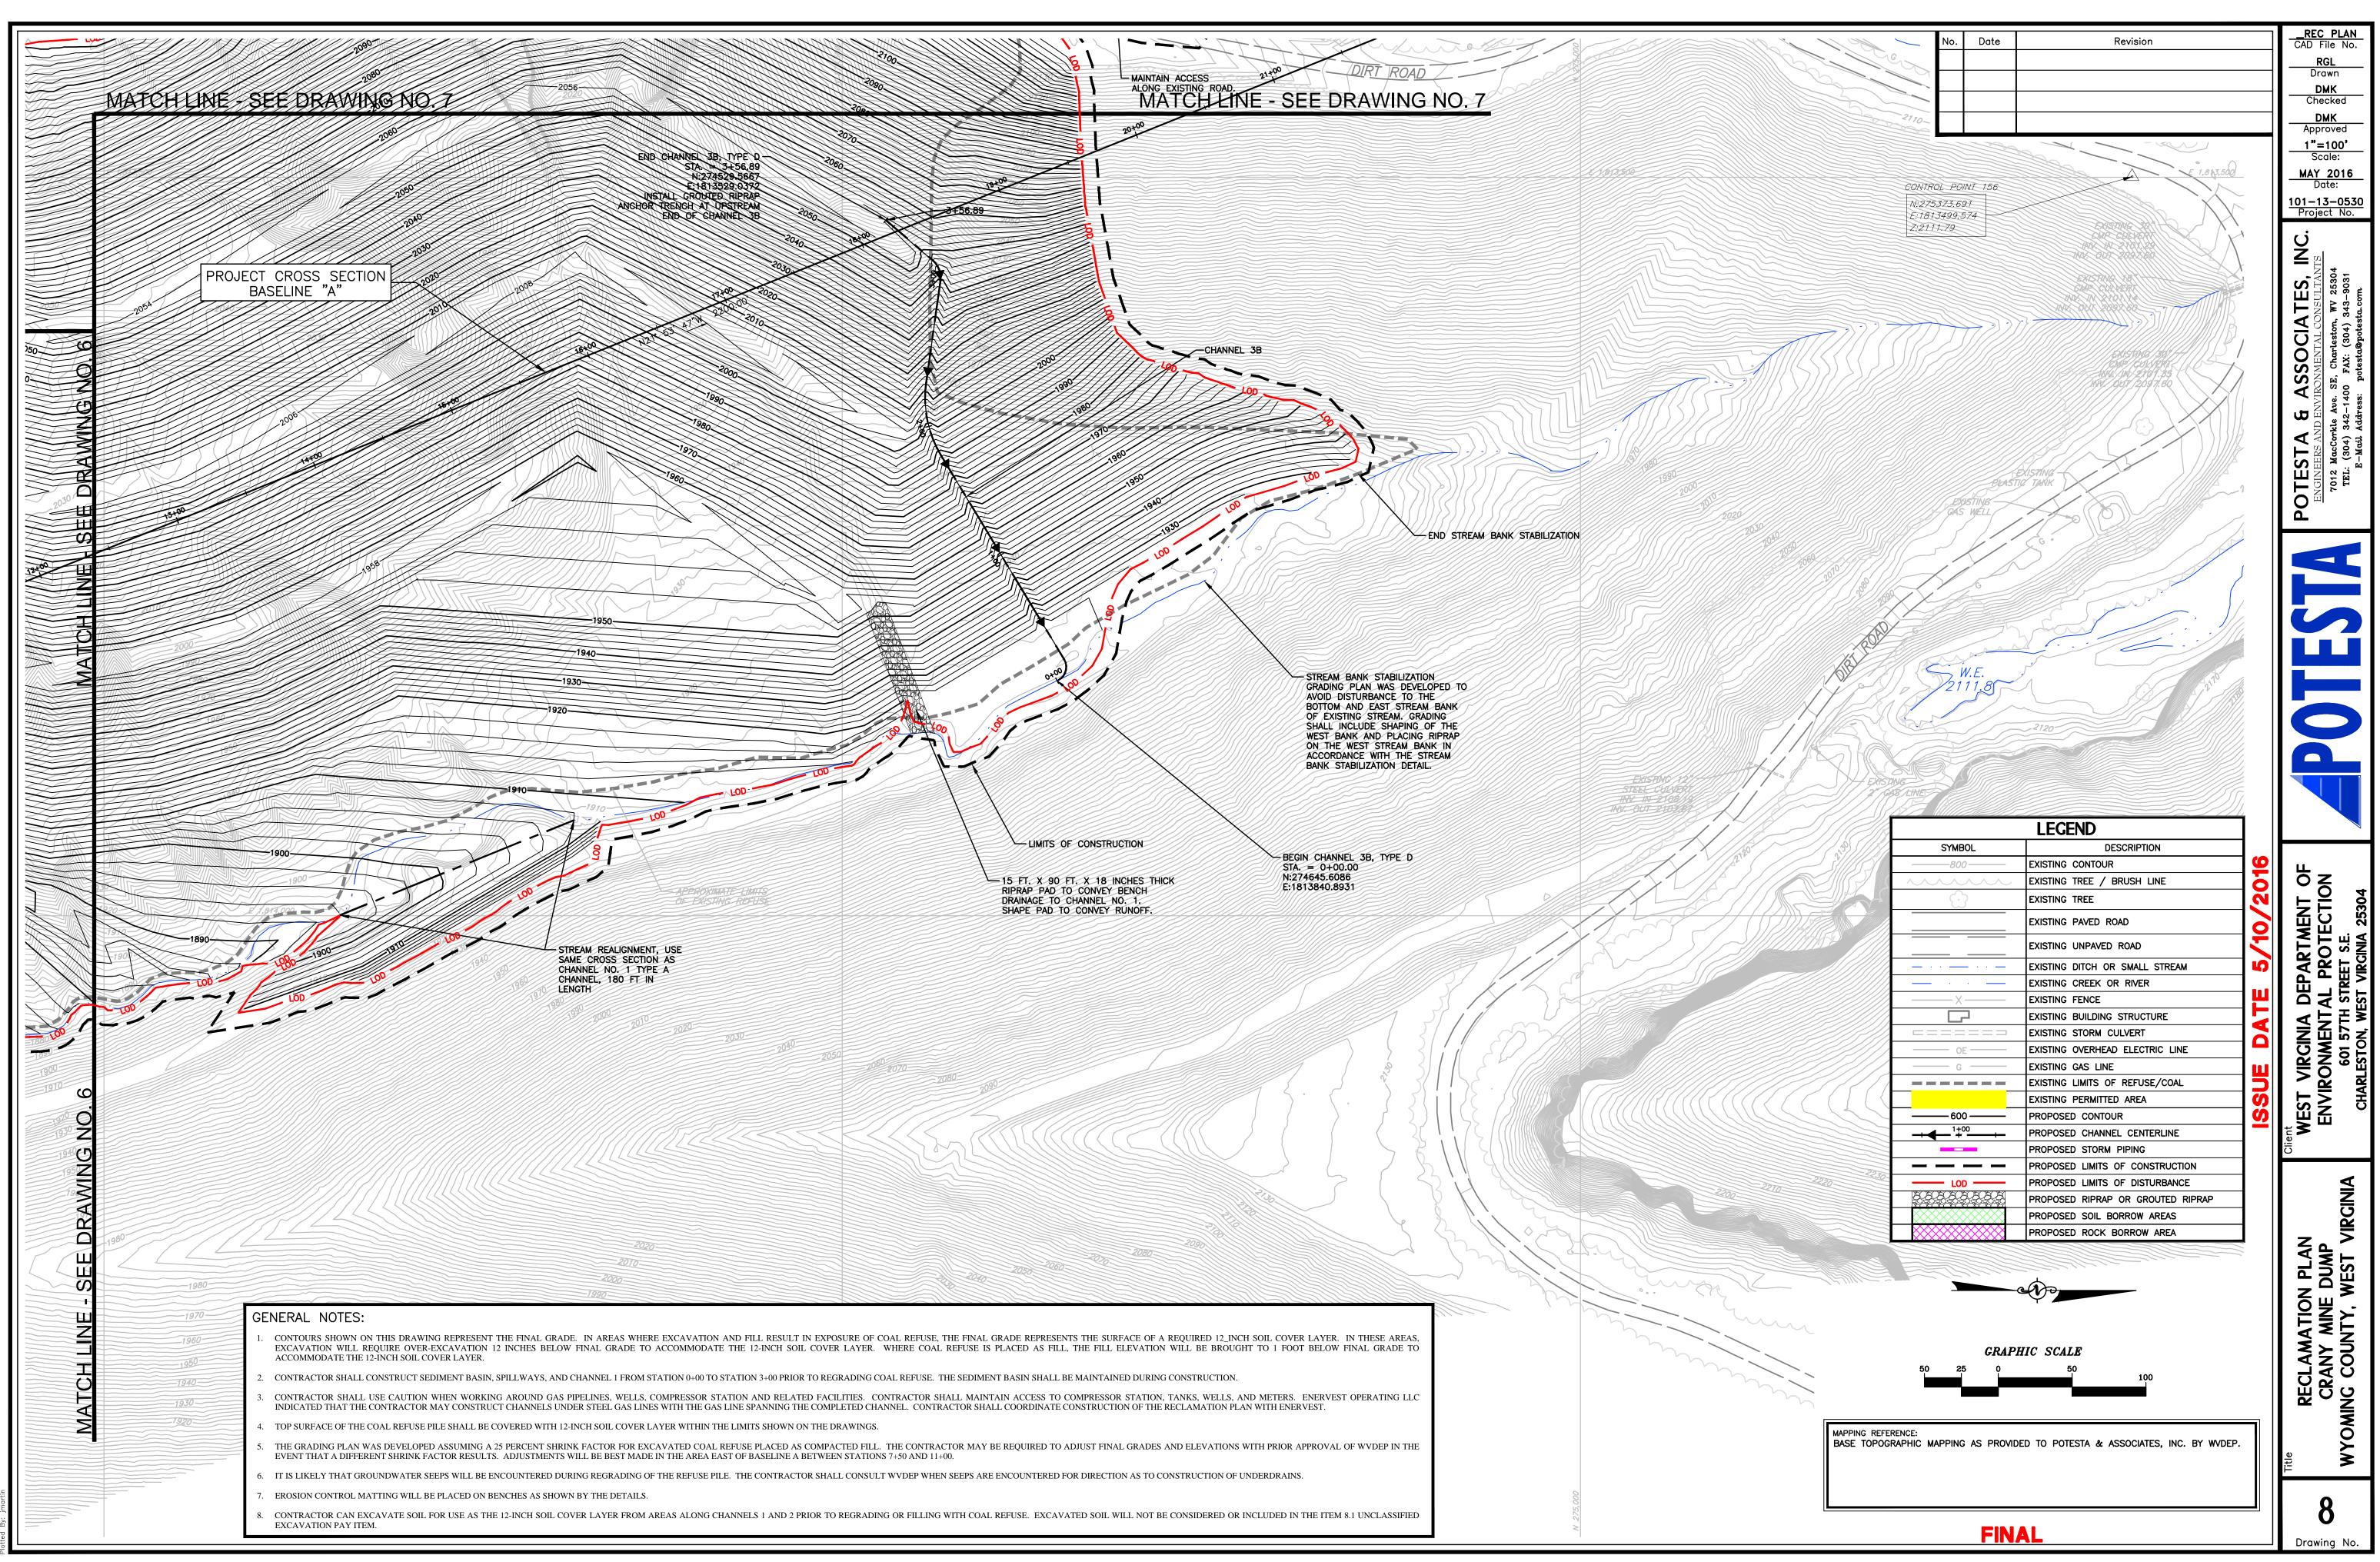





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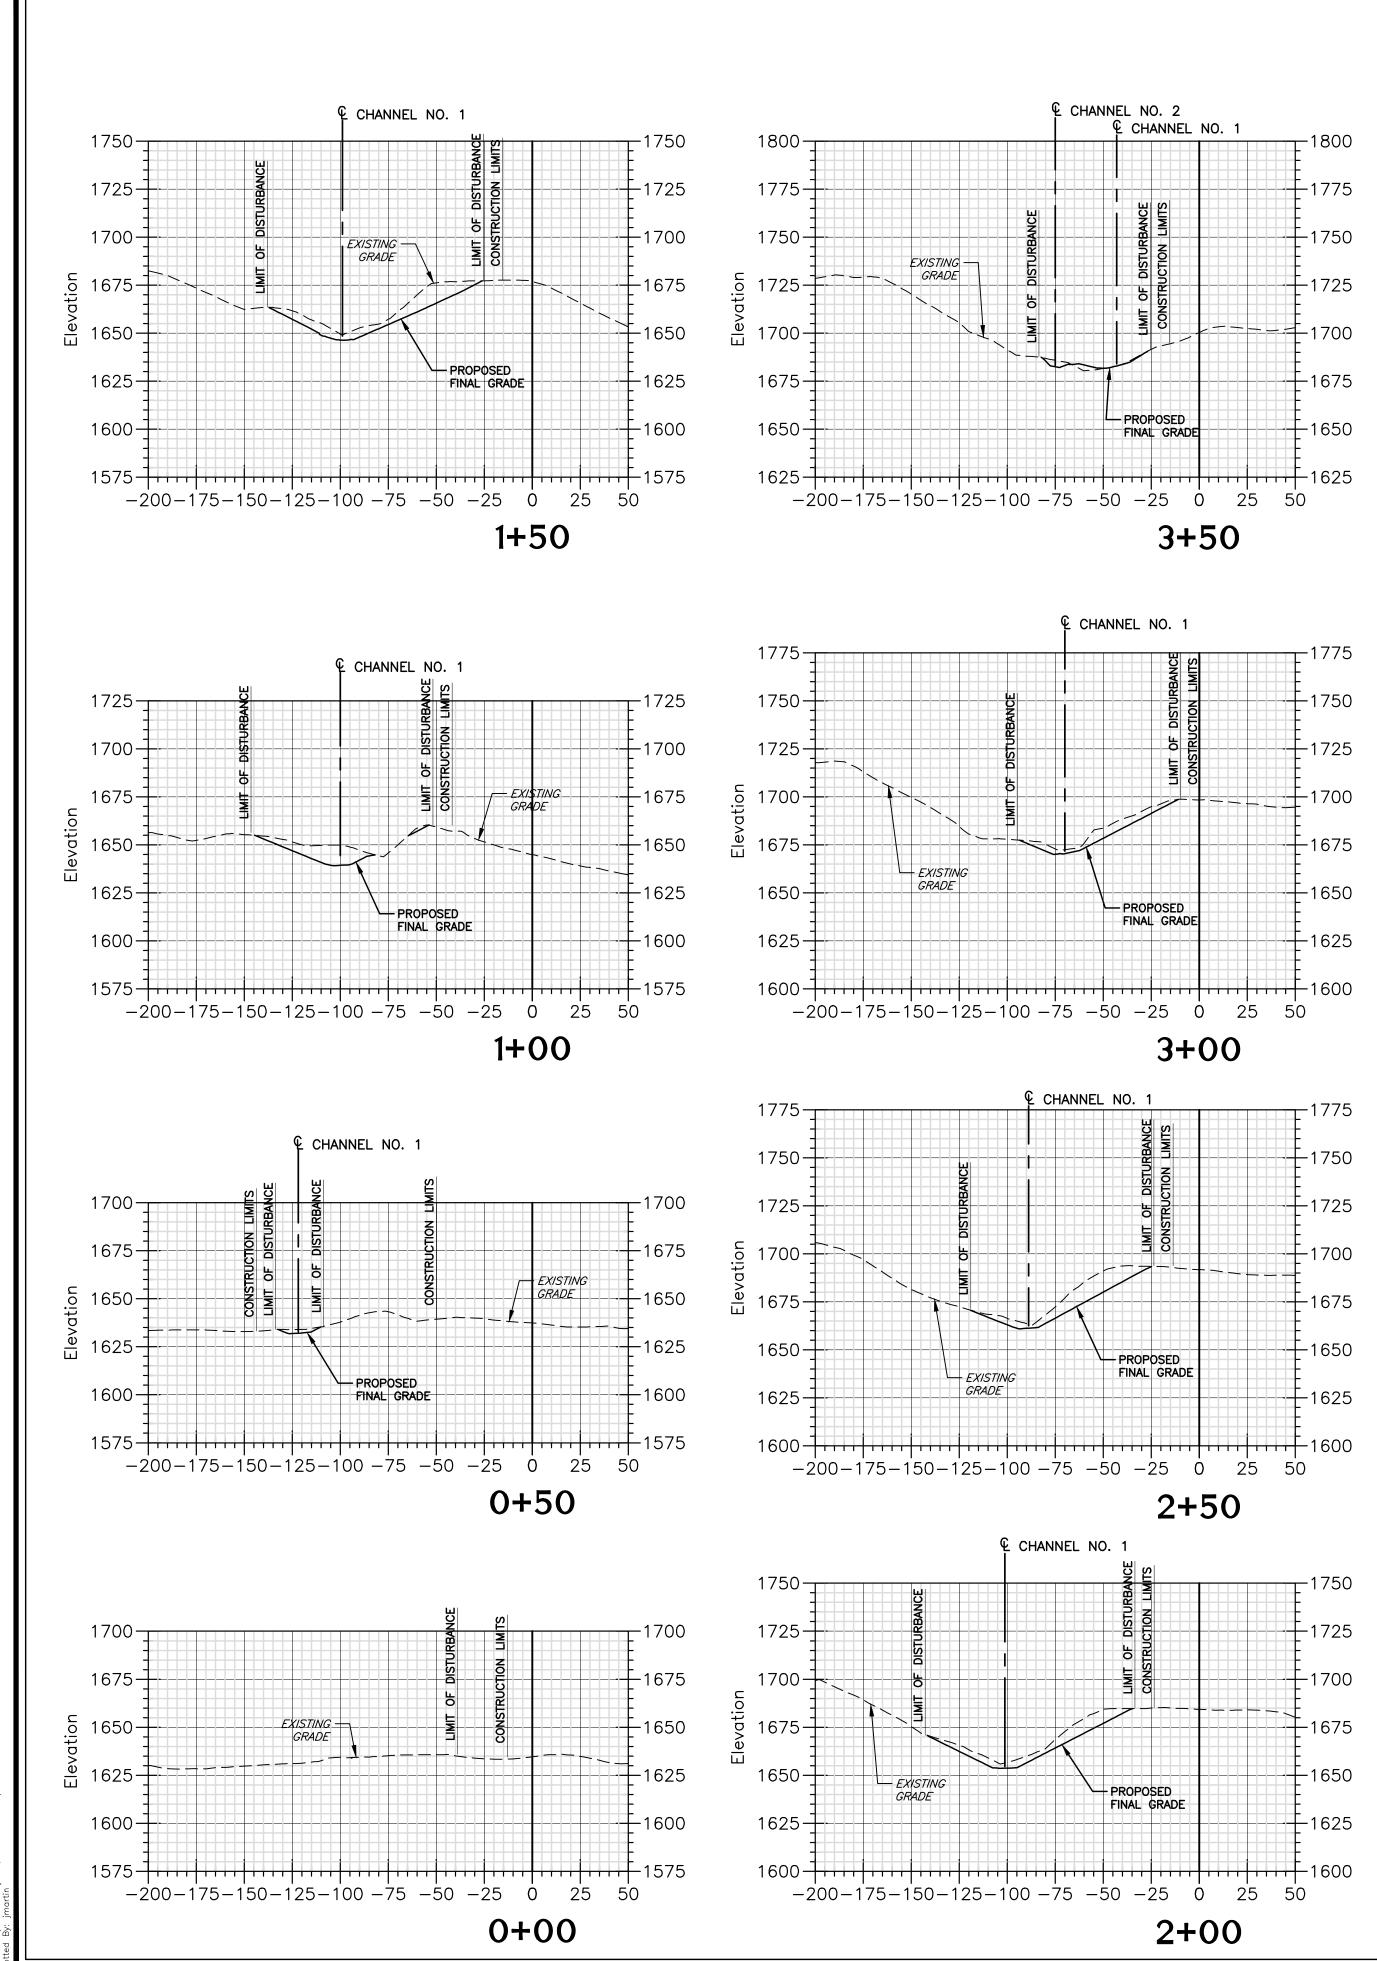
CHANNEL NO. 2 PROFILE




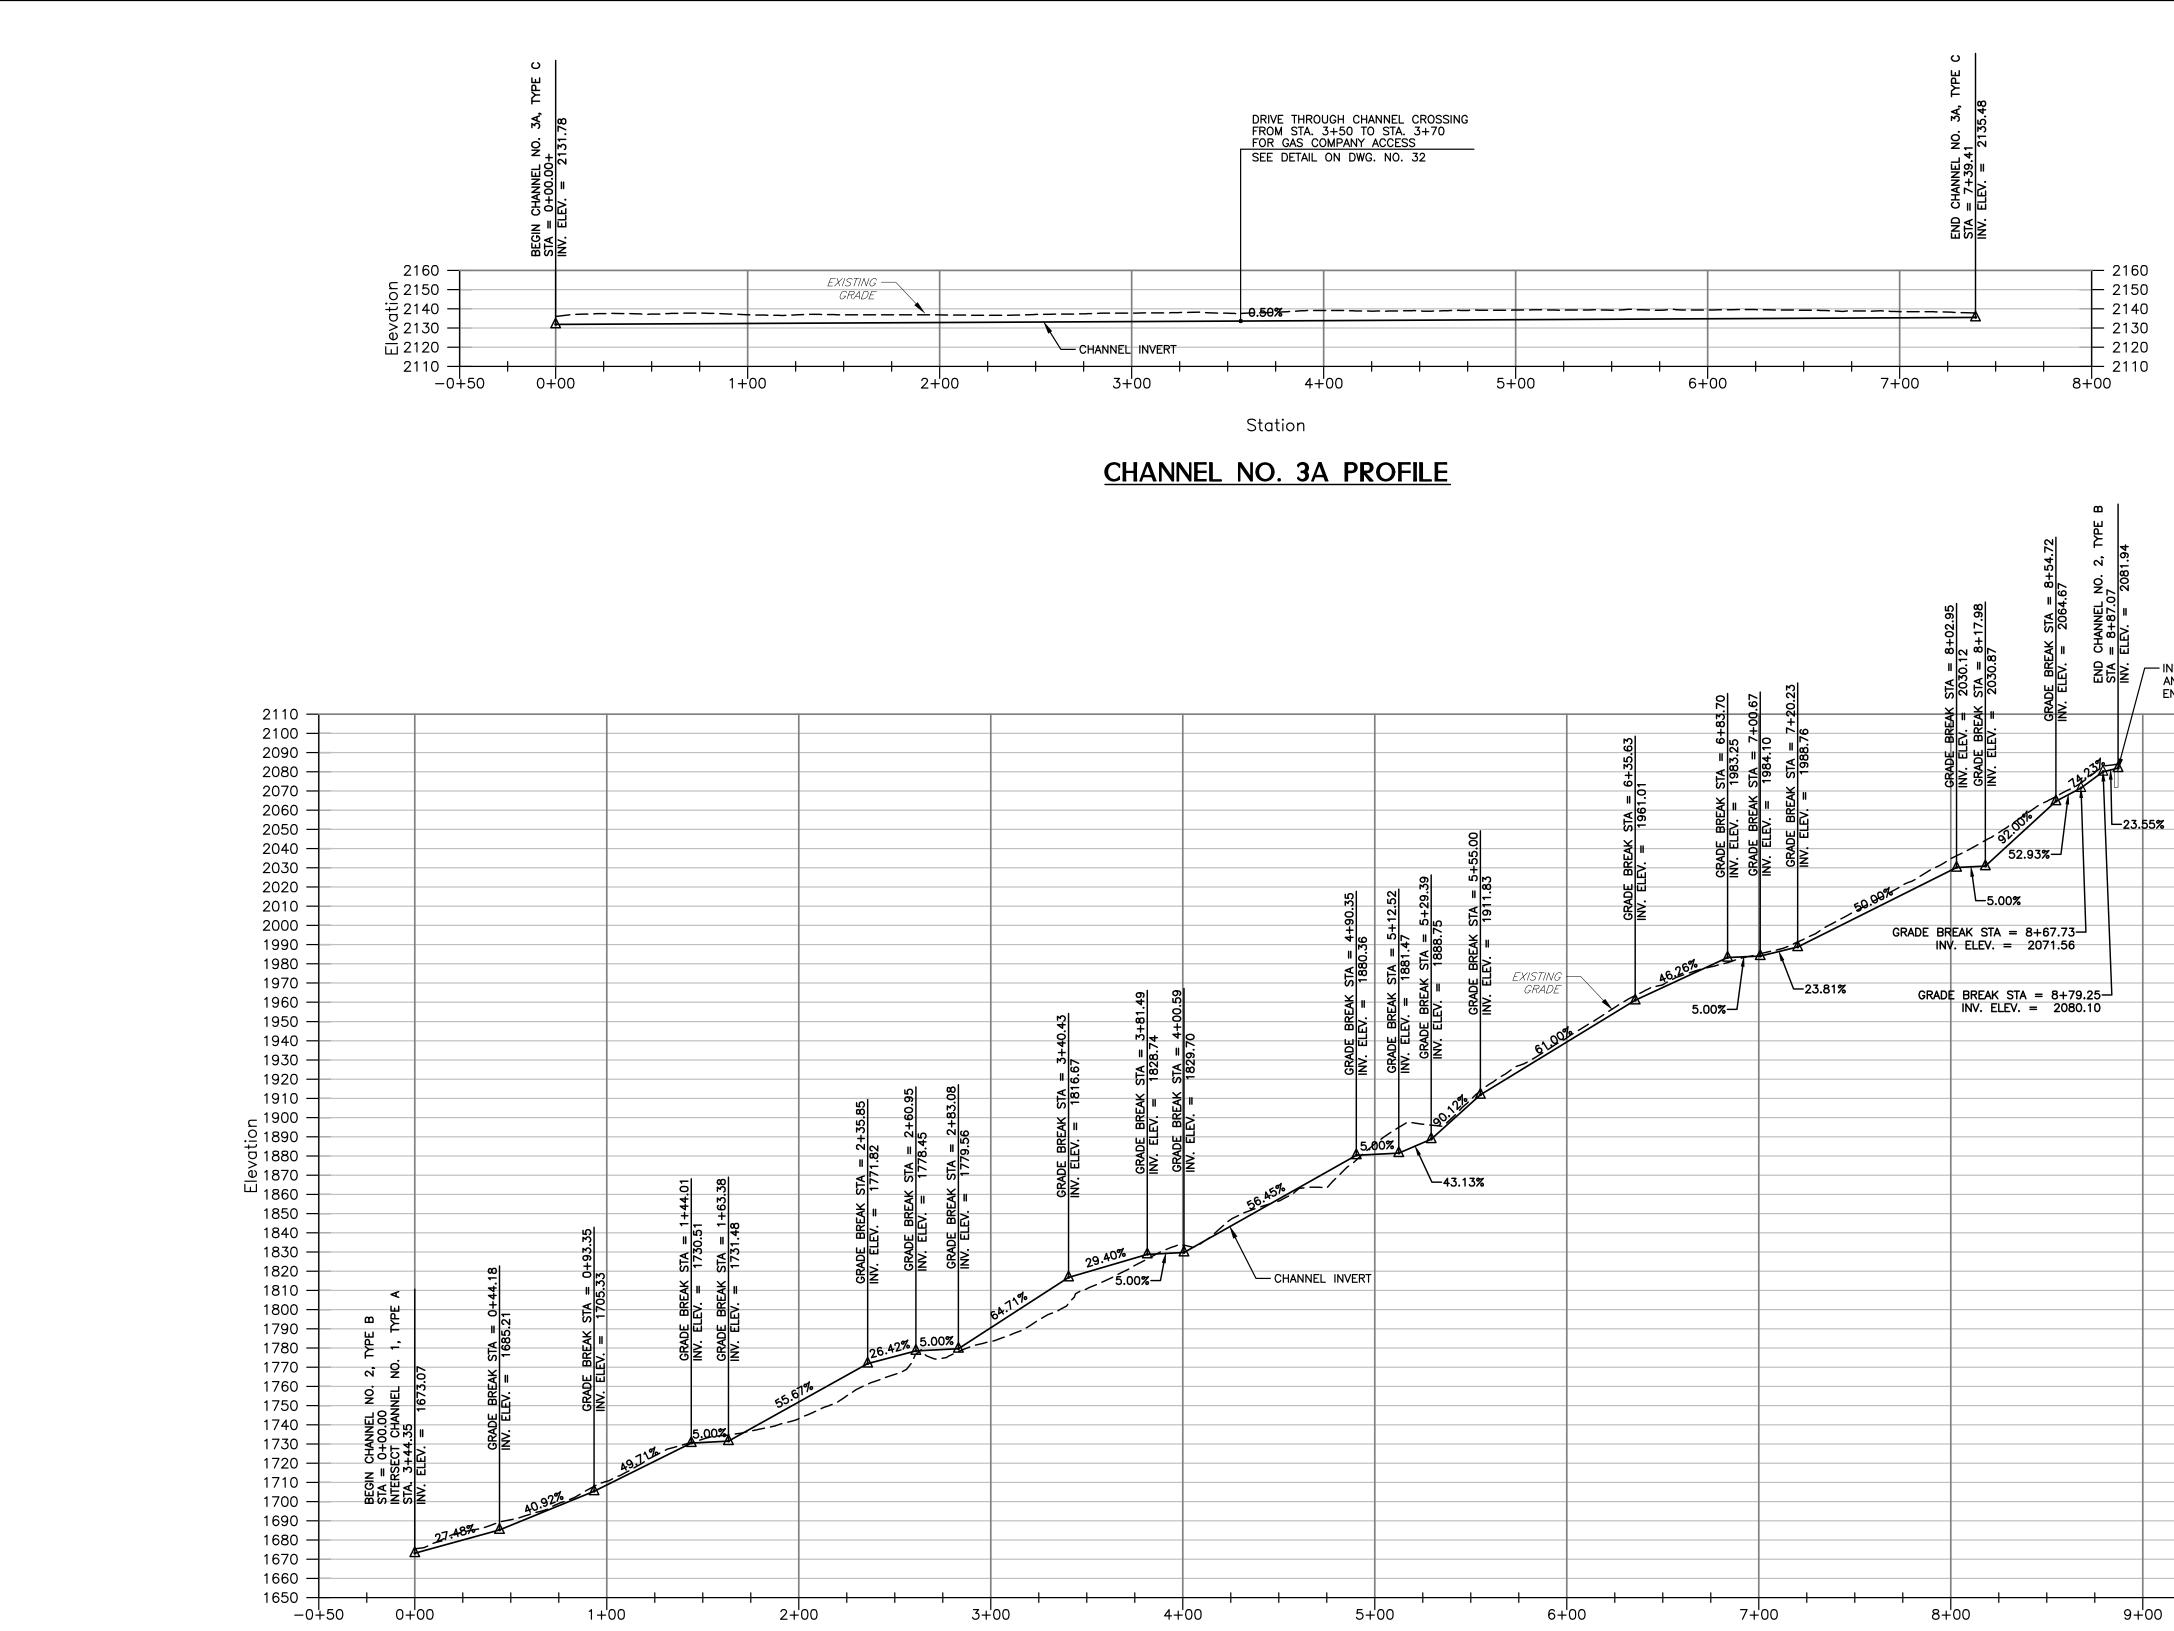


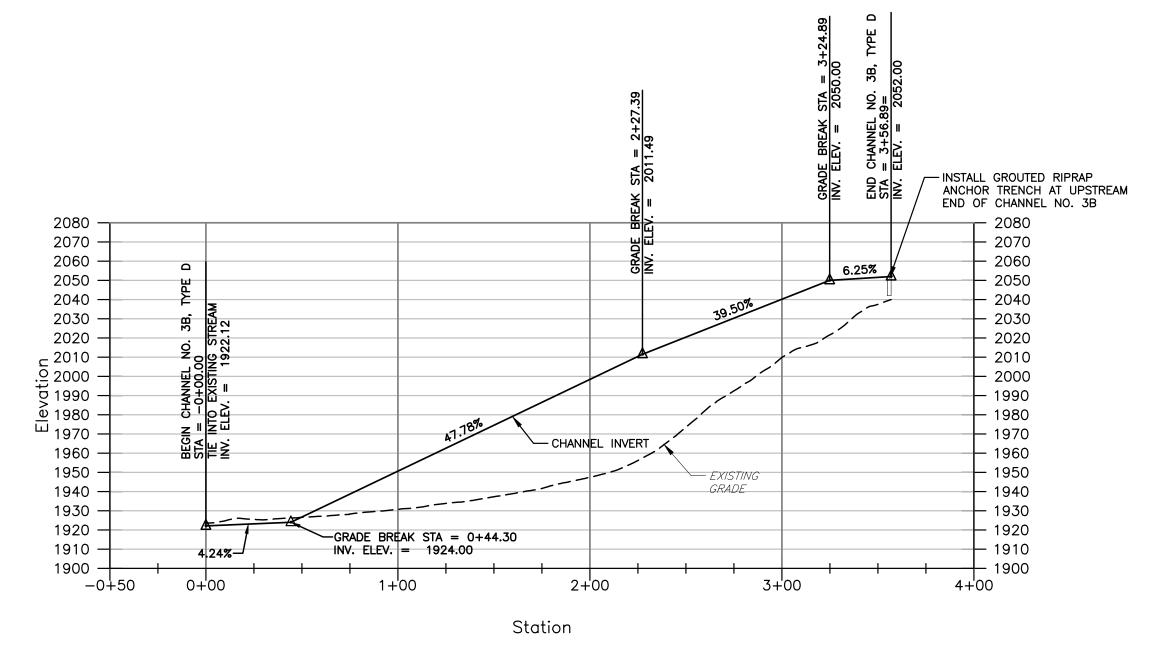




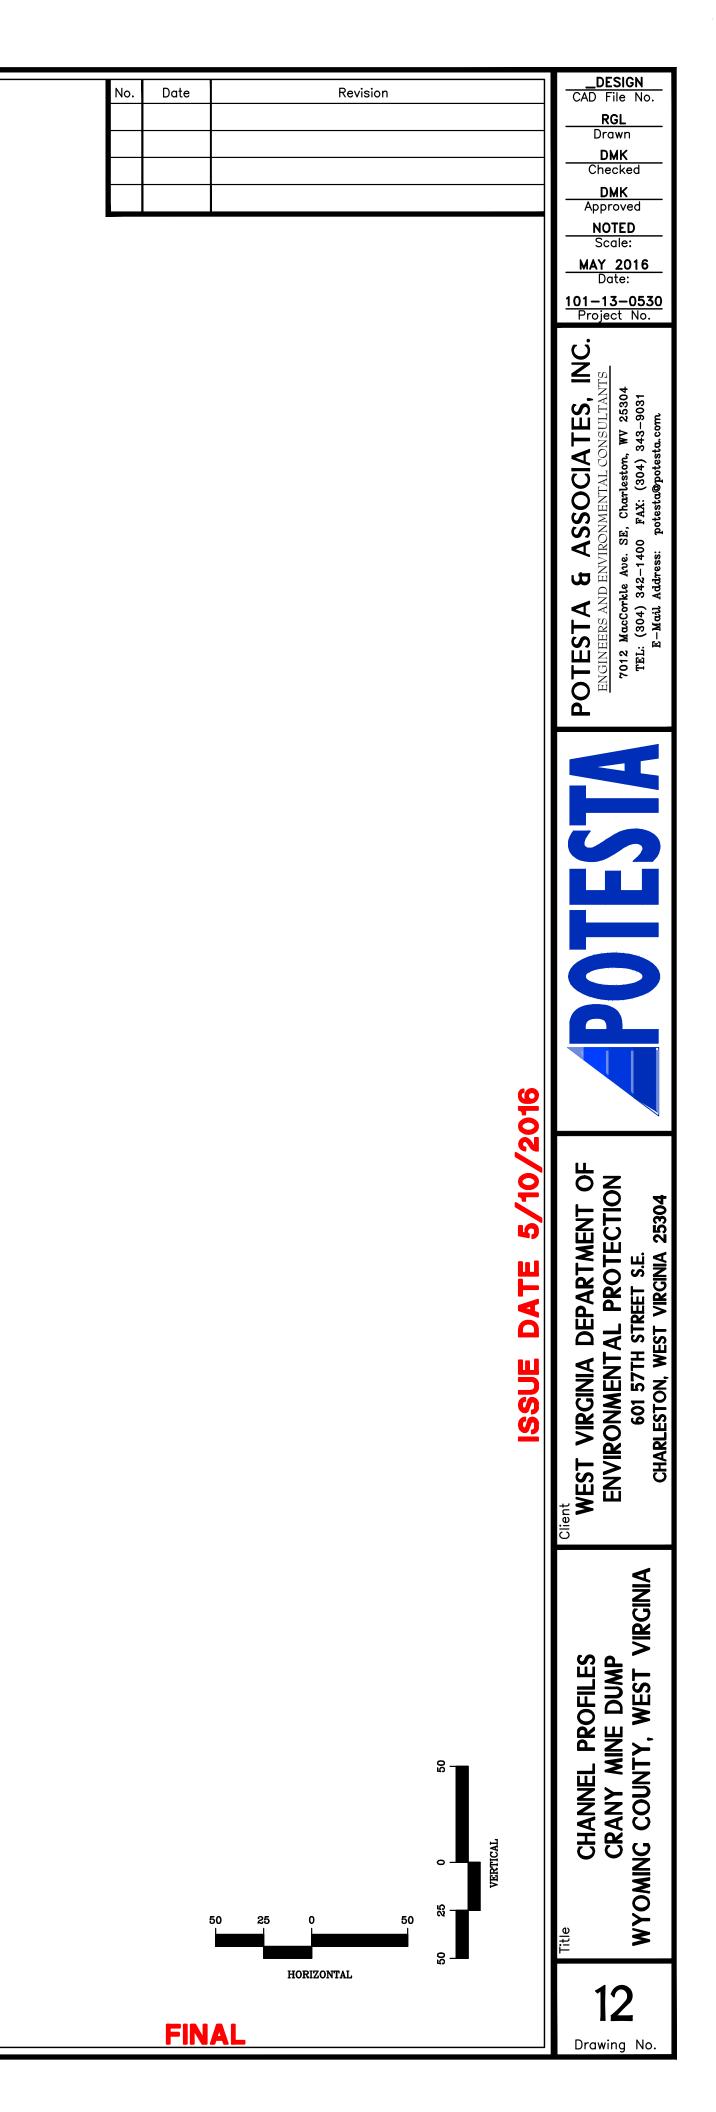


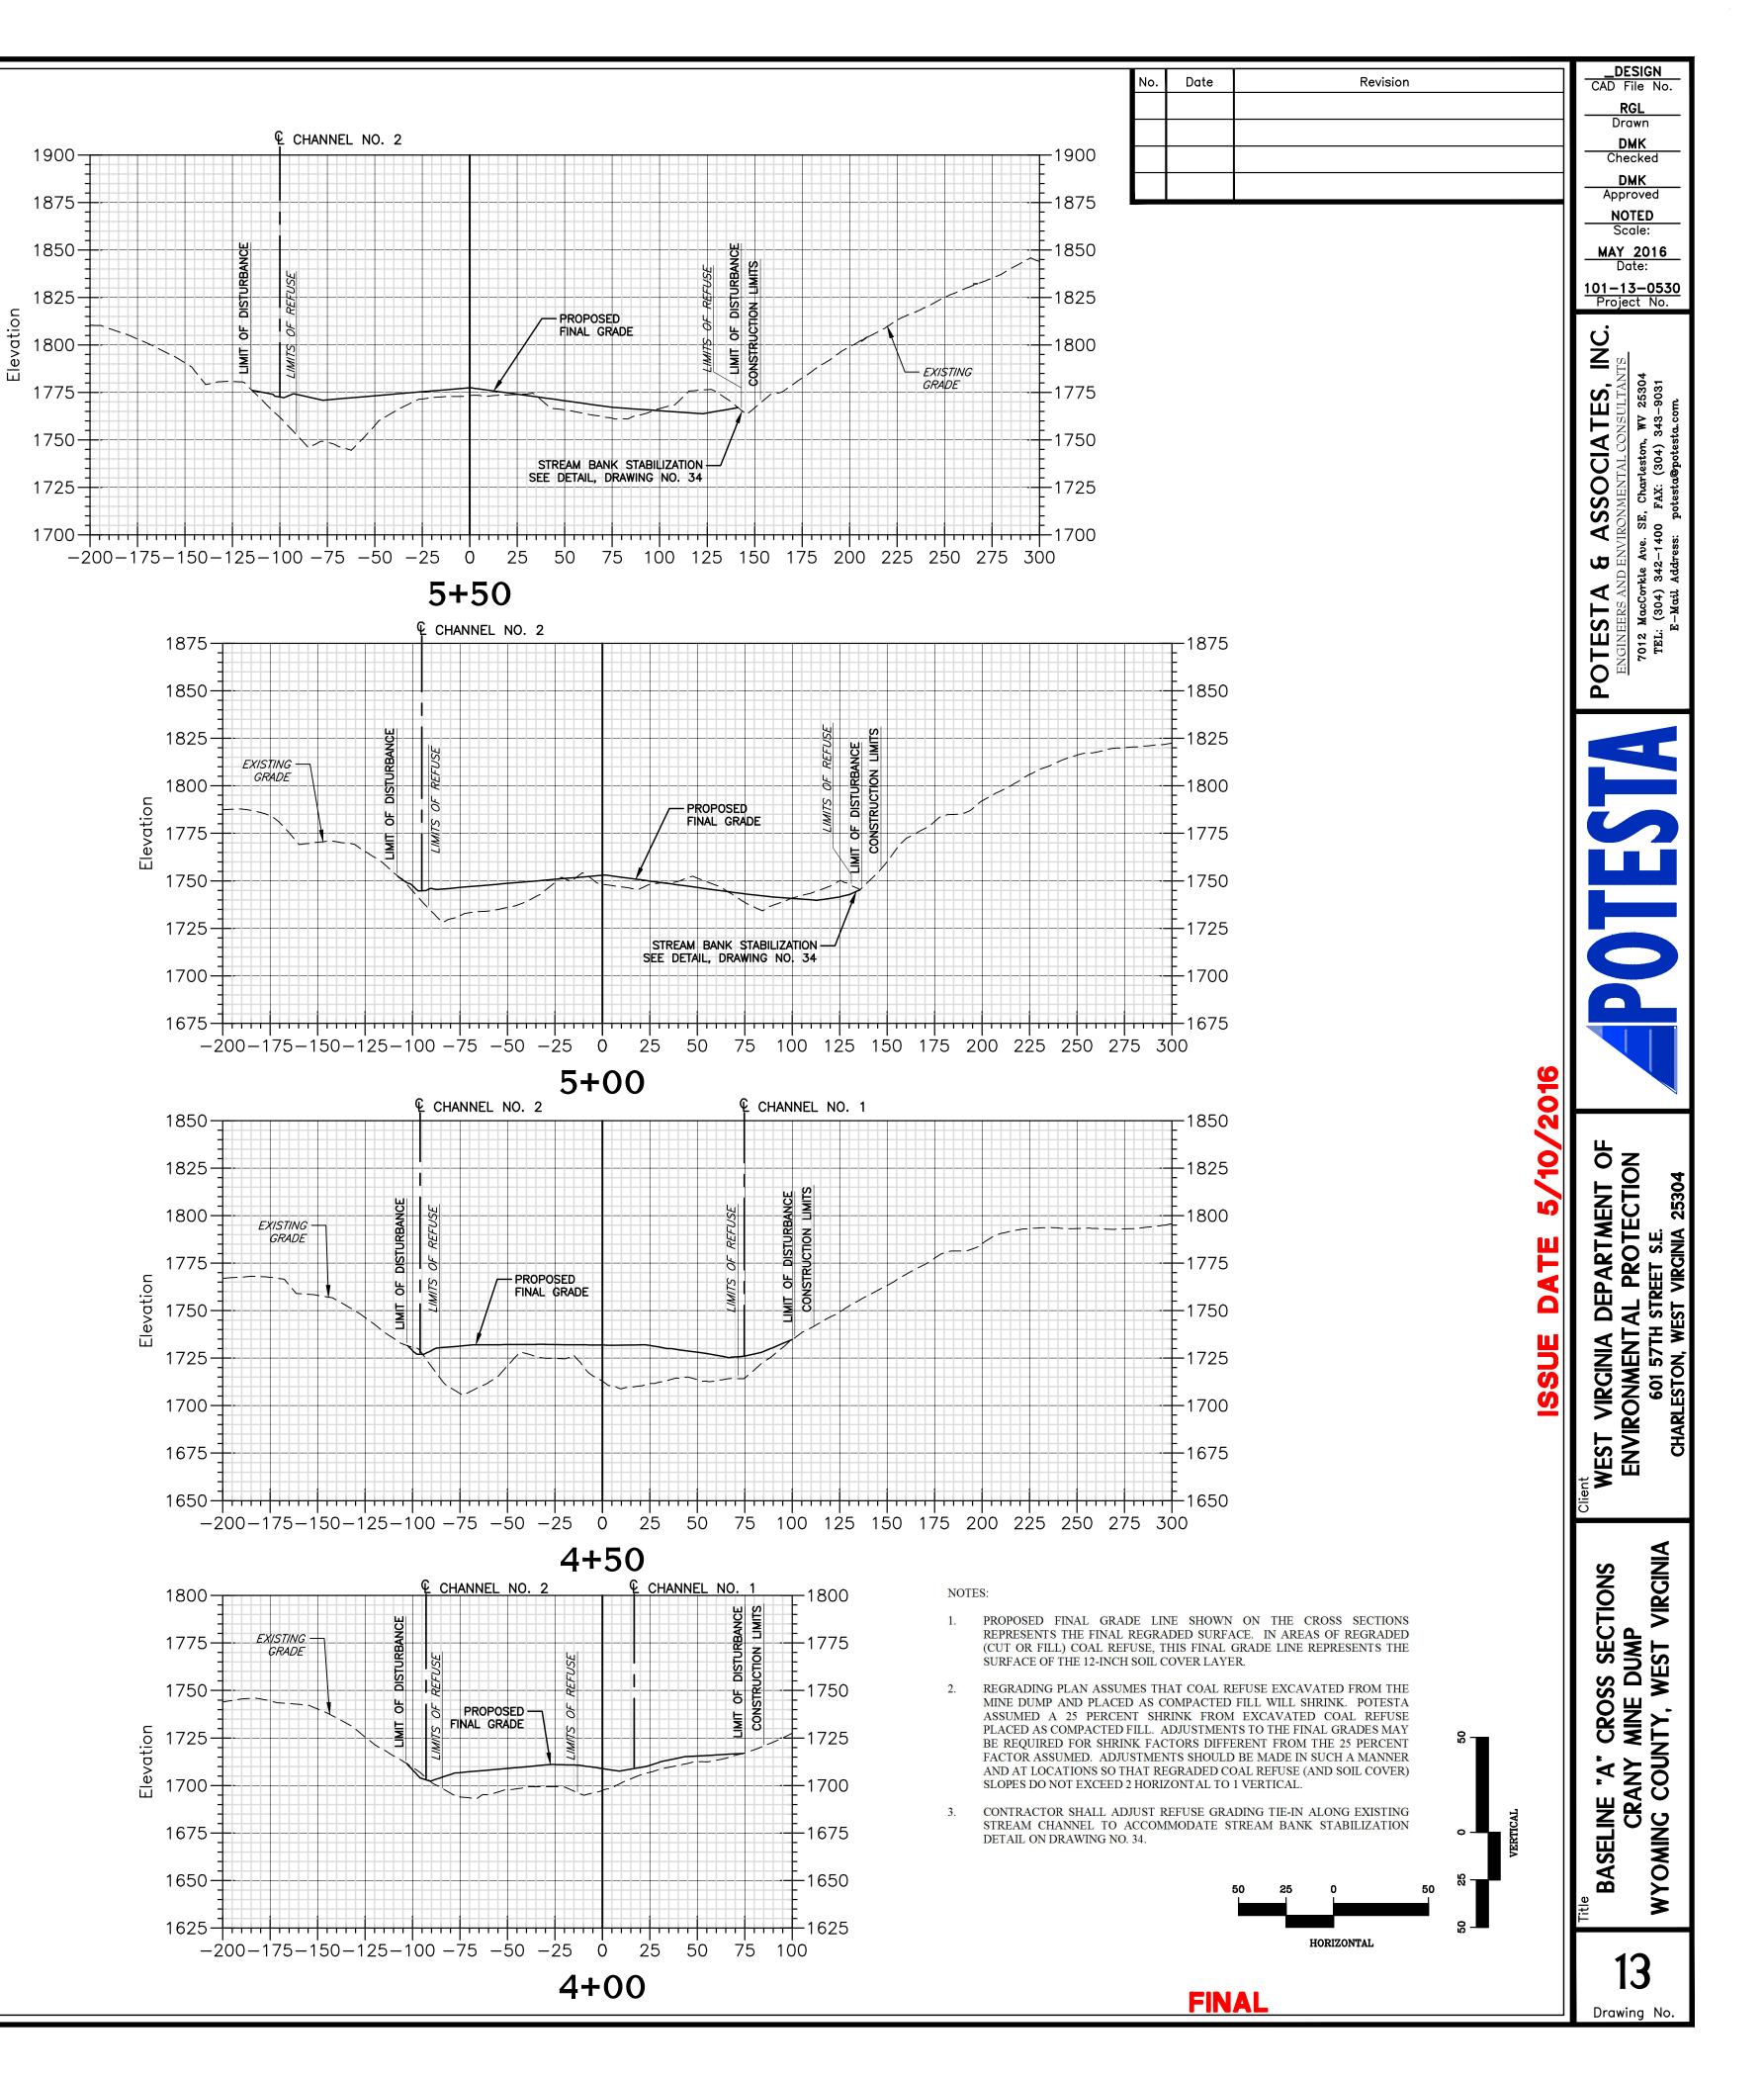

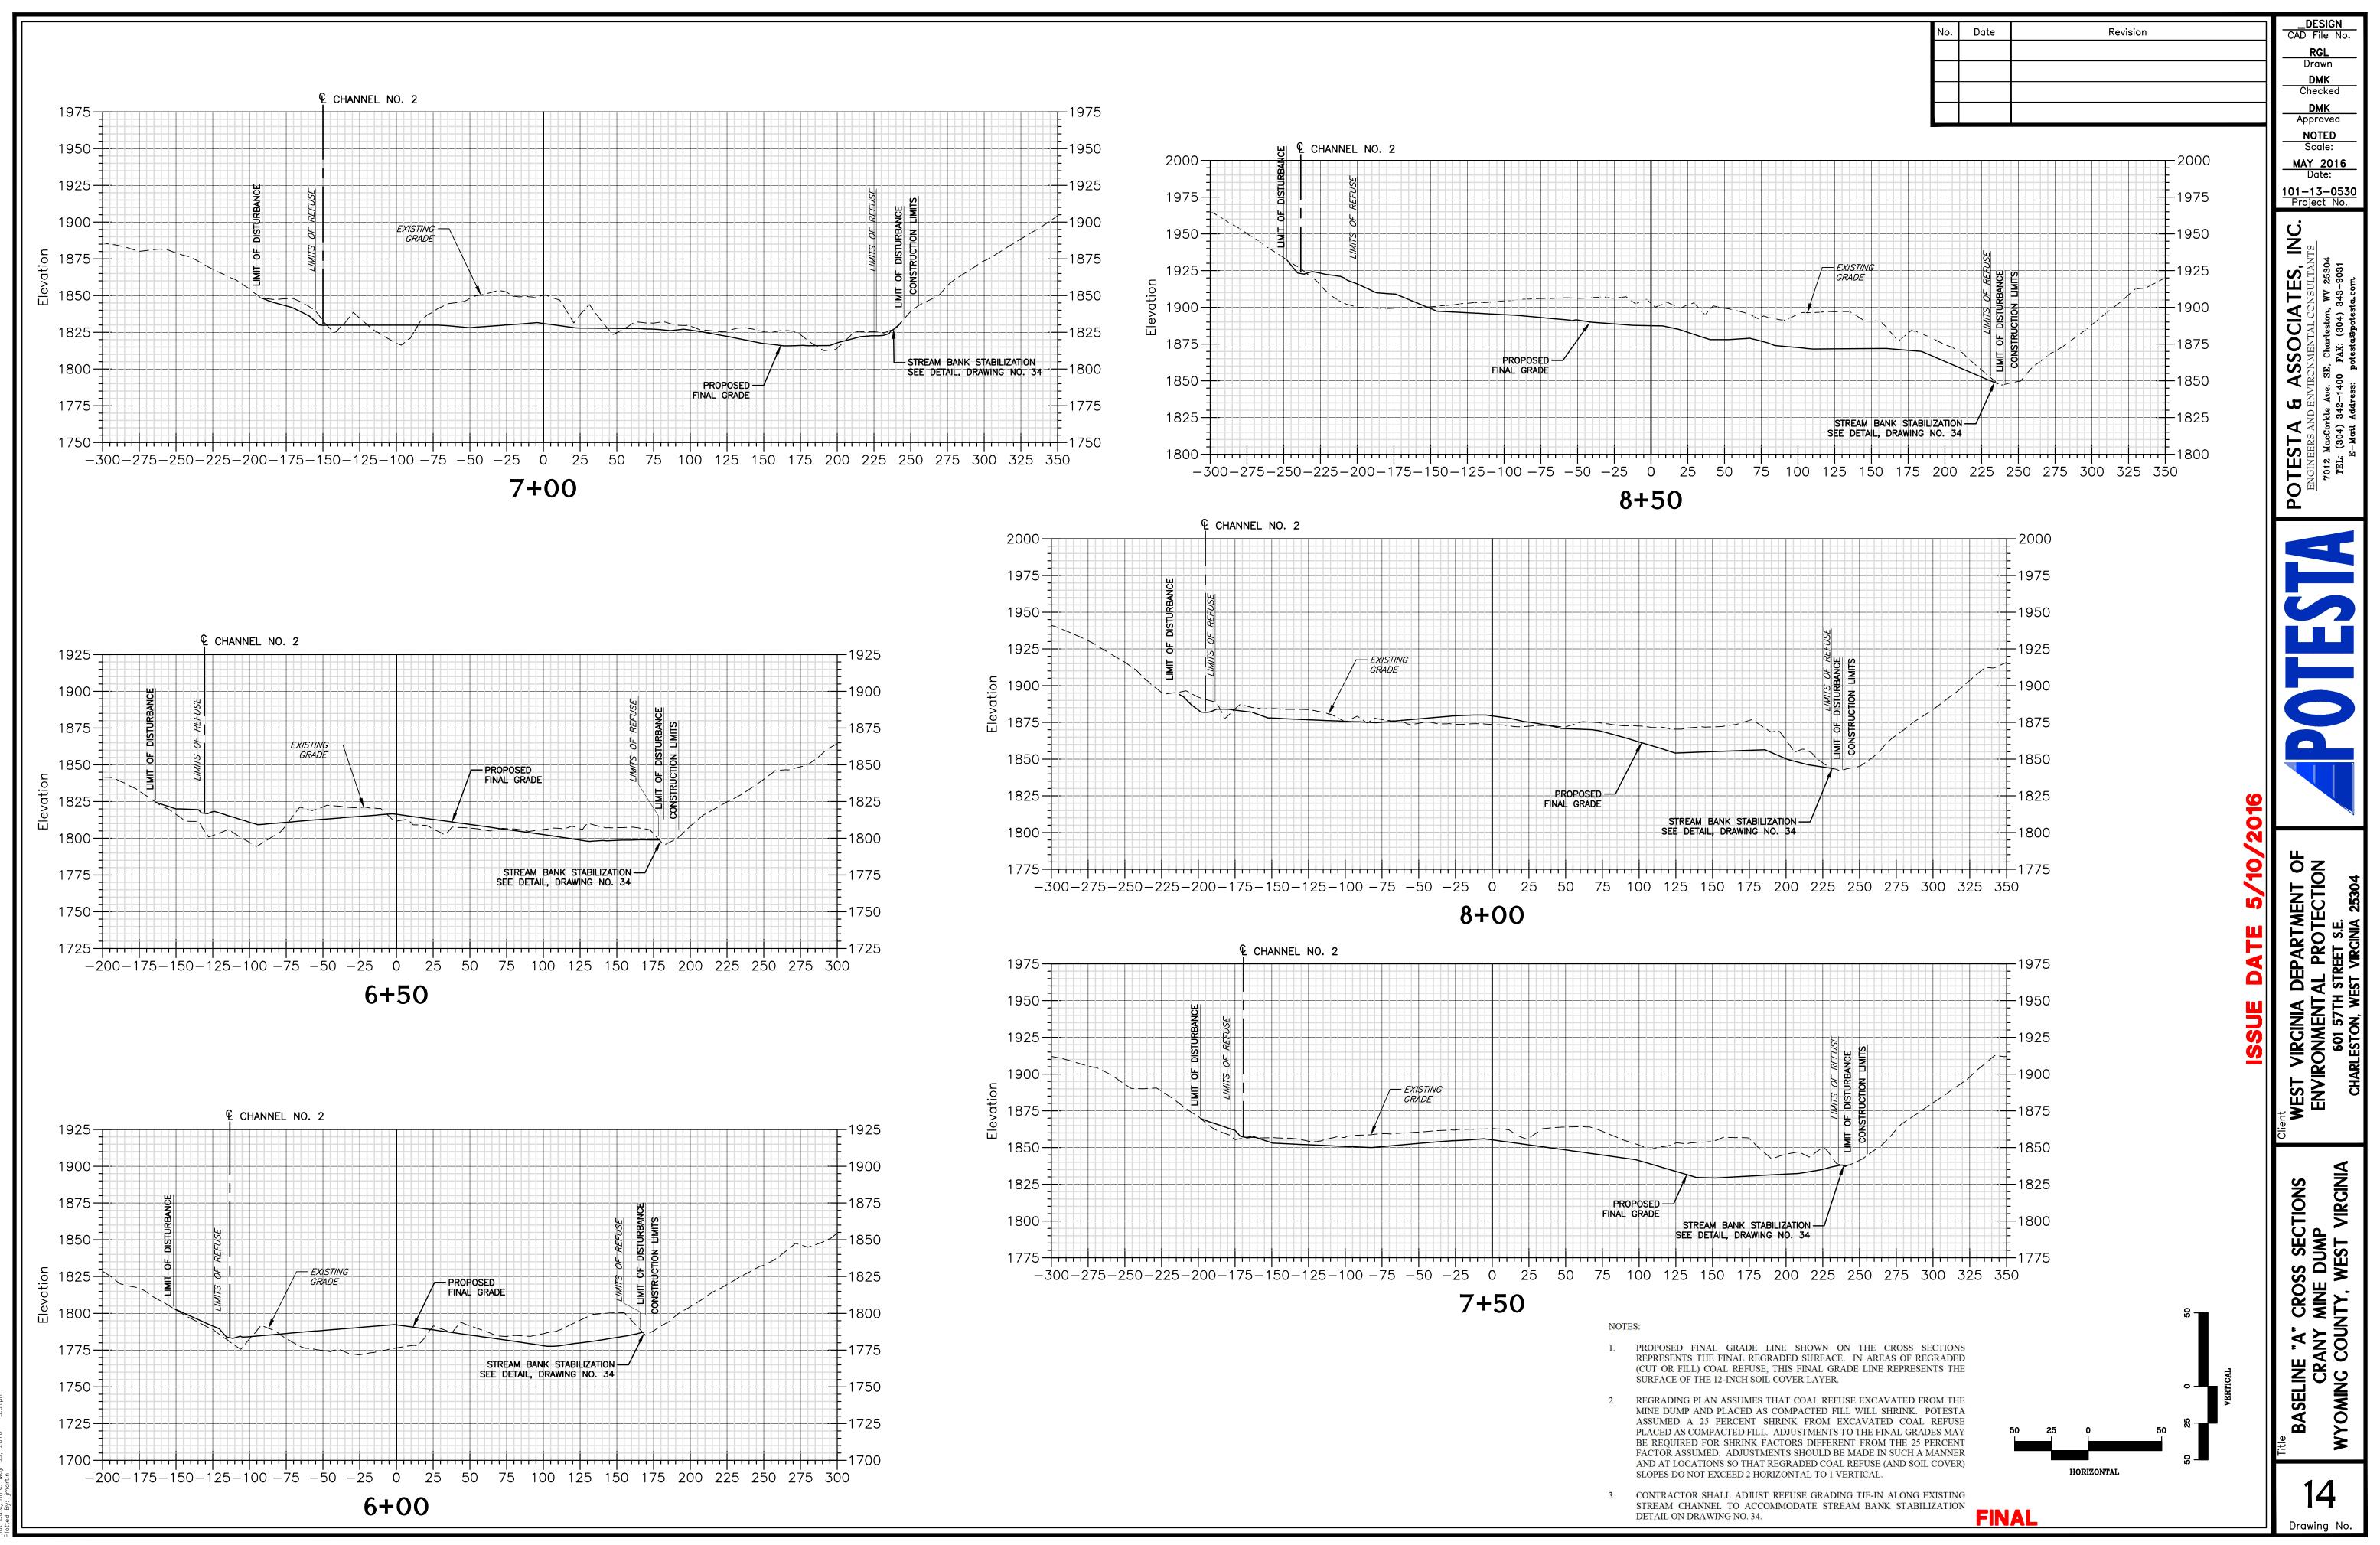


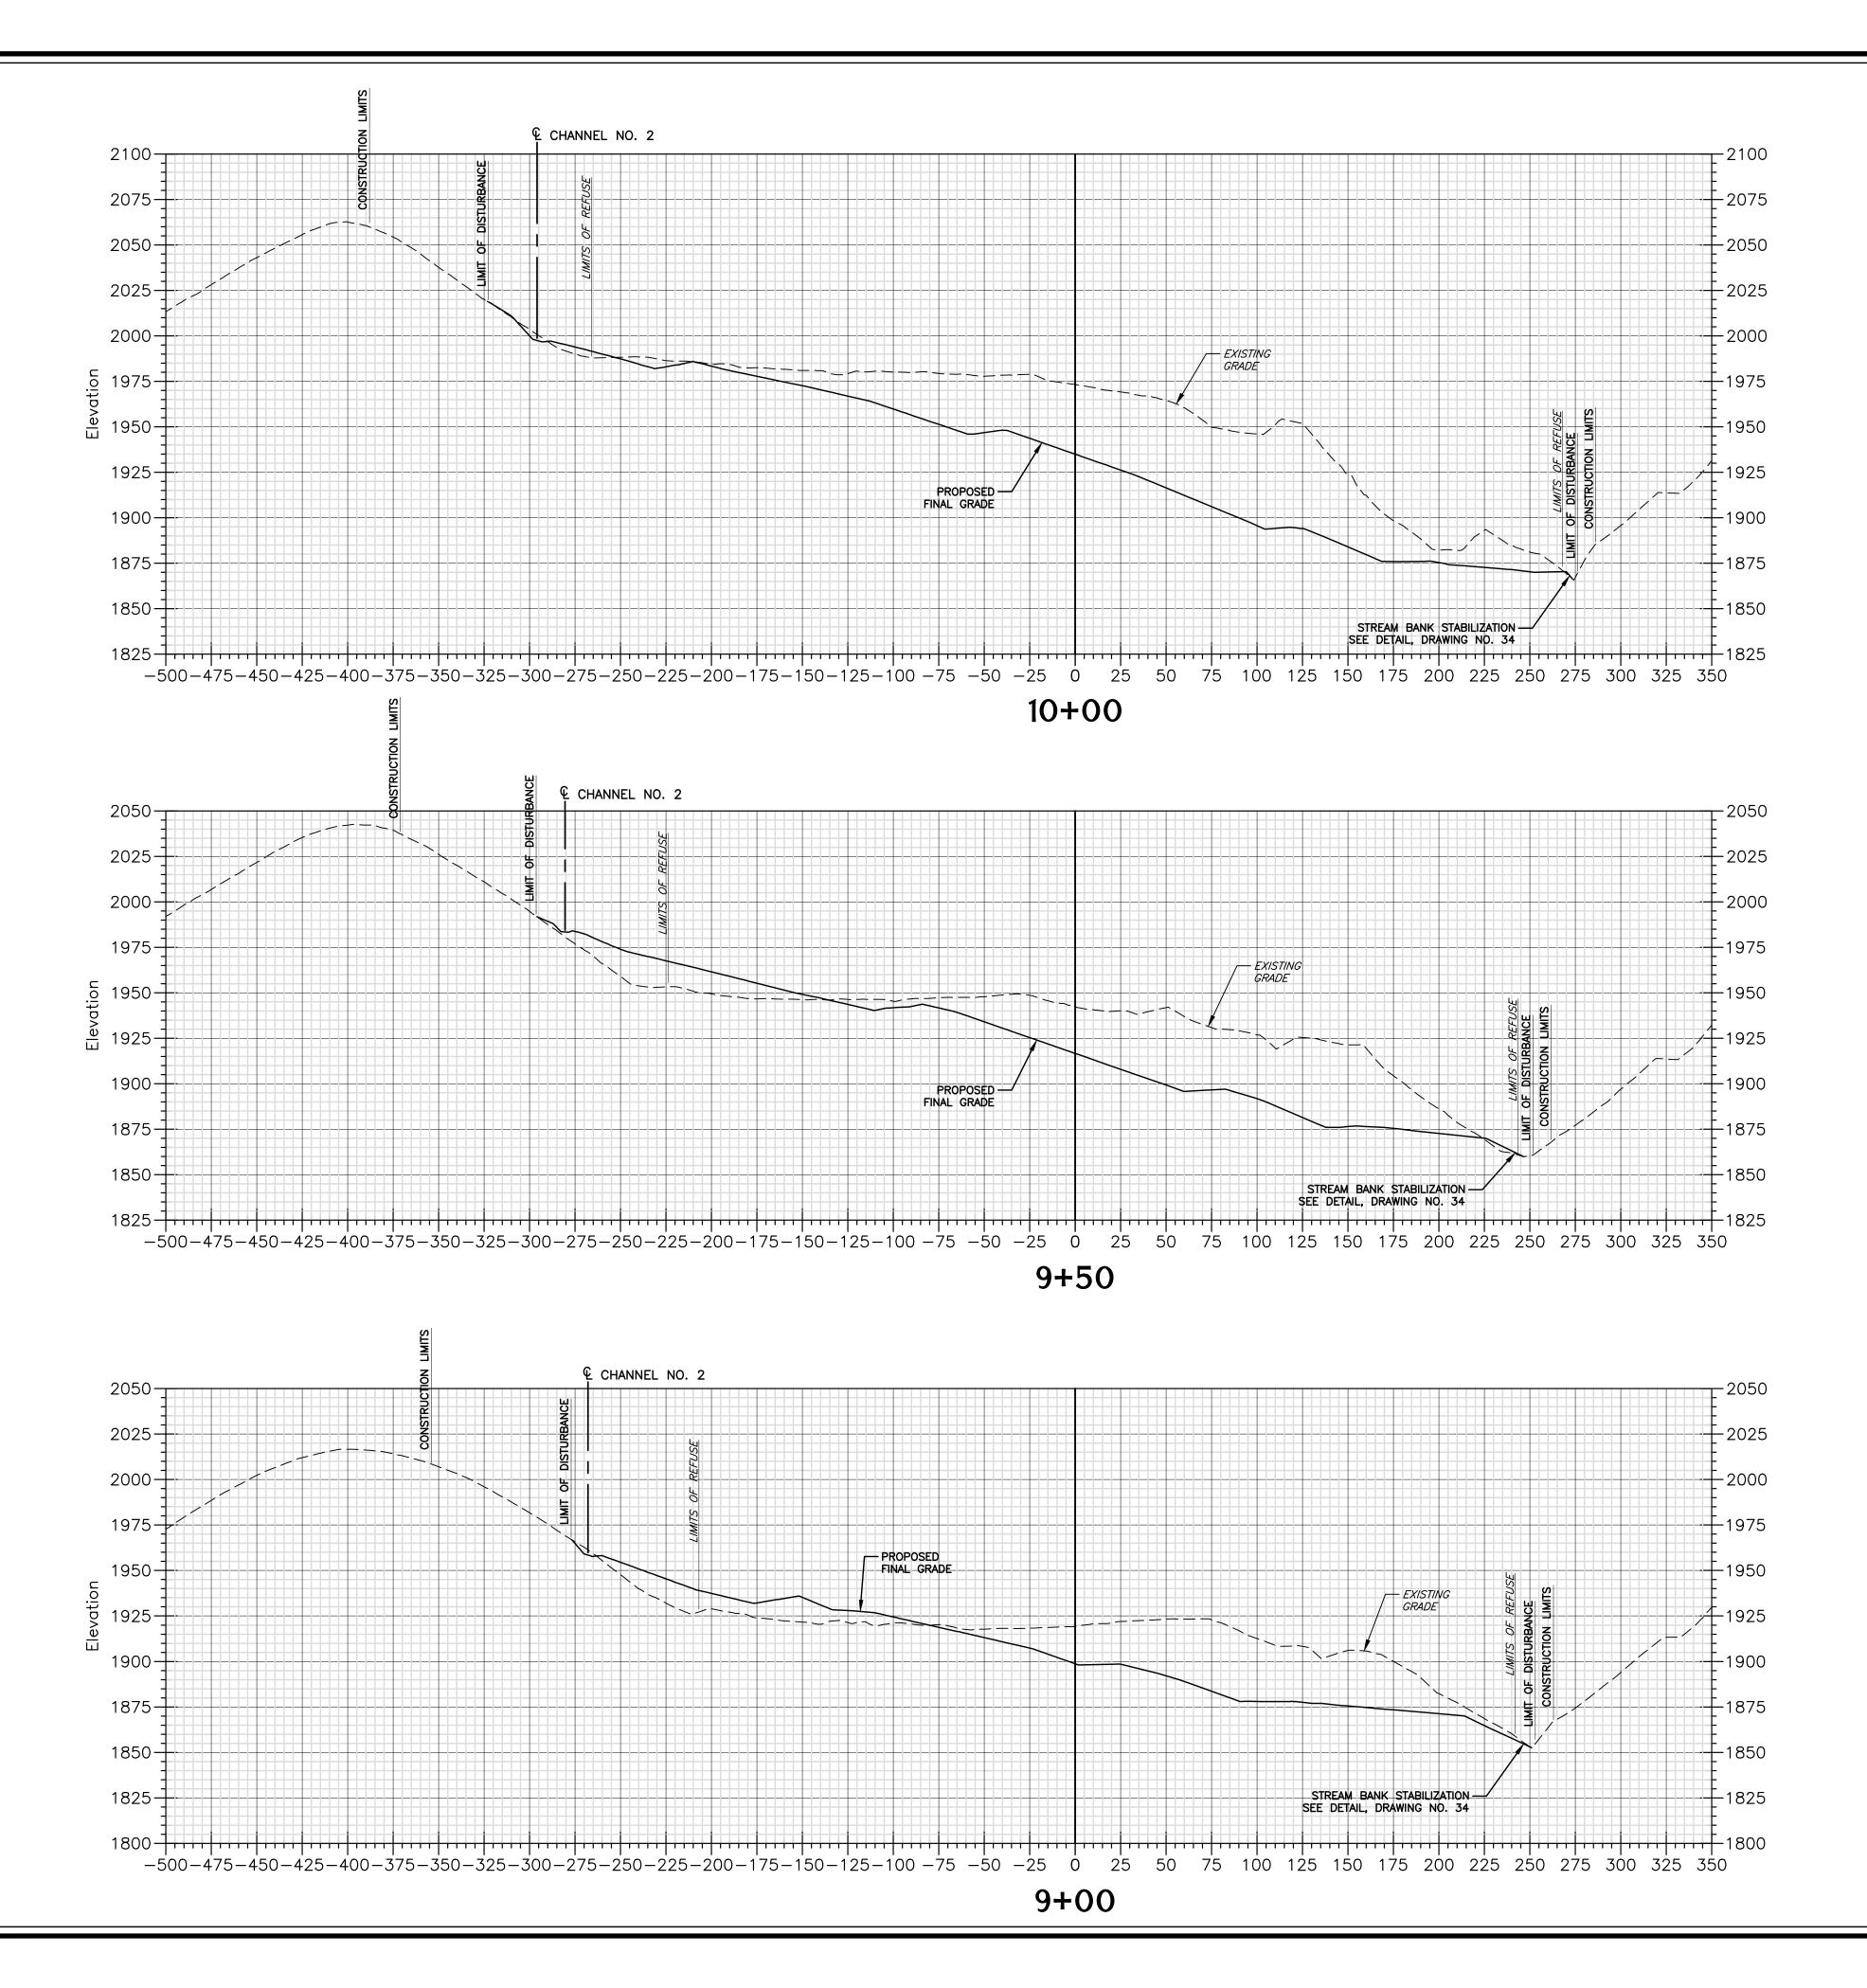



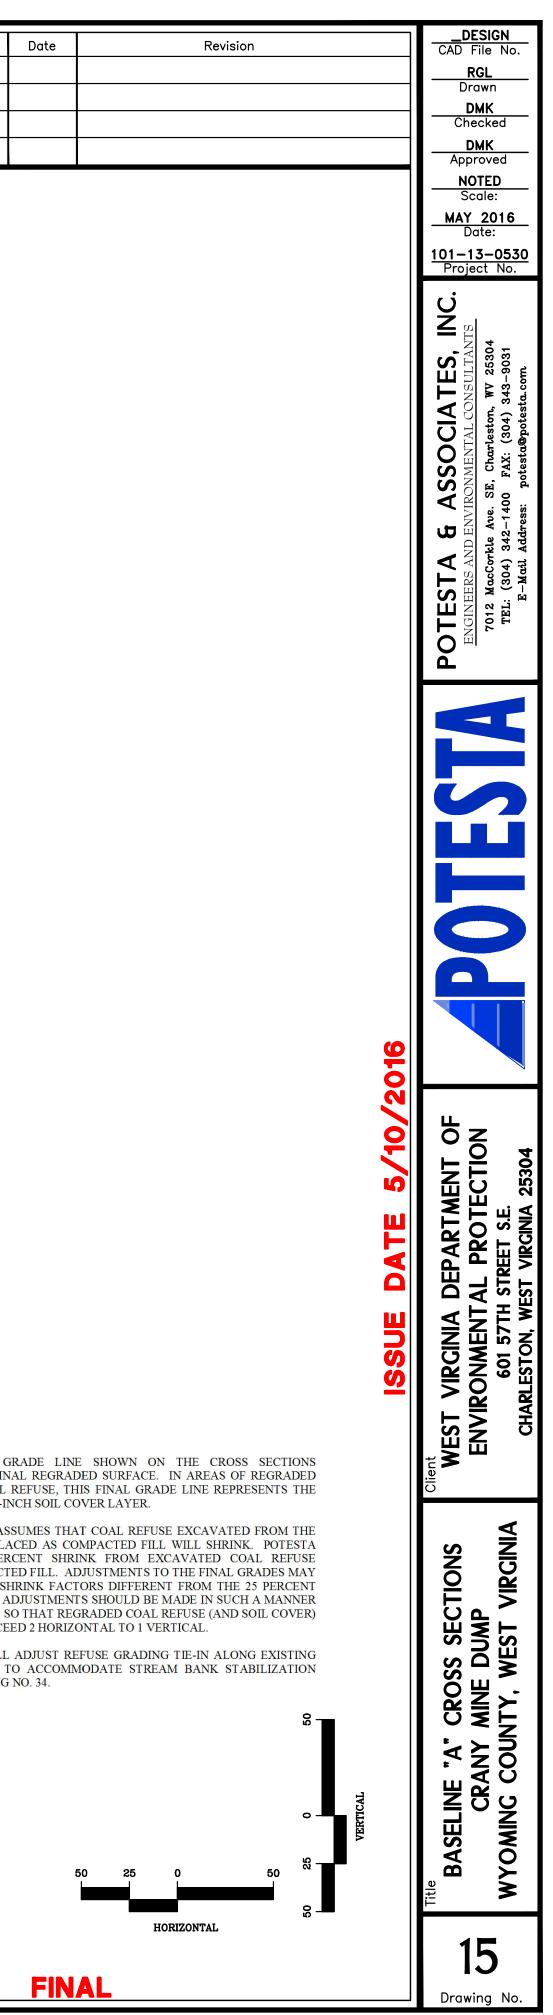

- 1. PROPOSED FINAL GRADE LINE SHOWN ON THE CROSS SECTIONS REPRESENTS THE FINAL REGRADED SURFACE. IN AREAS OF REGRADED (CUT OR FILL) COAL REFUSE, THIS FINAL GRADE LINE REPRESENTS THE SURFACE OF THE 12-INCH SOIL COVER LAYER.
- 2. REGRADING PLAN ASSUMES THAT COAL REFUSE EXCAVATED FROM THE MINE DUMP AND PLACED AS COMPACTED FILL WILL SHRINK. POTESTA ASSUMED A 25 PERCENT SHRINK FROM EXCAVATED COAL REFUSE PLACED AS COMPACTED FILL. ADJUSTMENTS TO THE FINAL GRADES MAY BE REQUIRED FOR SHRINK FACTORS DIFFERENT FROM THE 25 PERCENT FACTOR ASSUMED. ADJUSTMENTS SHOULD BE MADE IN SUCH A MANNER AND AT LOCATIONS SO THAT REGRADED COAL REFUSE (AND SOIL COVER) SLOPES DO NOT EXCEED 2 HORIZONTAL TO 1 VERTICAL.
- DETAIL ON DRAWING NO. 34.
- 3. CONTRACTOR SHALL ADJUST REFUSE GRADING TIE-IN ALONG EXISTING STREAM CHANNEL TO ACCOMMODATE STREAM BANK STABILIZATION

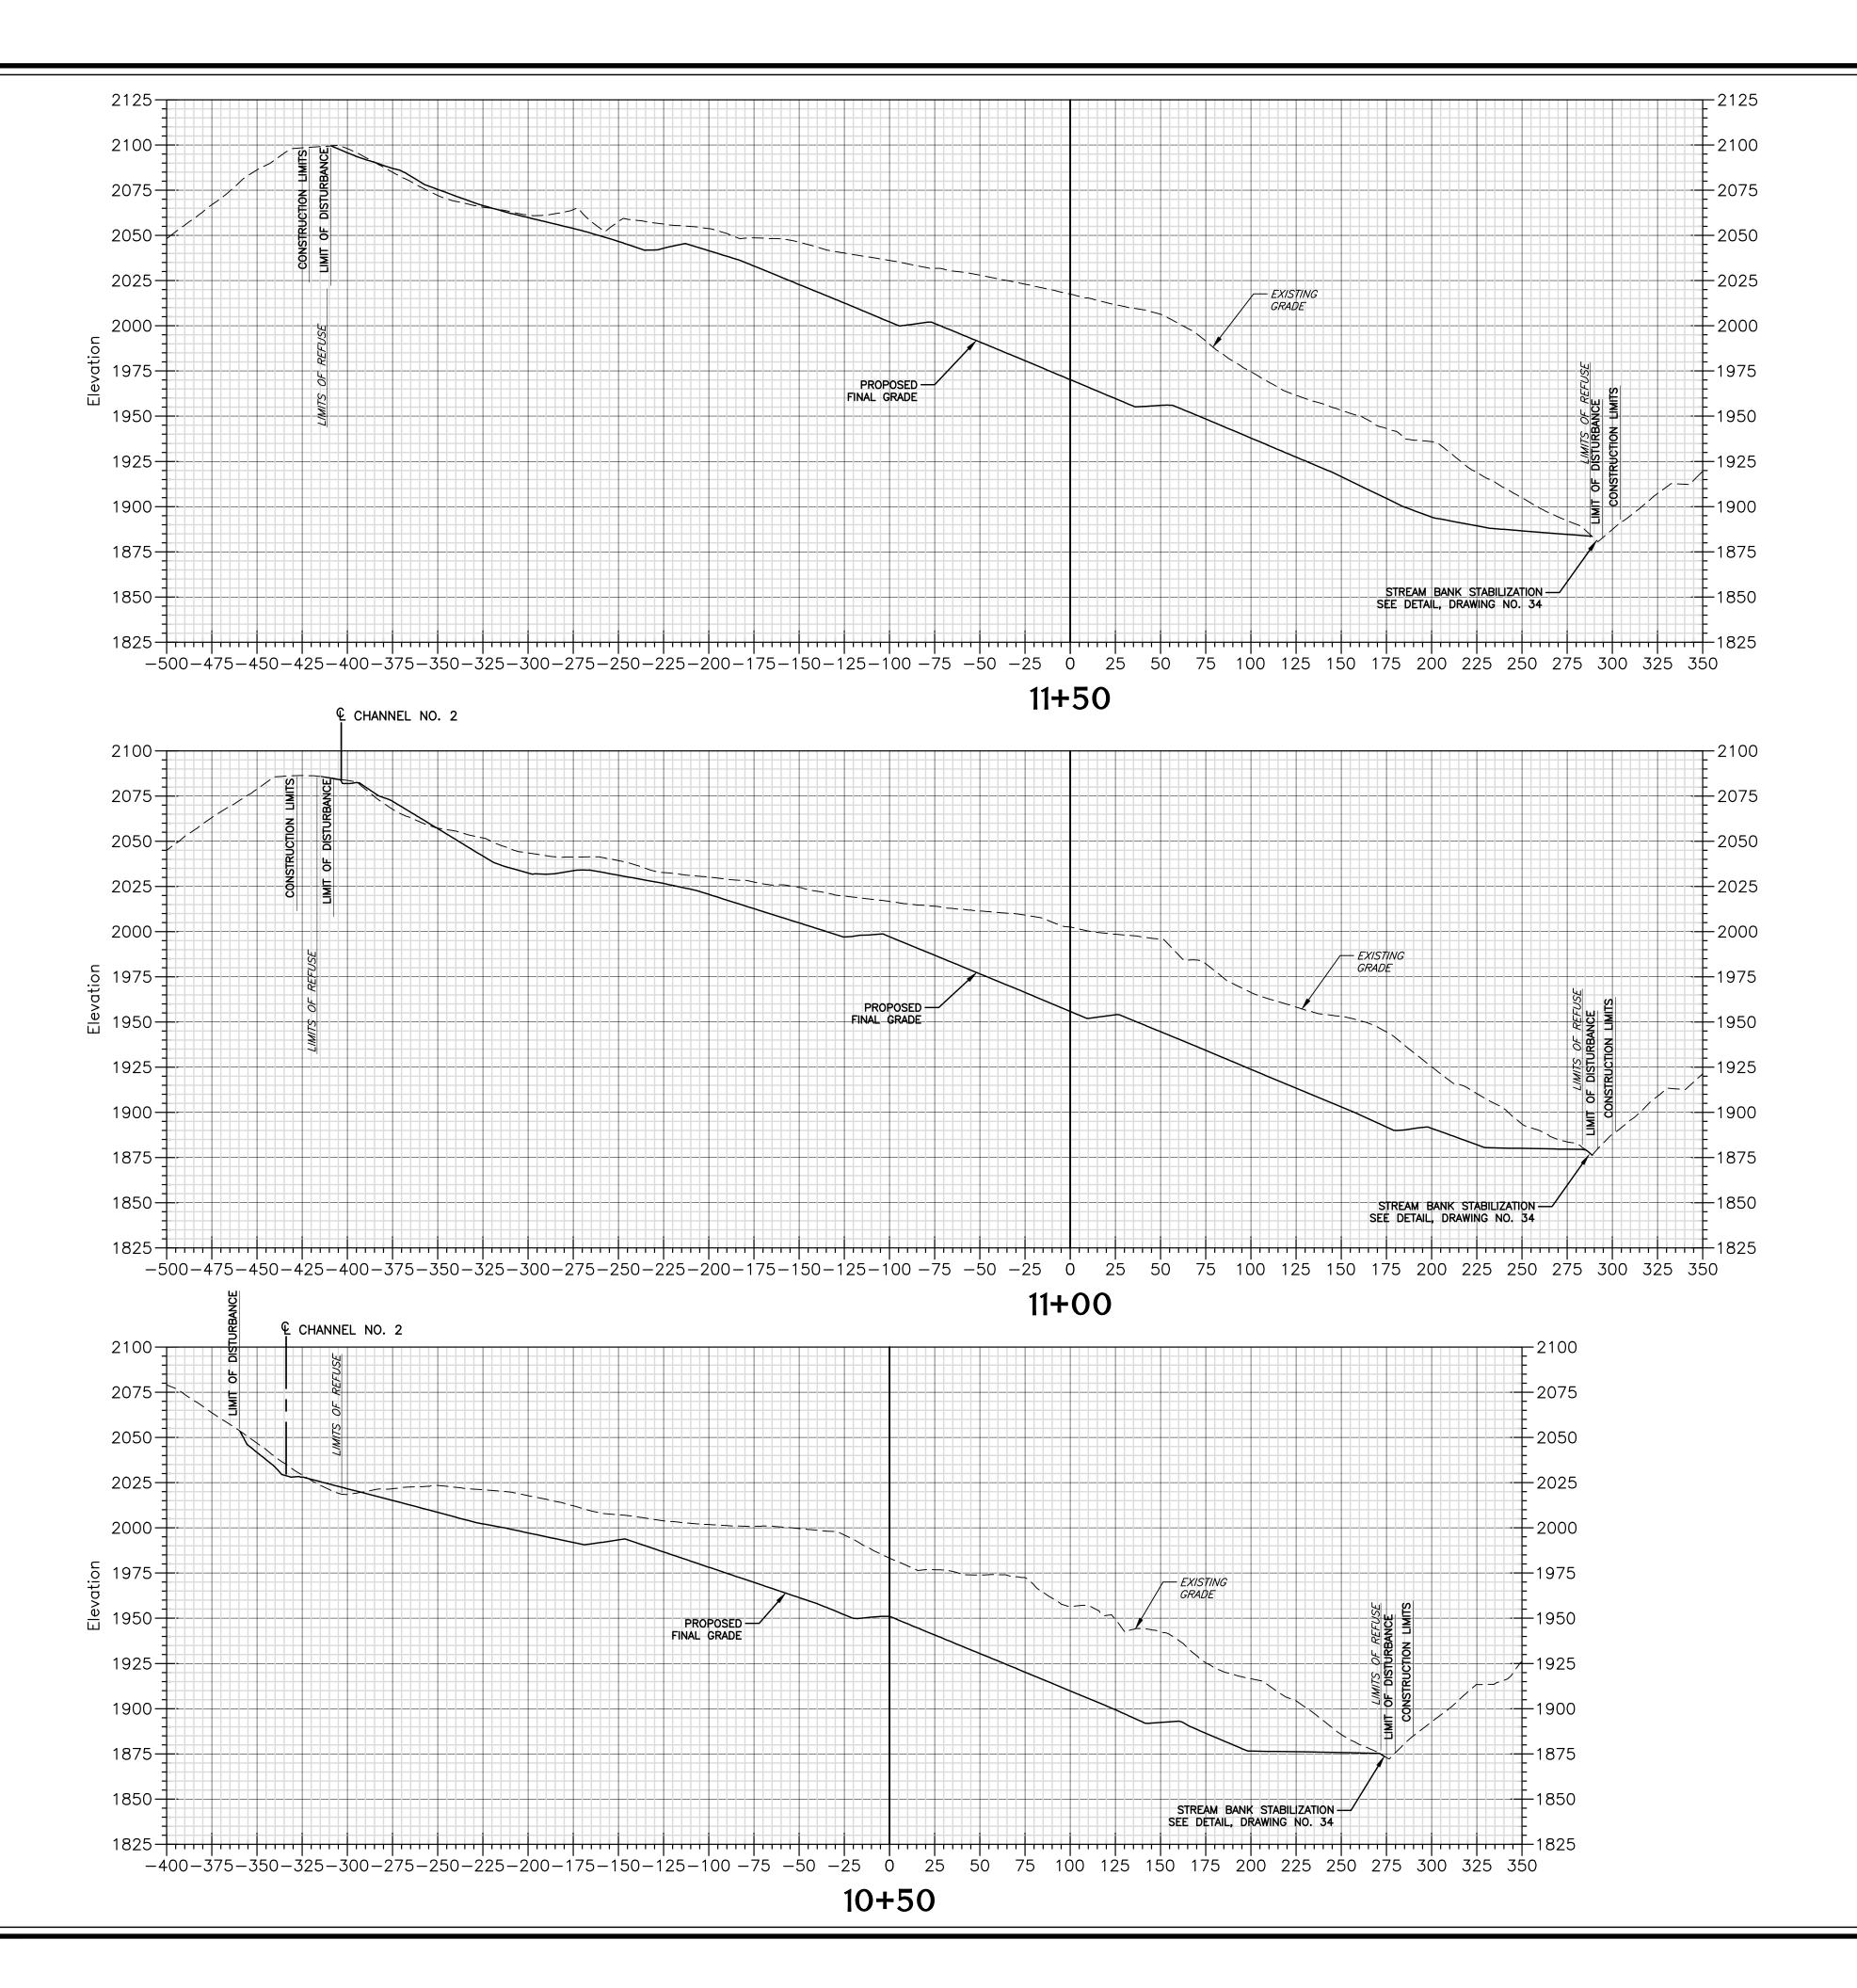



Date	Revision		DESIGN CAD File No.
			CAD File No. RGL Drawn
			Drawn DMK Checked
			DMK Approved
			NOTED Scale:
			MAY 2016 Date:
			101-13-0530 Project No.
			<sup>4</sup> IS
			<b>E ASSOCIATES, INC.</b> ENVIRONMENTAL CONSULTANTS Ave. SE, Charleston, WV 25304 2-1400 FAX: (304) 343-9031 dress: potesta@potesta.com
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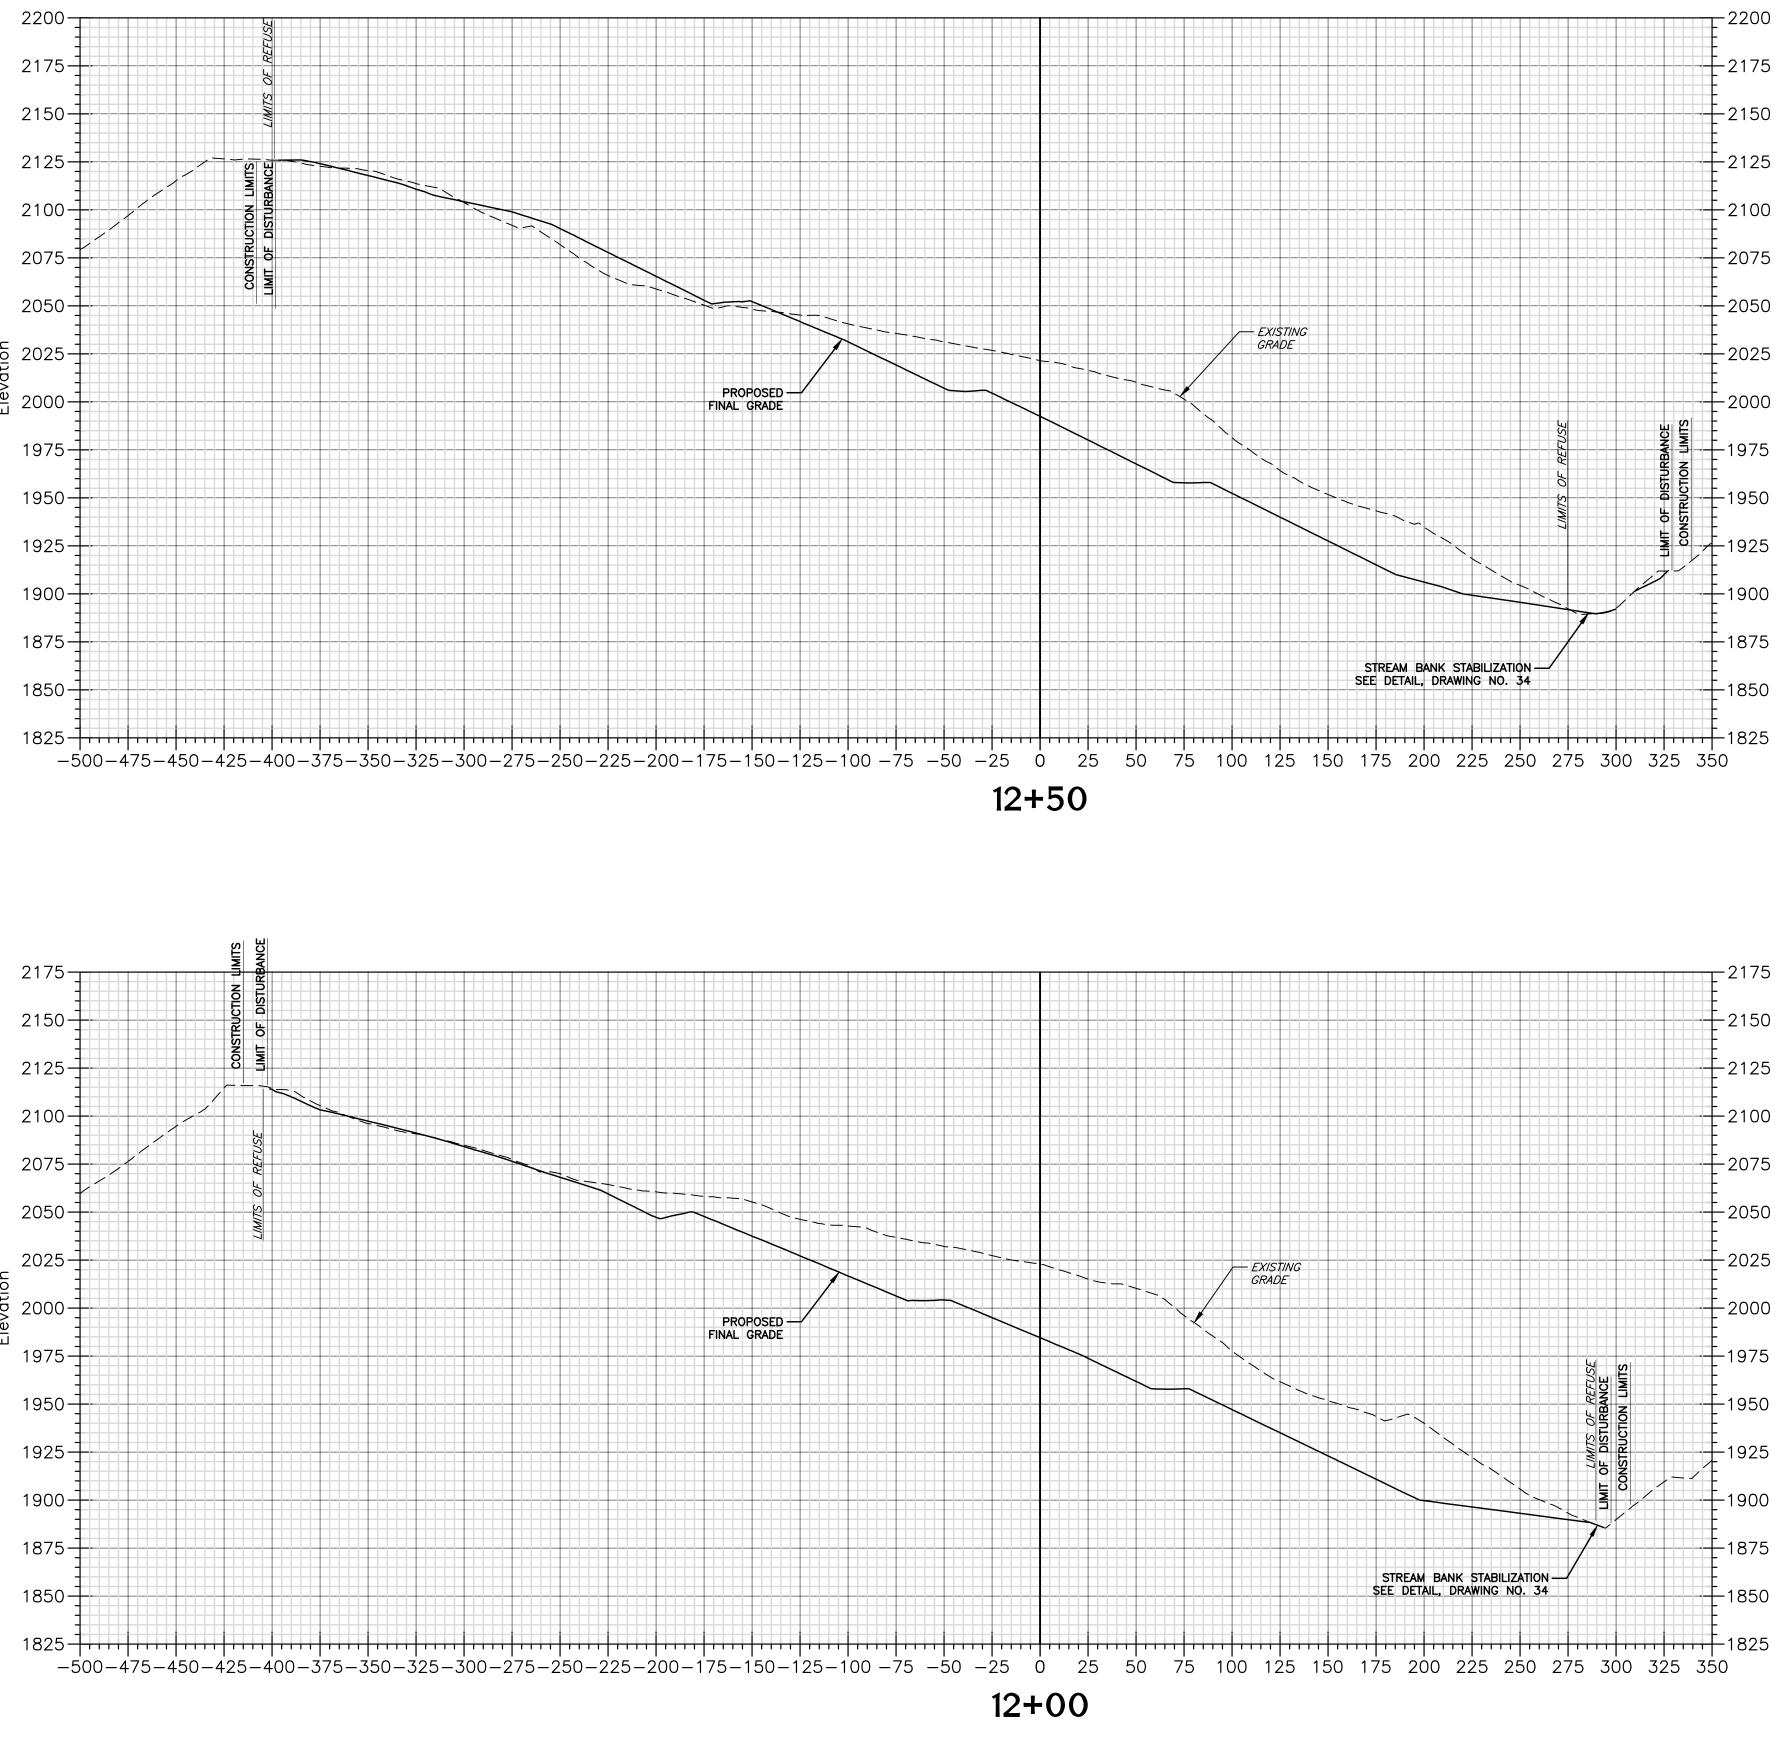
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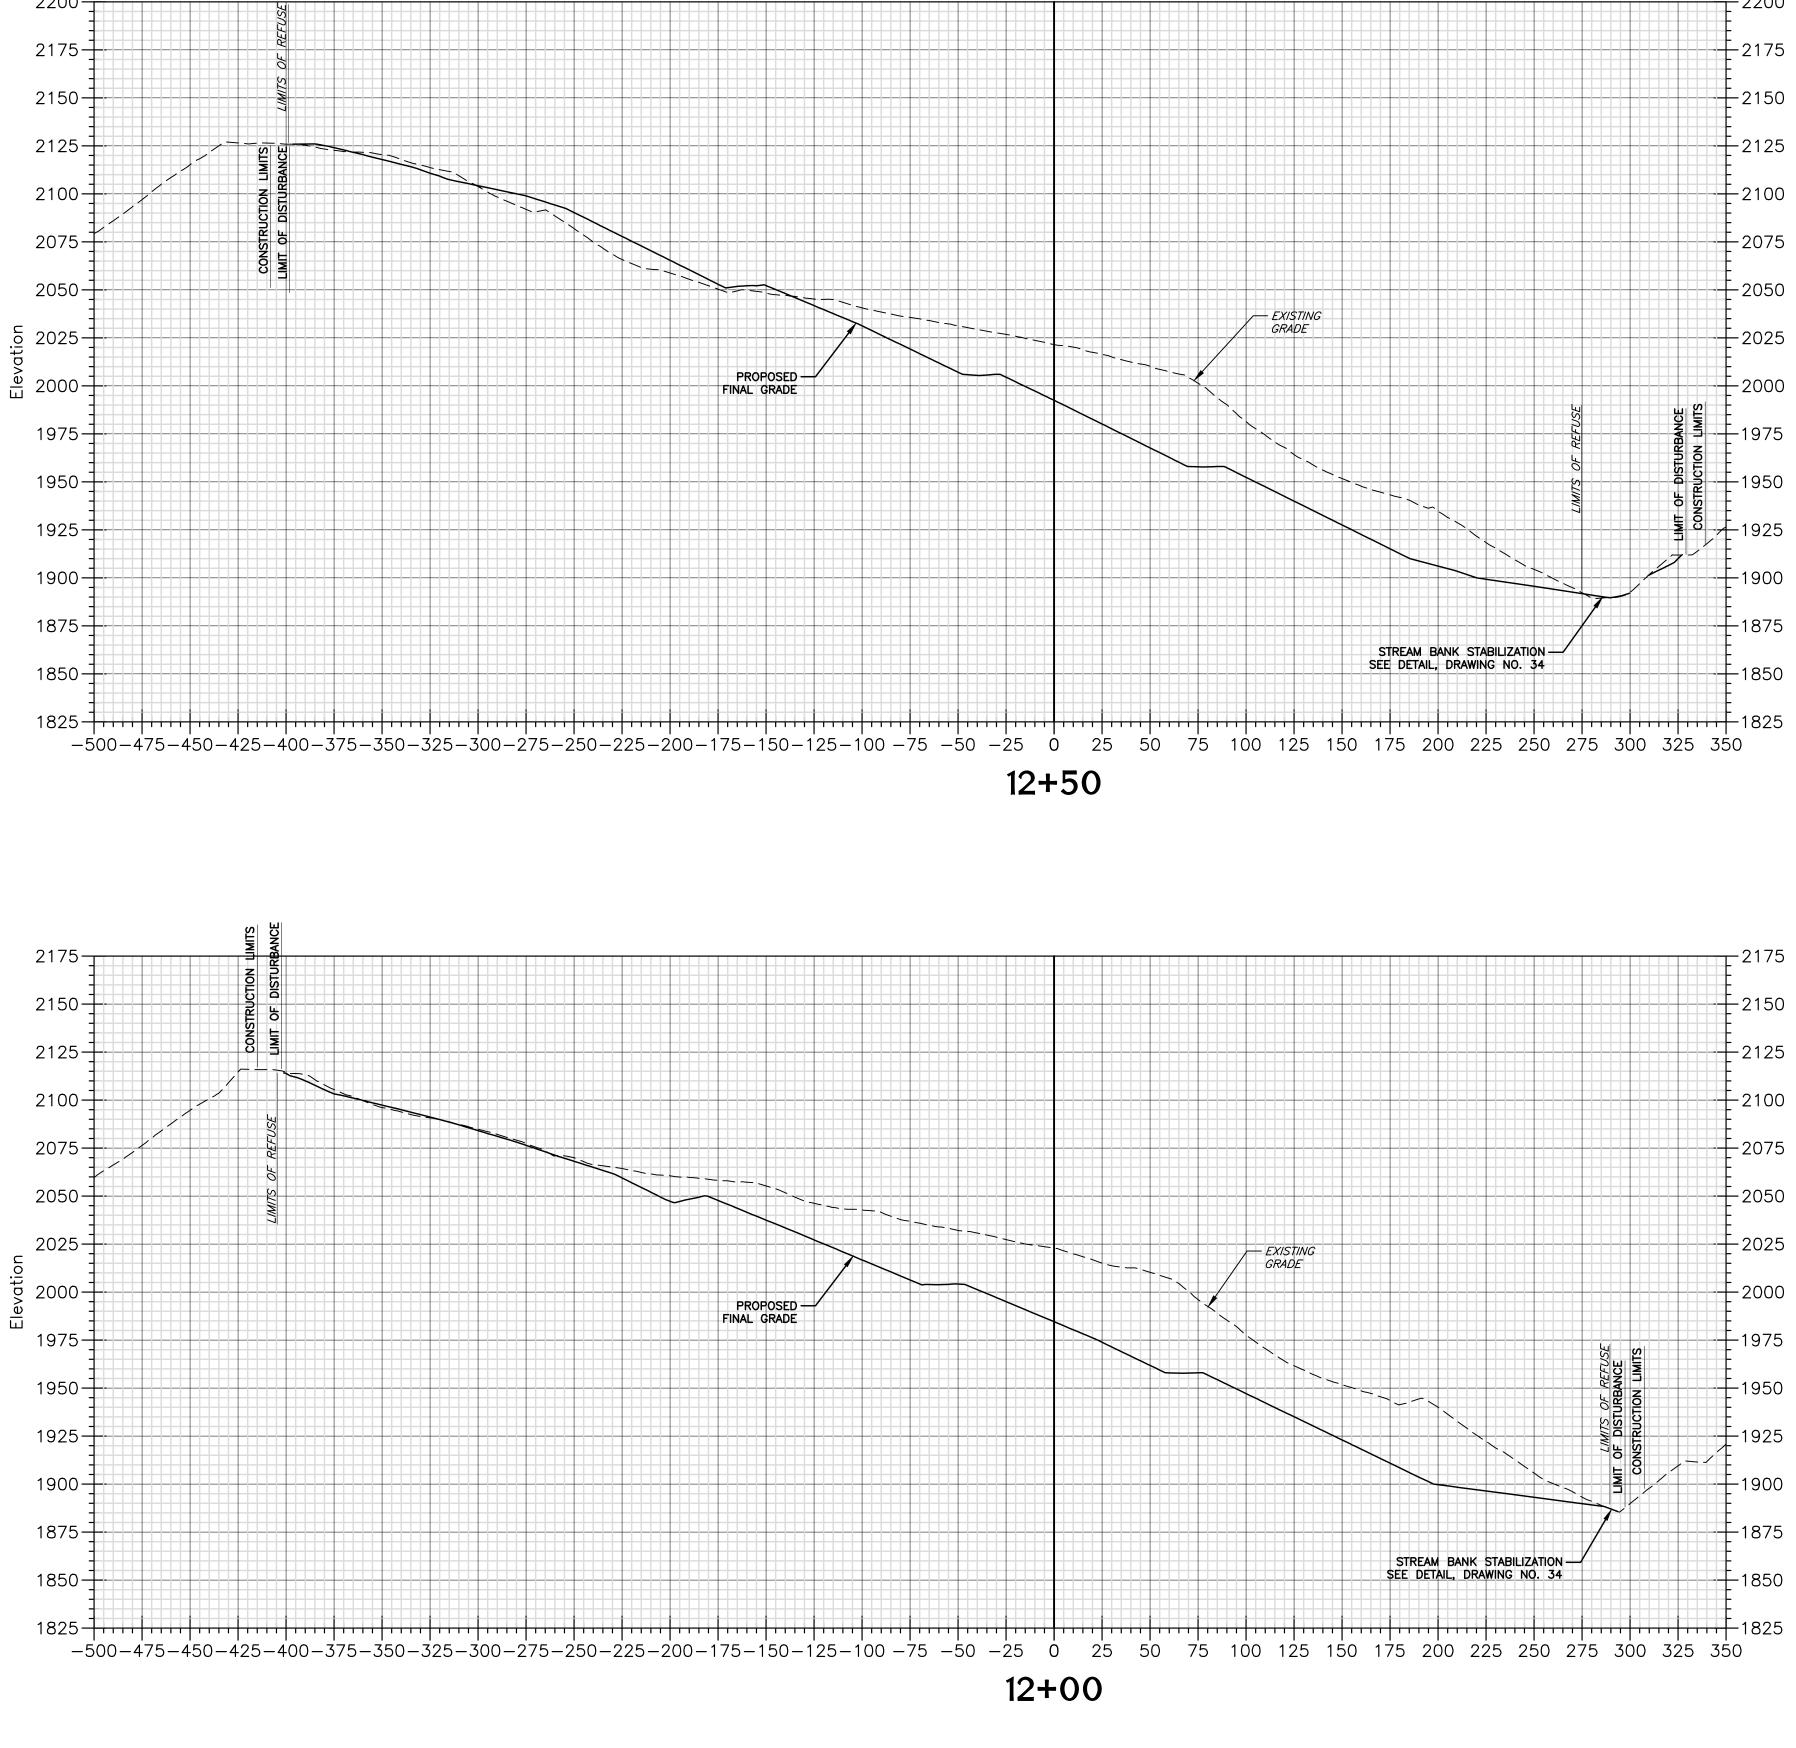
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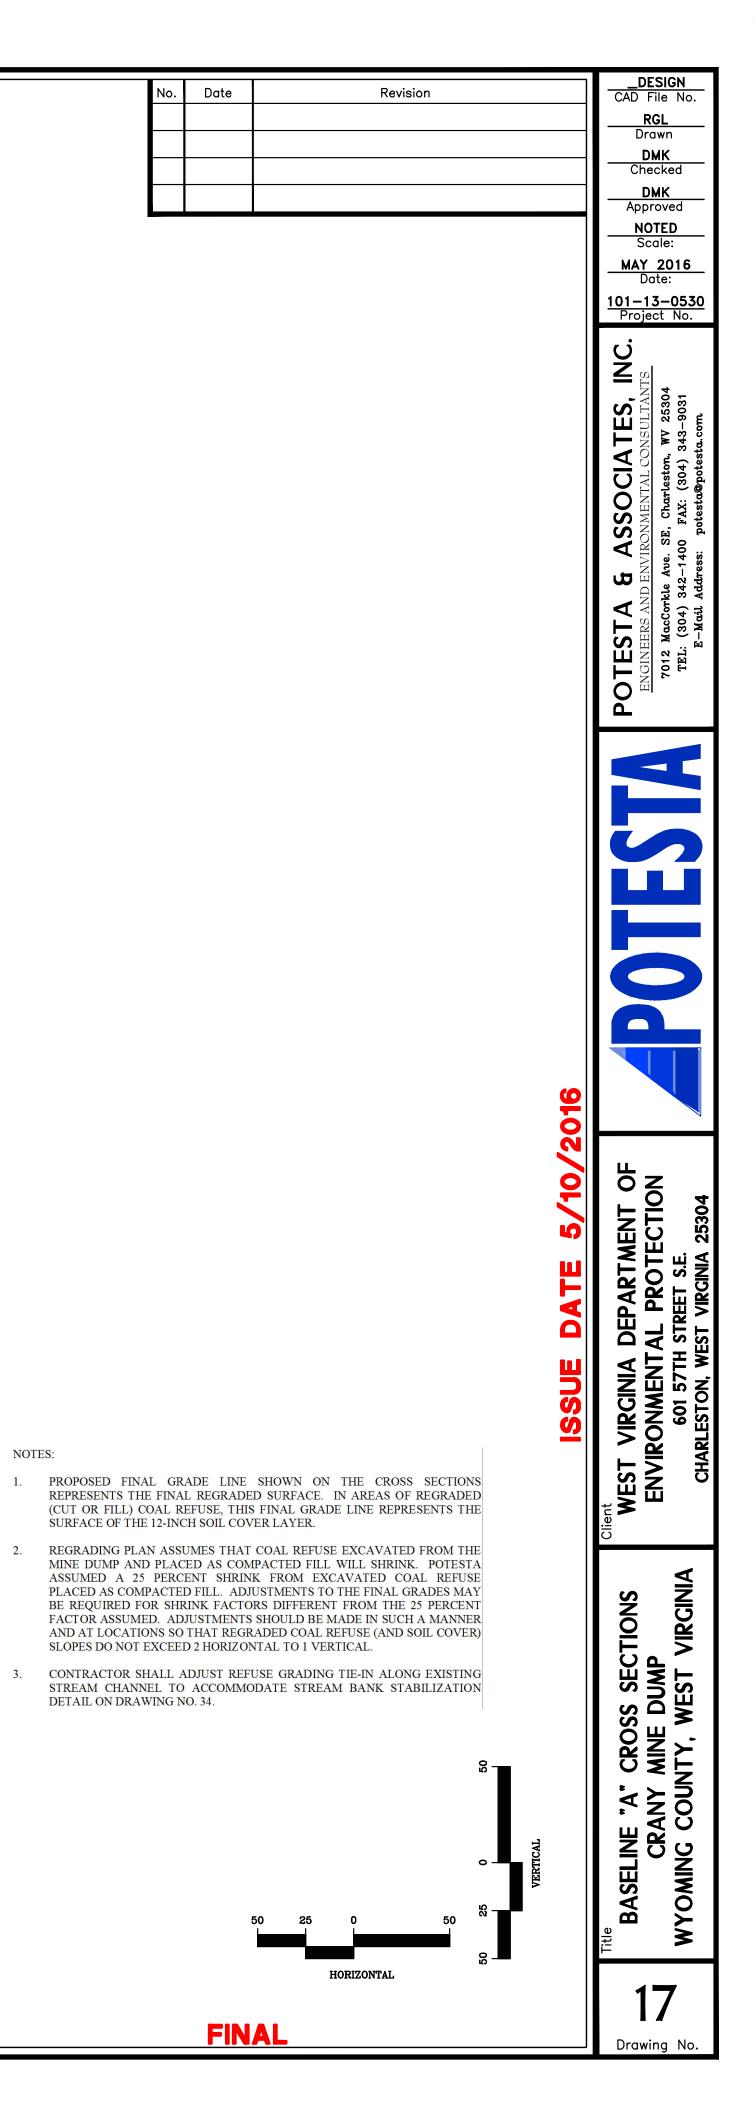
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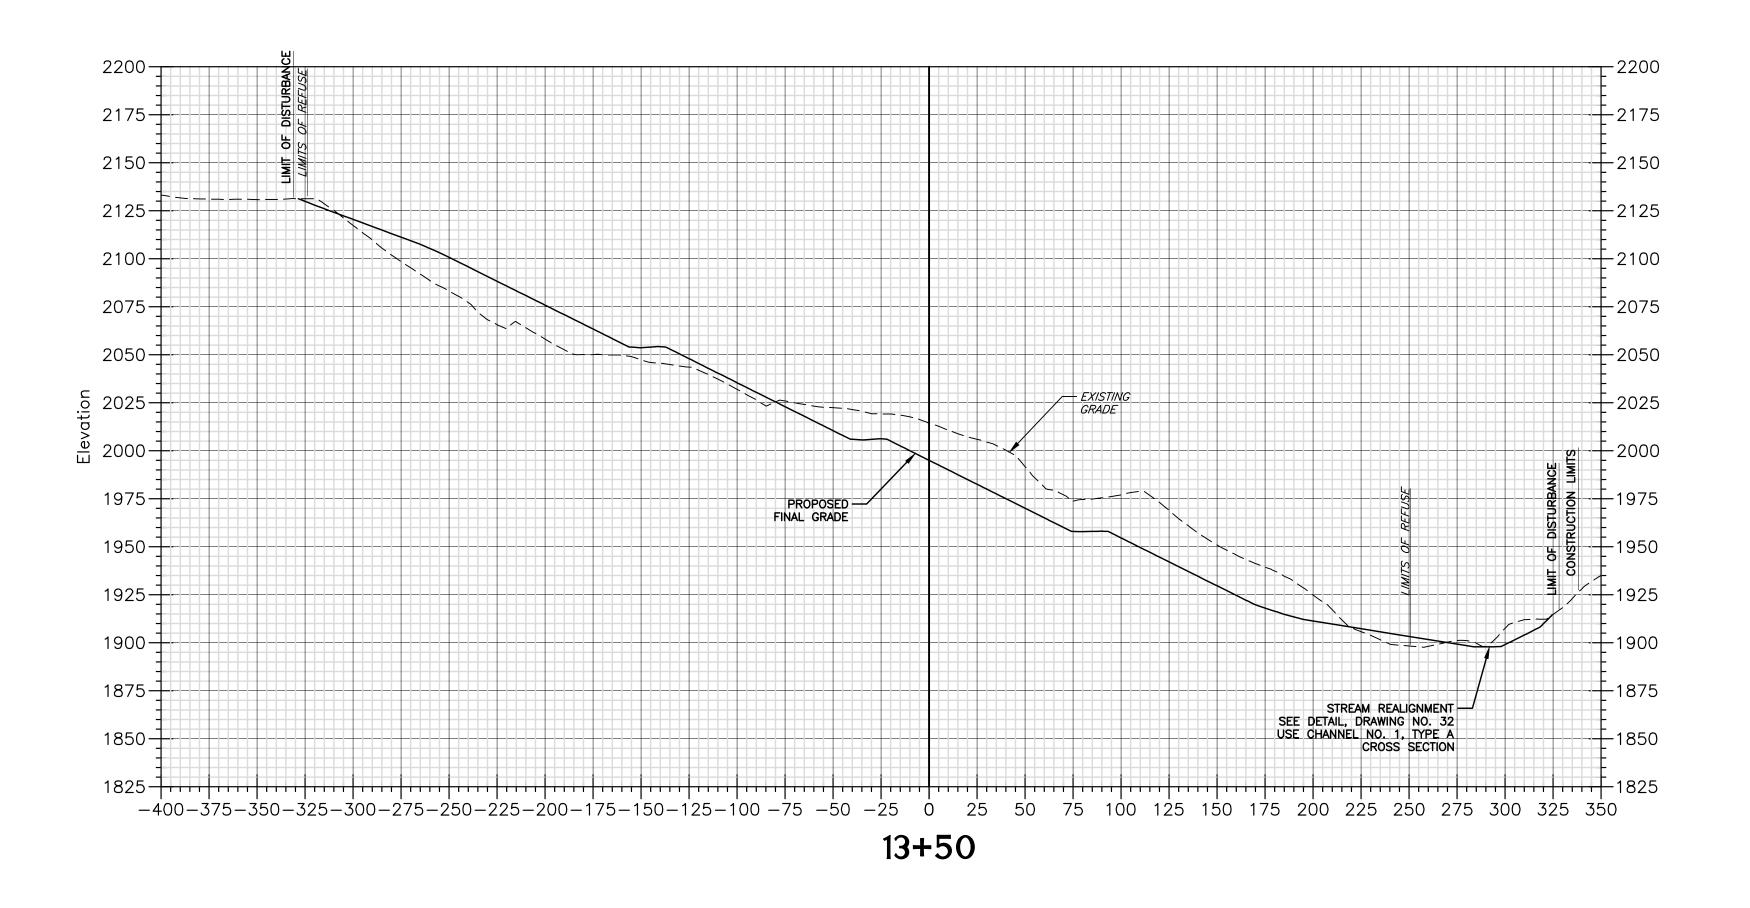
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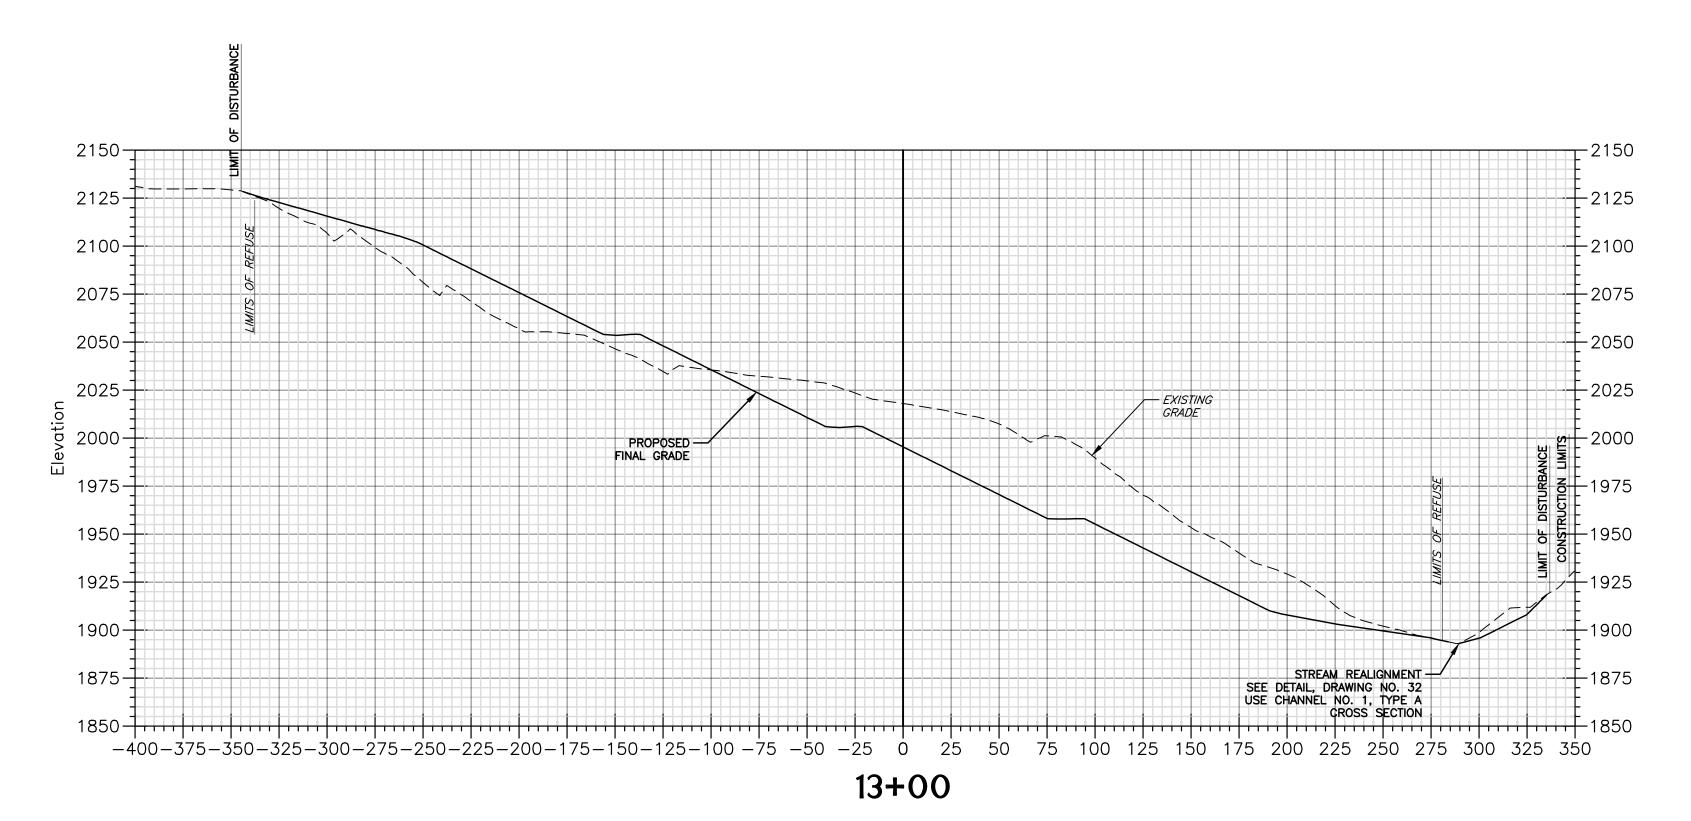
- 1. PROPOSED FINAL O REPRESENTS THE FIN (CUT OR FILL) COAL SURFACE OF THE 12-II
- 2. REGRADING PLAN AS MINE DUMP AND PLA ASSUMED A 25 PER PLACED AS COMPACT BE REQUIRED FOR S FACTOR ASSUMED. AND AT LOCATIONS S SLOPES DO NOT EXCE
- 3. CONTRACTOR SHALL STREAM CHANNEL T DETAIL ON DRAWING














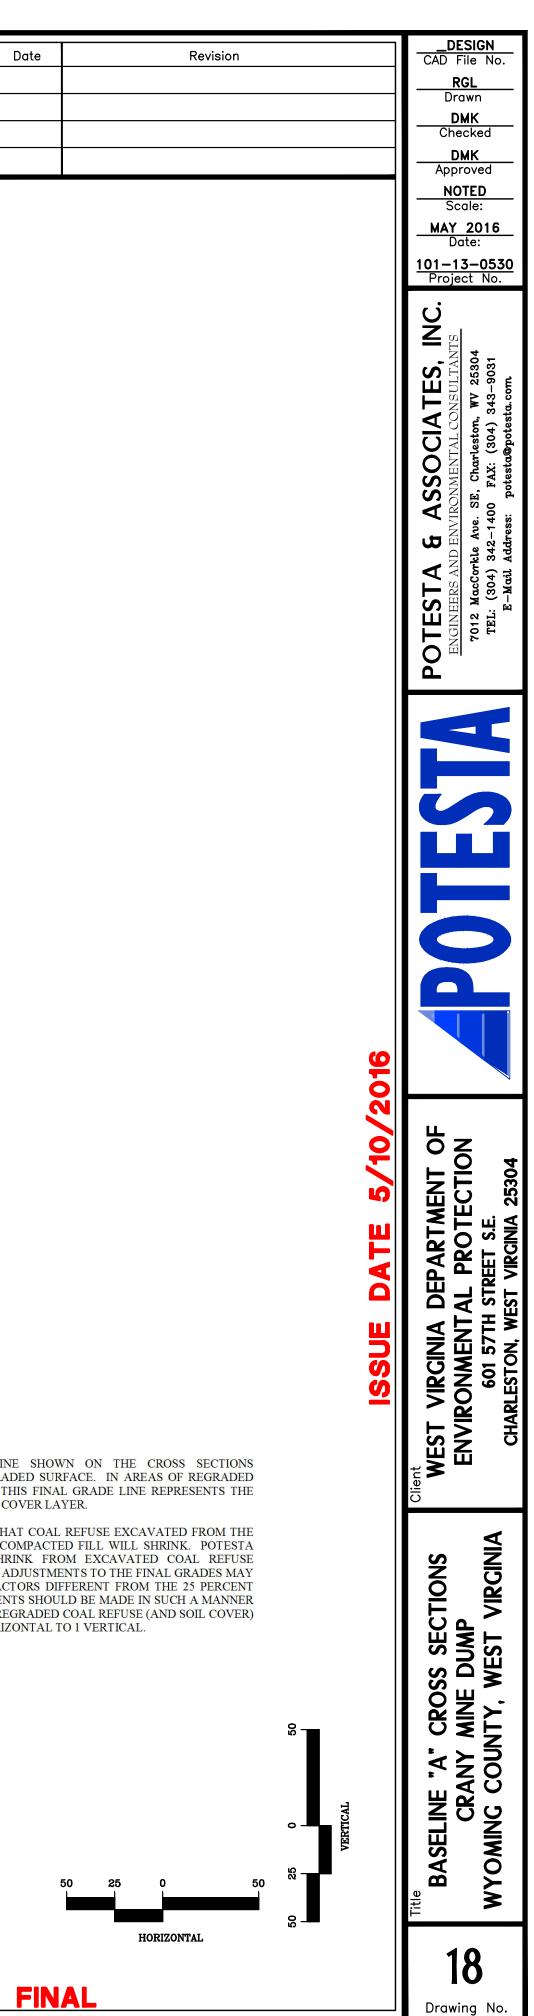


- 1. PROPOSED FINAL GRADE LINE SHOWN ON THE CROSS SECTIONS REPRESENTS THE FINAL REGRADED SURFACE. IN AREAS OF REGRADED (CUT OR FILL) COAL REFUSE, THIS FINAL GRADE LINE REPRESENTS THE SURFACE OF THE 12-INCH SOIL COVER LAYER.
- REGRADING PLAN ASSUMES THAT COAL REFUSE EXCAVATED FROM THE 2 MINE DUMP AND PLACED AS COMPACTED FILL WILL SHRINK. POTESTA ASSUMED A 25 PERCENT SHRINK FROM EXCAVATED COAL REFUSE PLACED AS COMPACTED FILL. ADJUSTMENTS TO THE FINAL GRADES MAY BE REQUIRED FOR SHRINK FACTORS DIFFERENT FROM THE 25 PERCENT FACTOR ASSUMED. ADJUSTMENTS SHOULD BE MADE IN SUCH A MANNER AND AT LOCATIONS SO THAT REGRADED COAL REFUSE (AND SOIL COVER) SLOPES DO NOT EXCEED 2 HORIZONTAL TO 1 VERTICAL.

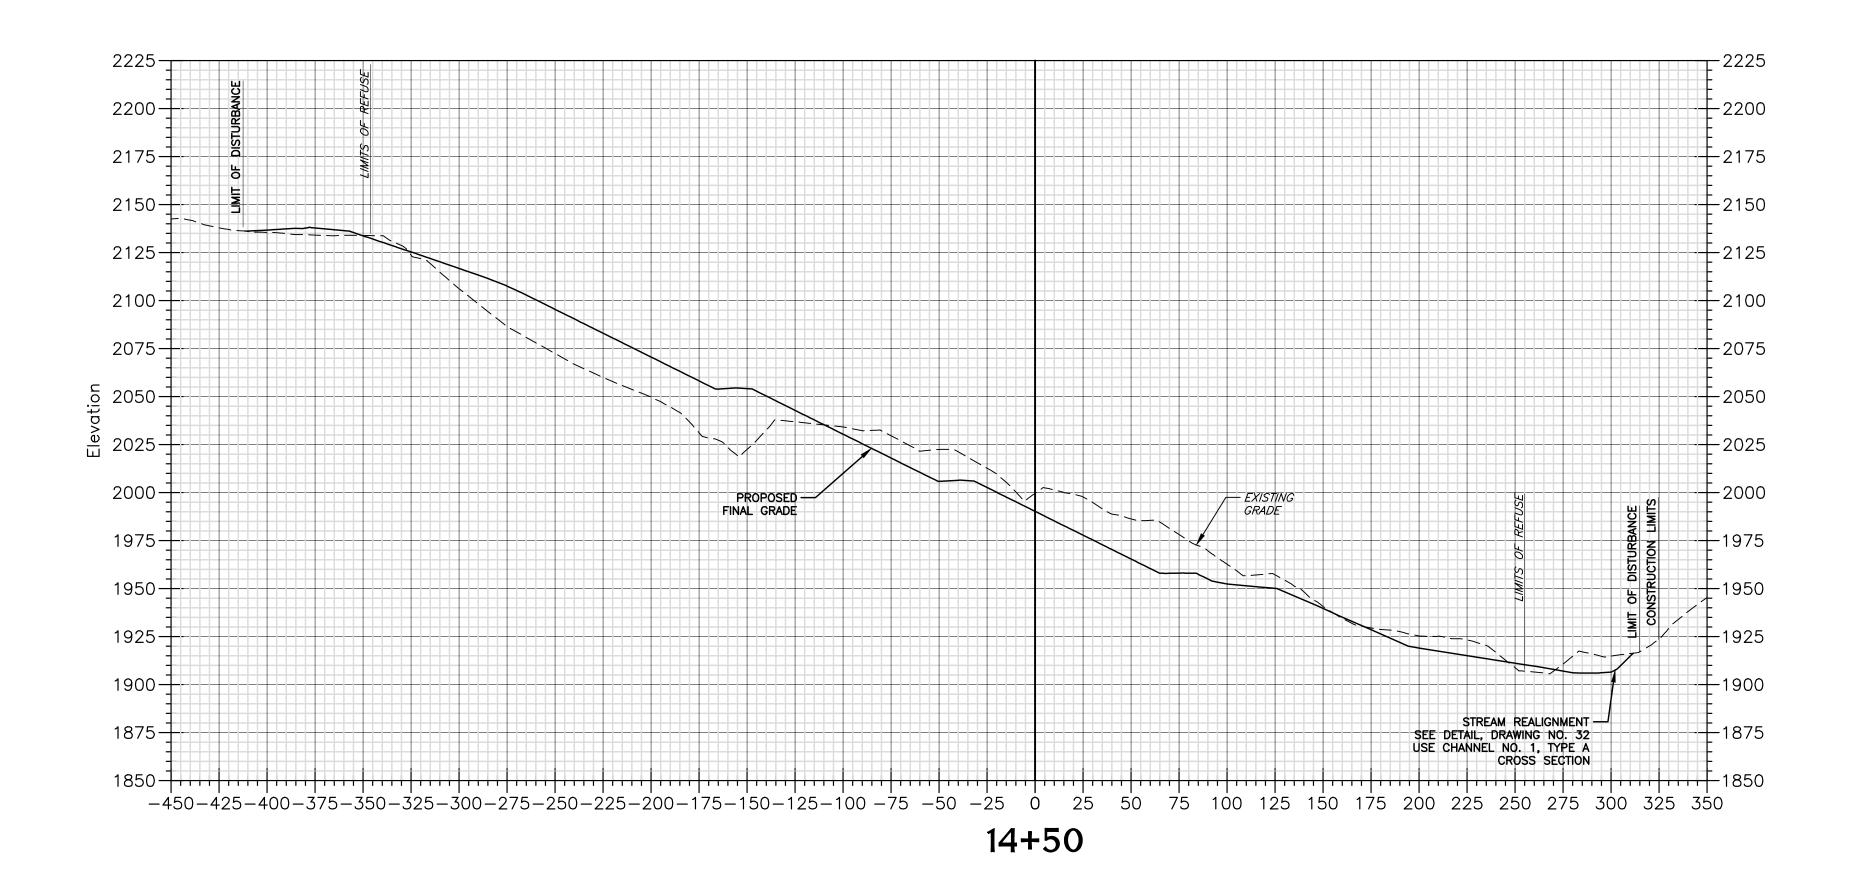

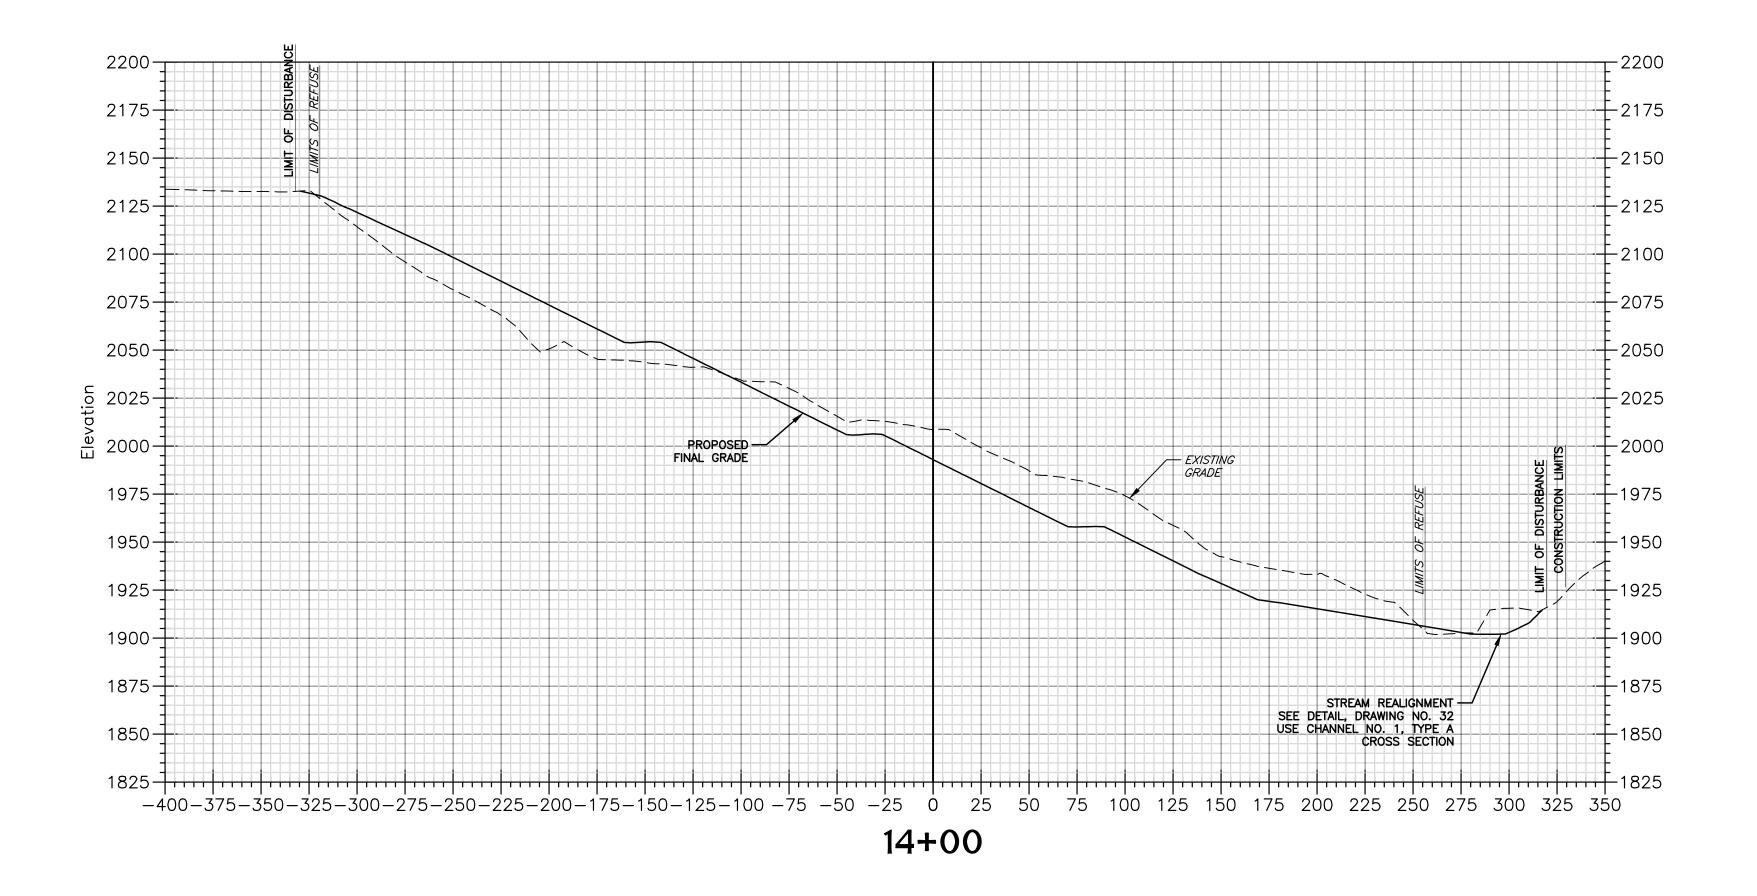






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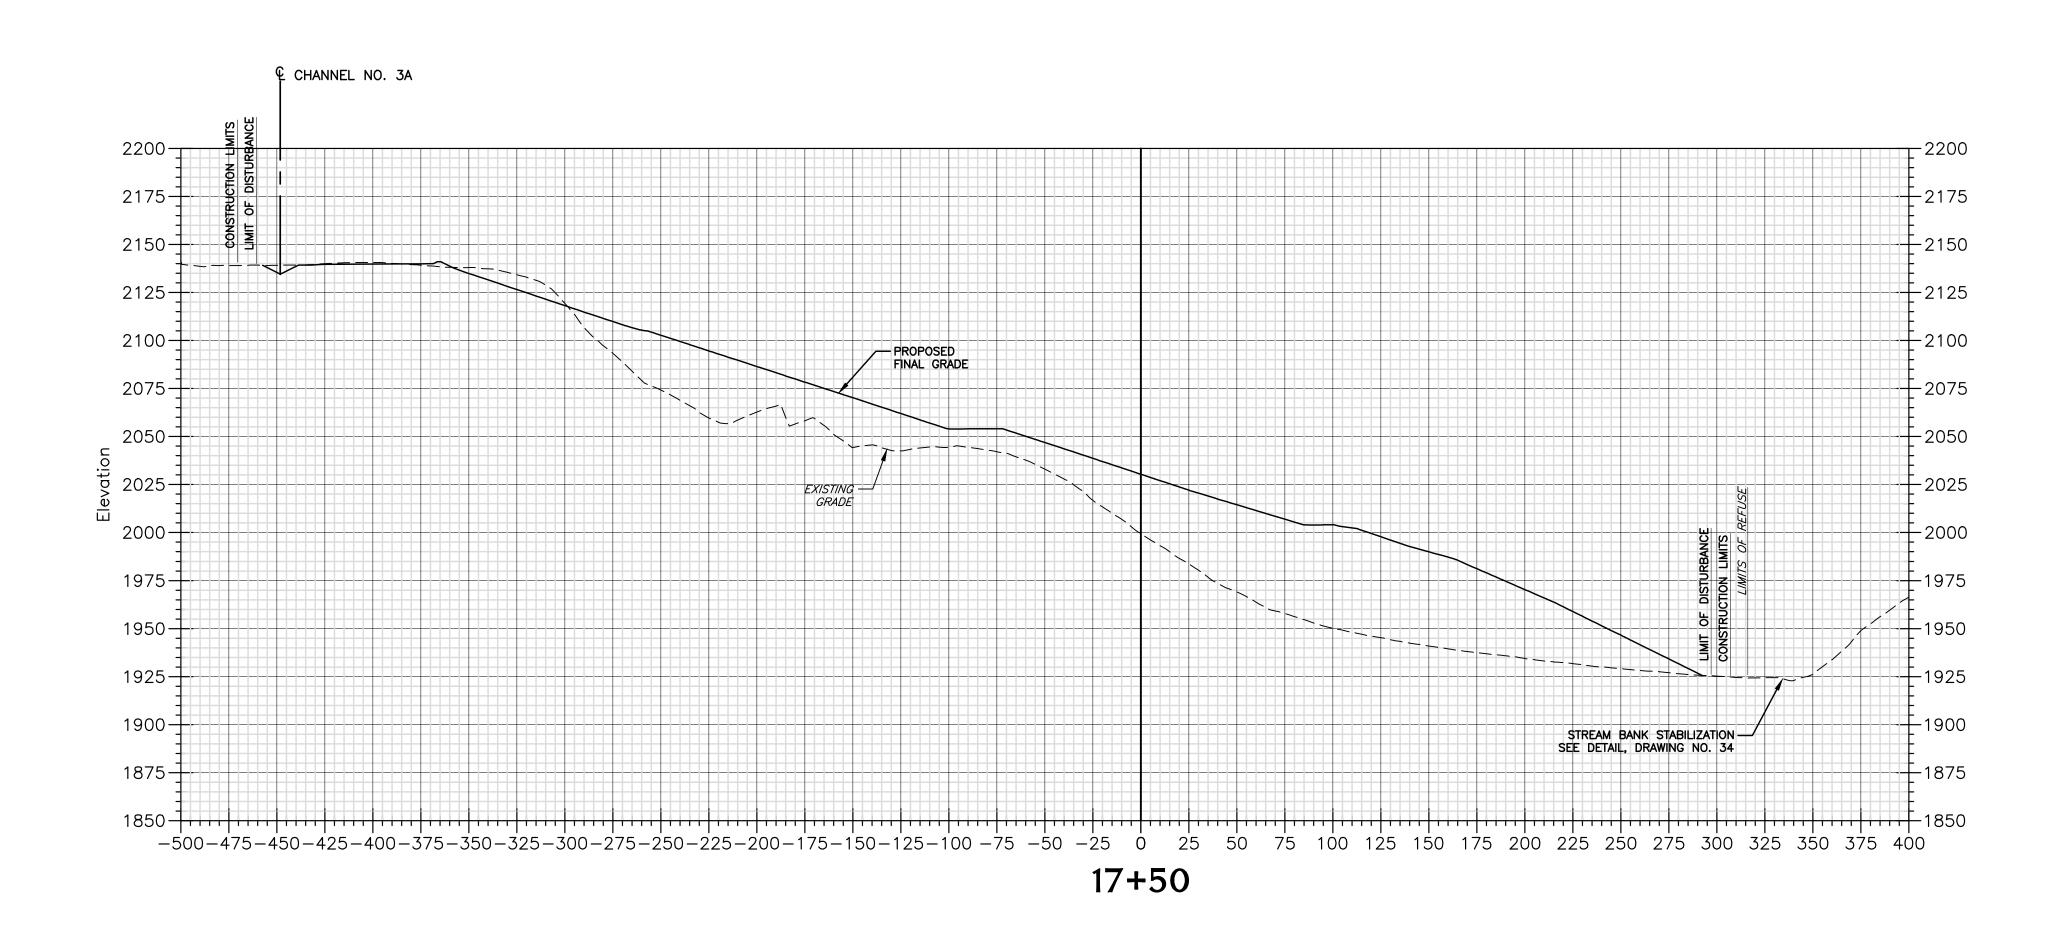


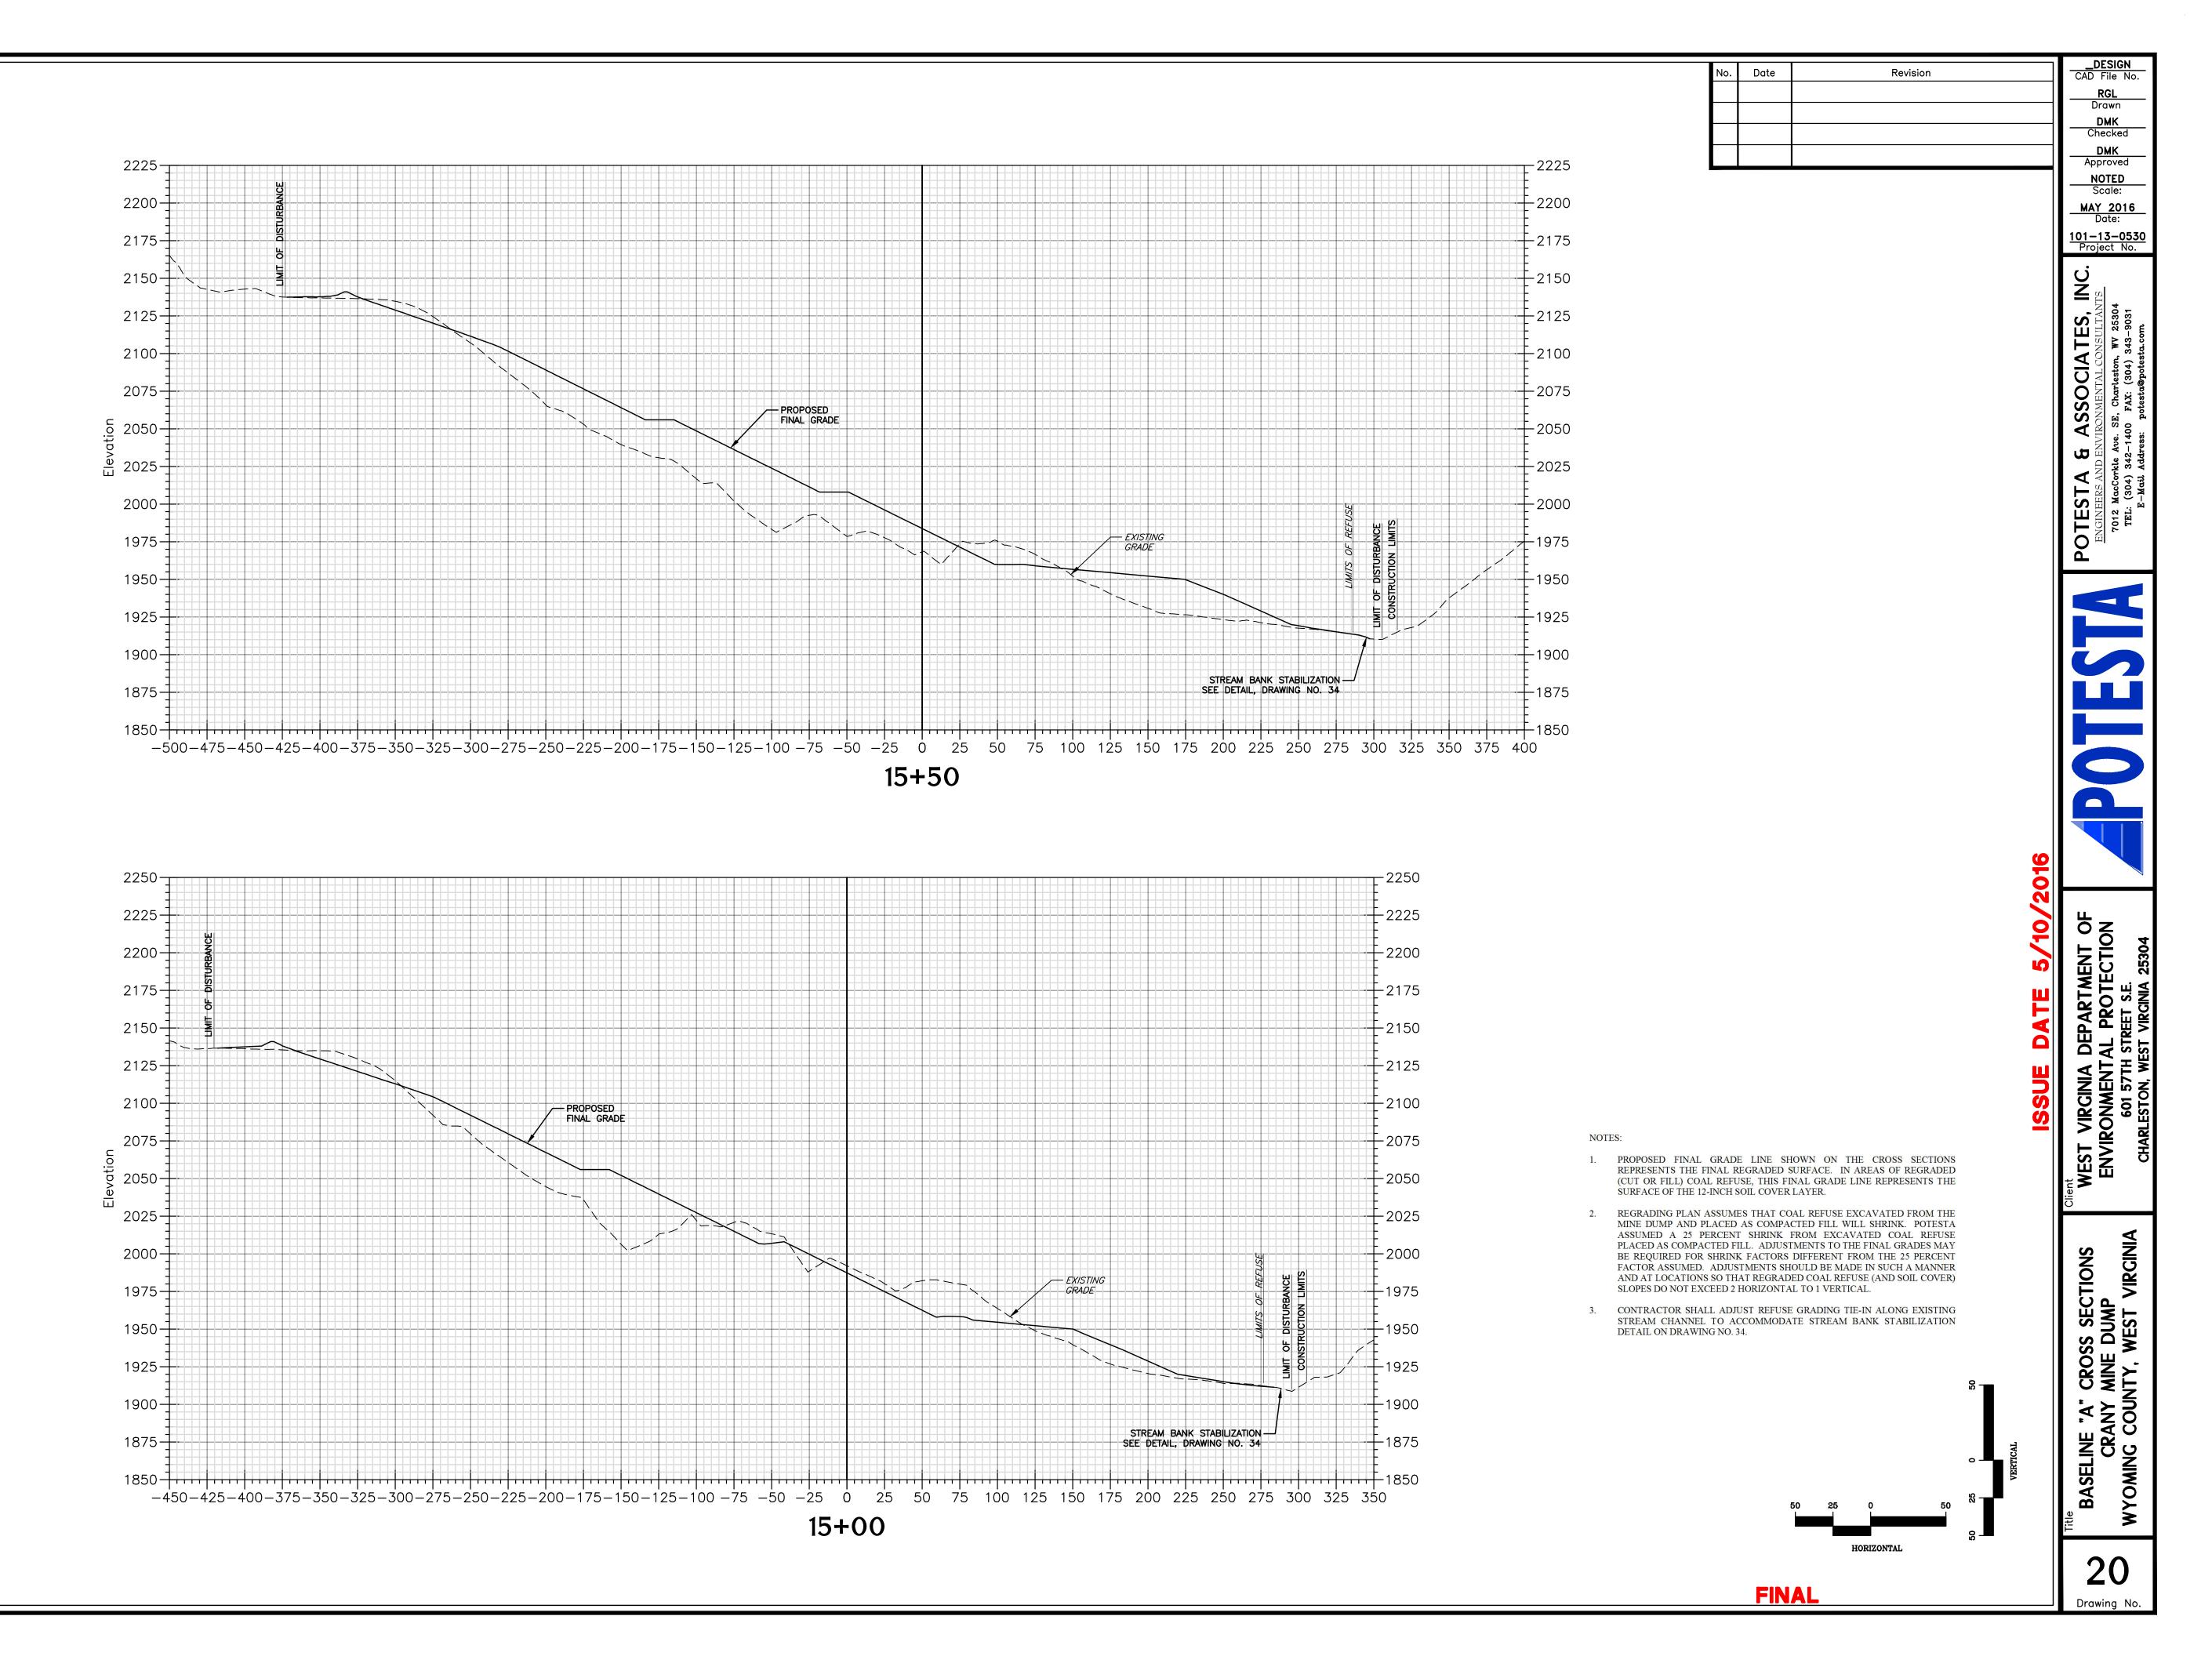


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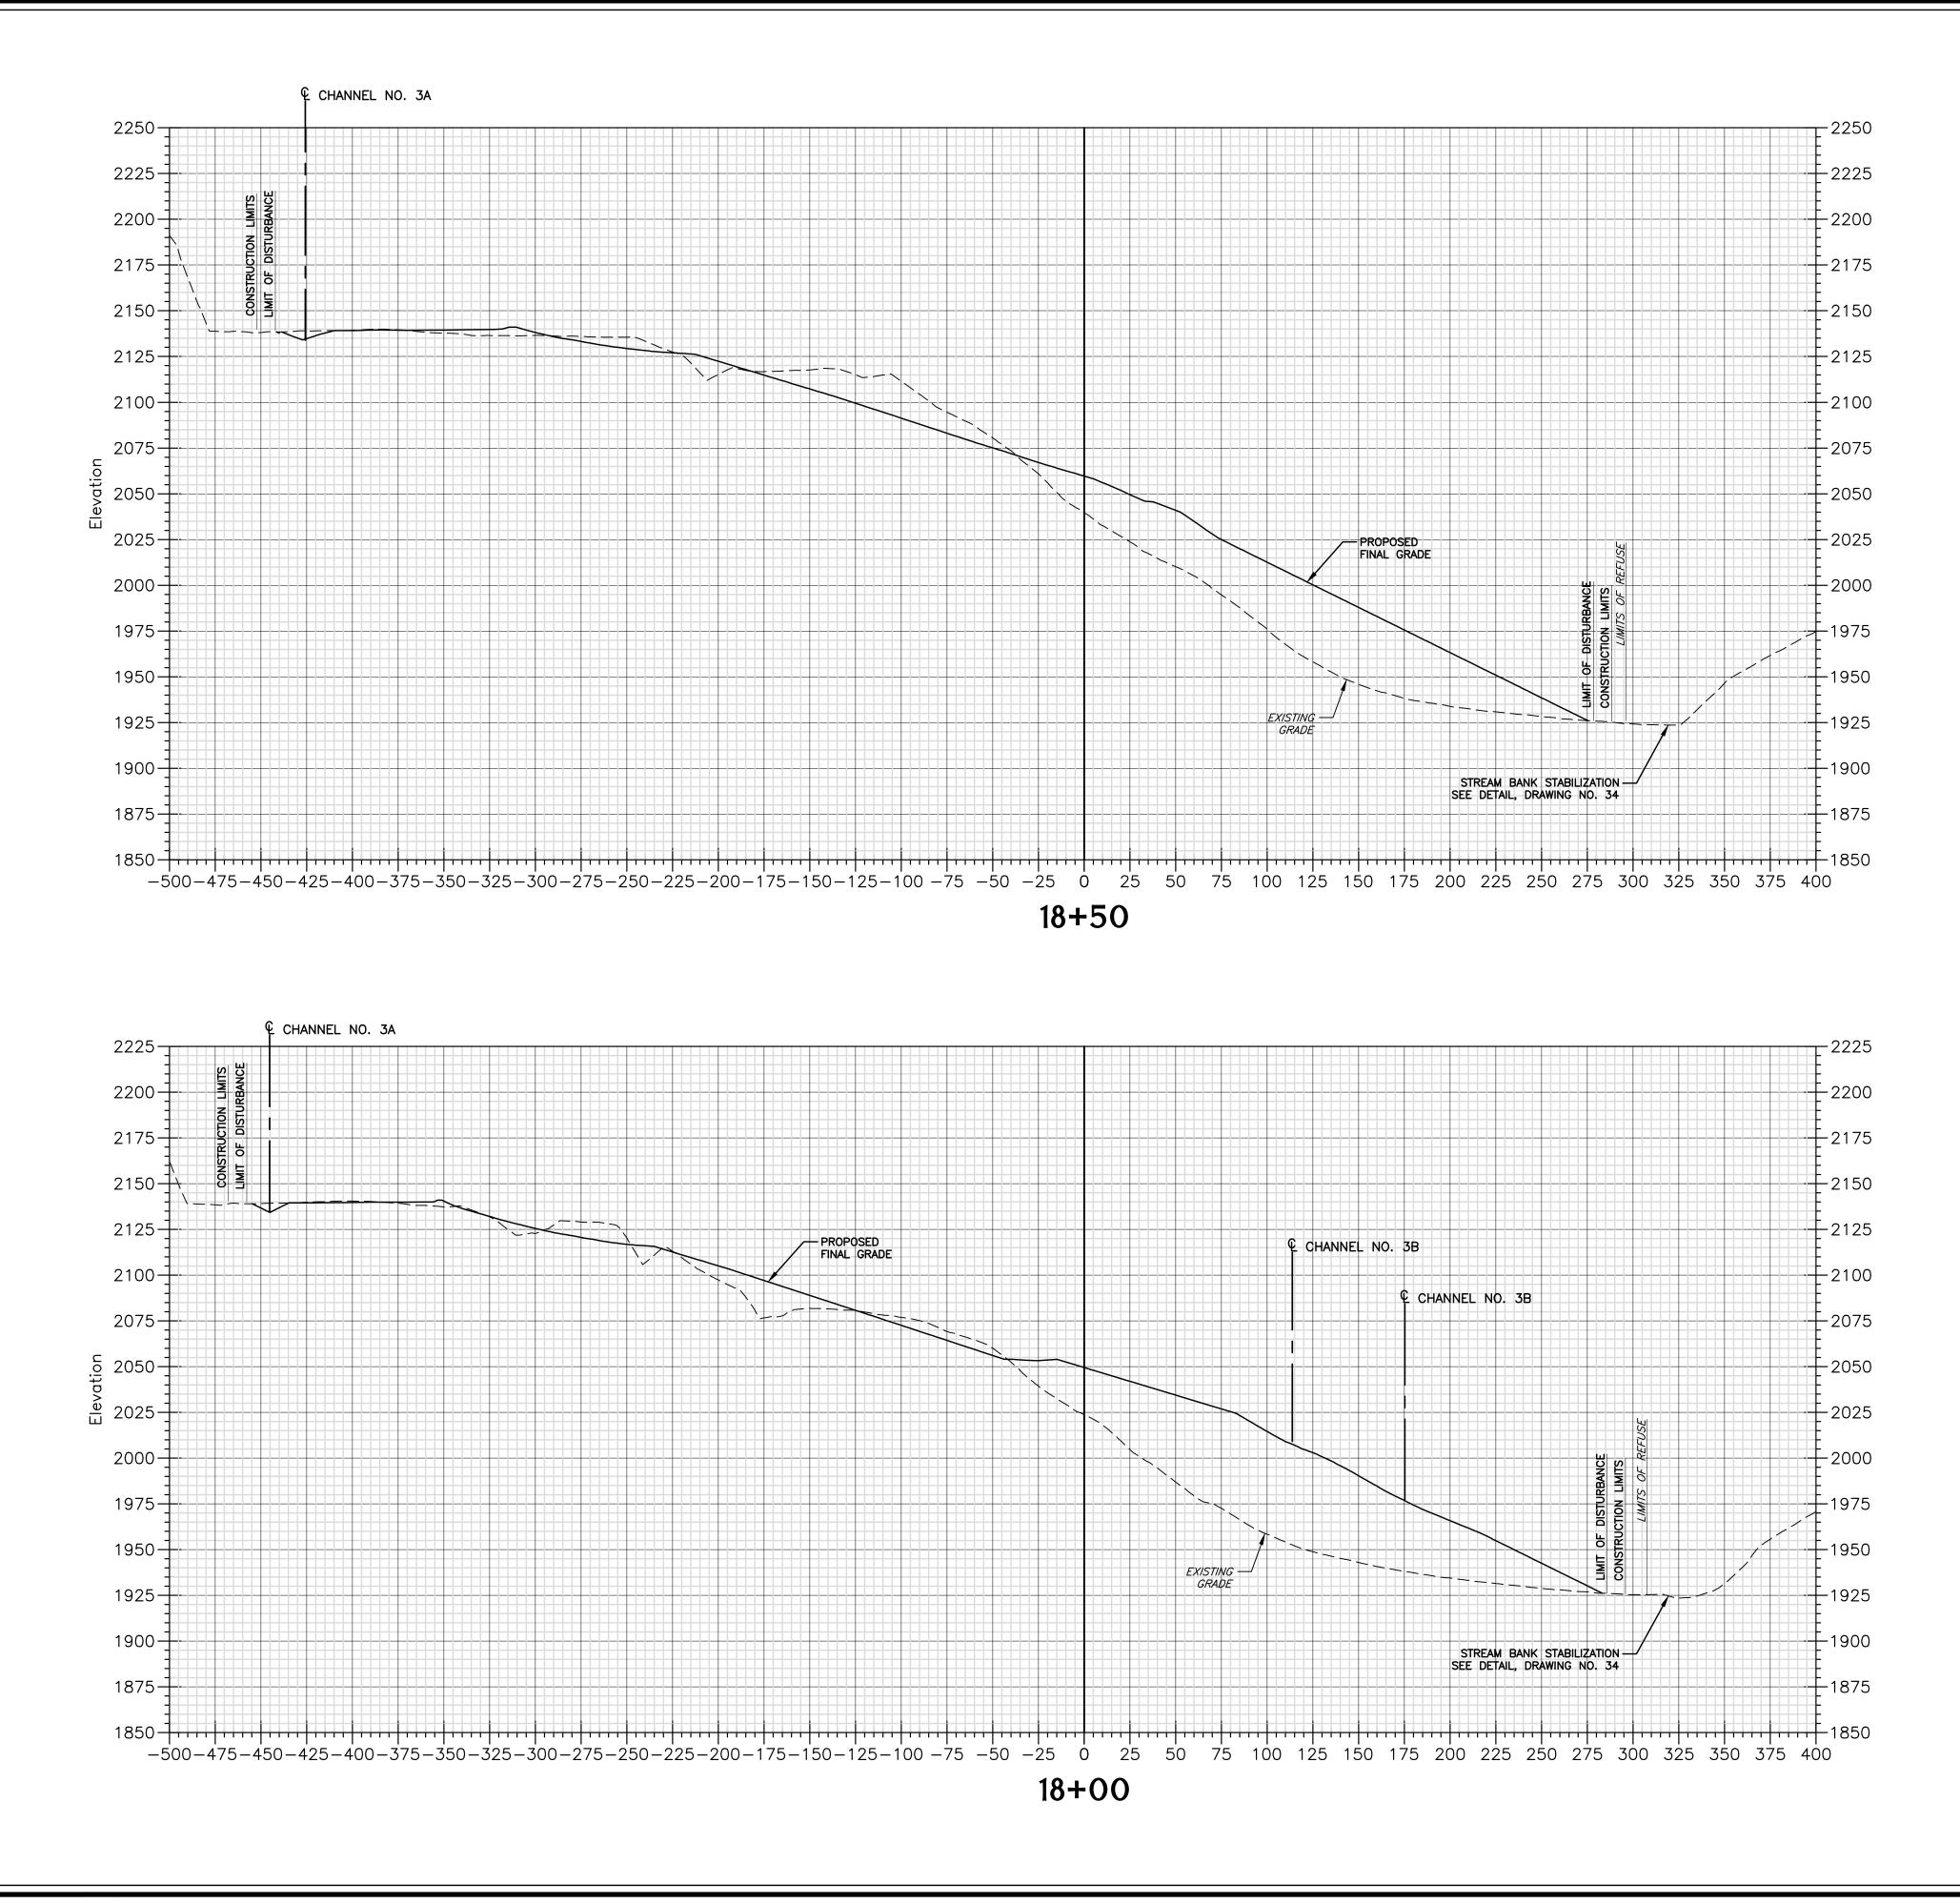
3. CONTRACTOR SHALL ADJUST REFUSE GRADING TIE-IN ALONG EXISTING STREAM CHANNEL TO ACCOMMODATE STREAM BANK STABILIZATION DETAIL ON DRAWING NO. 34.

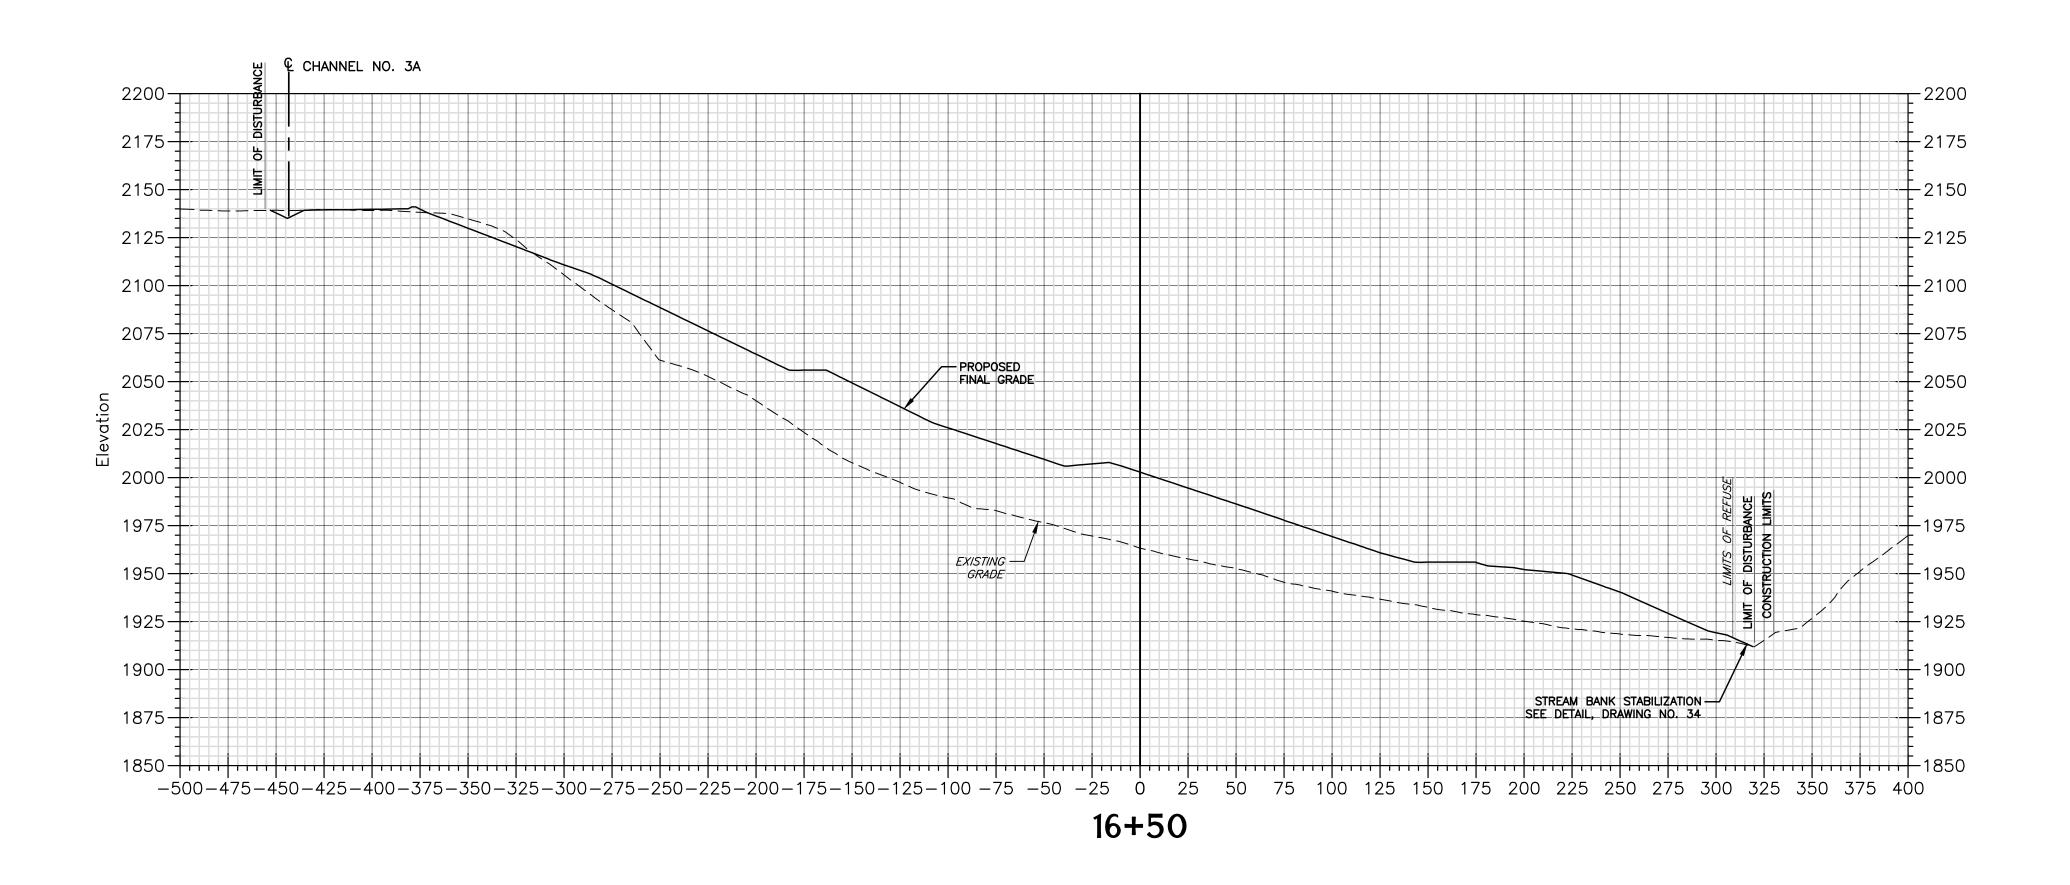


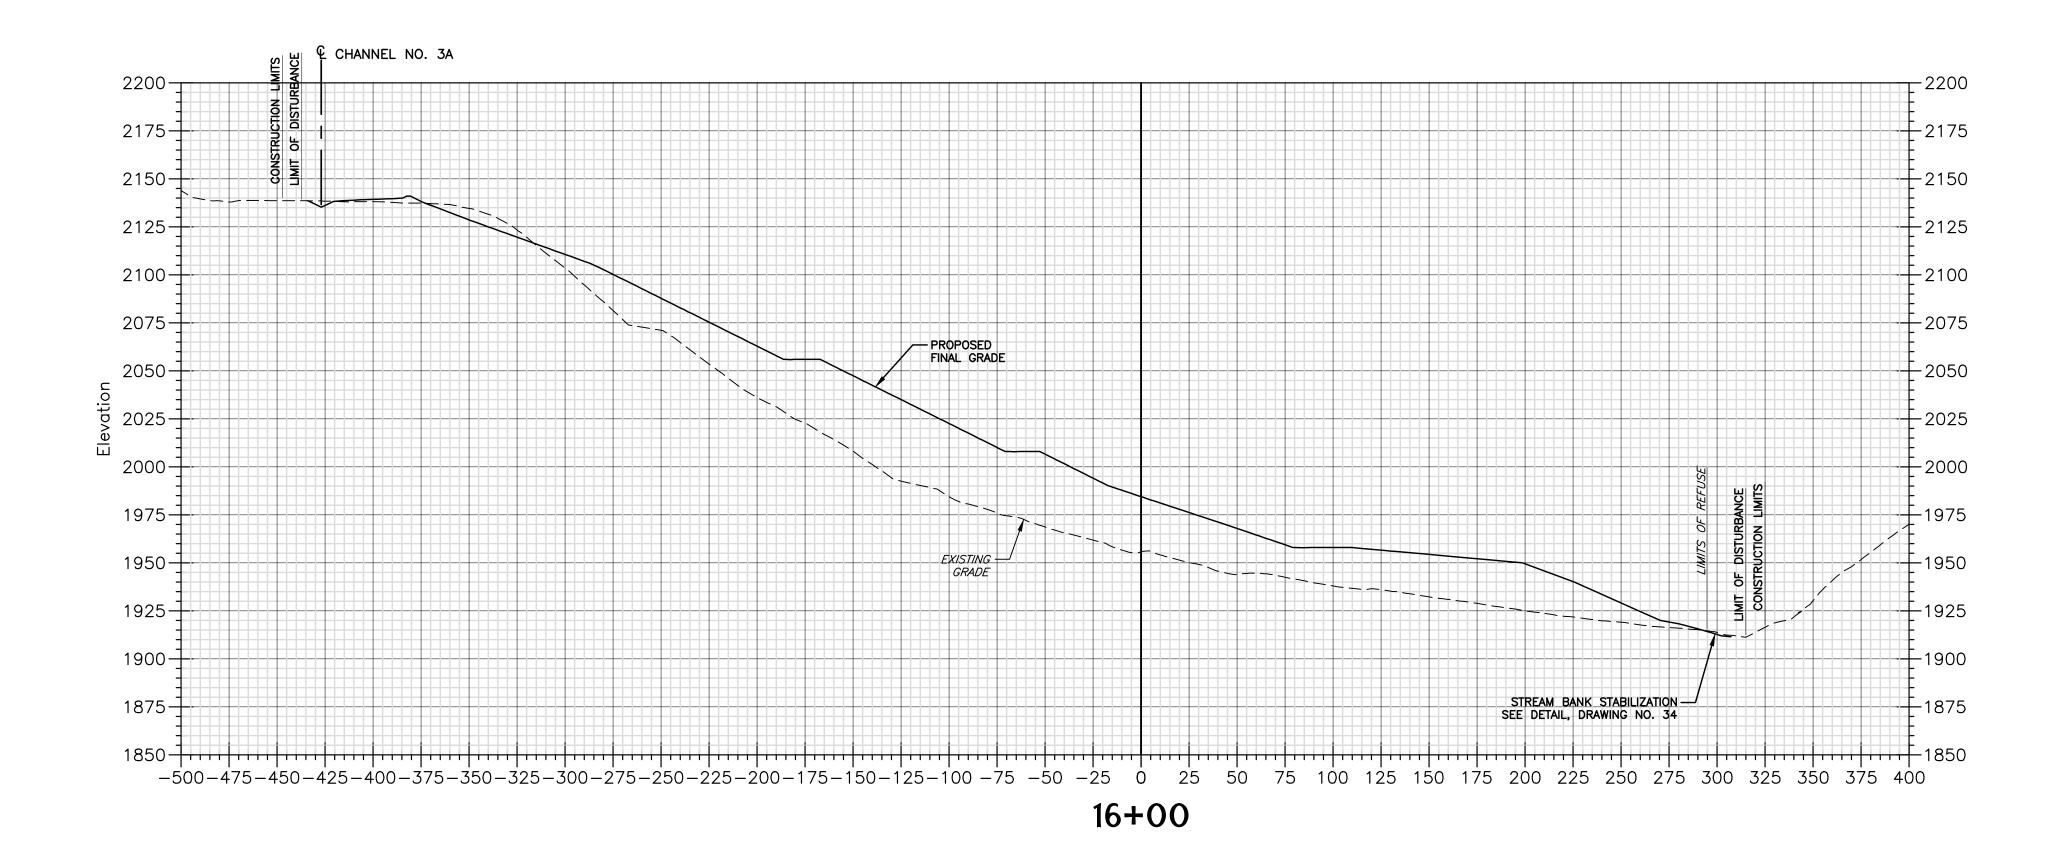

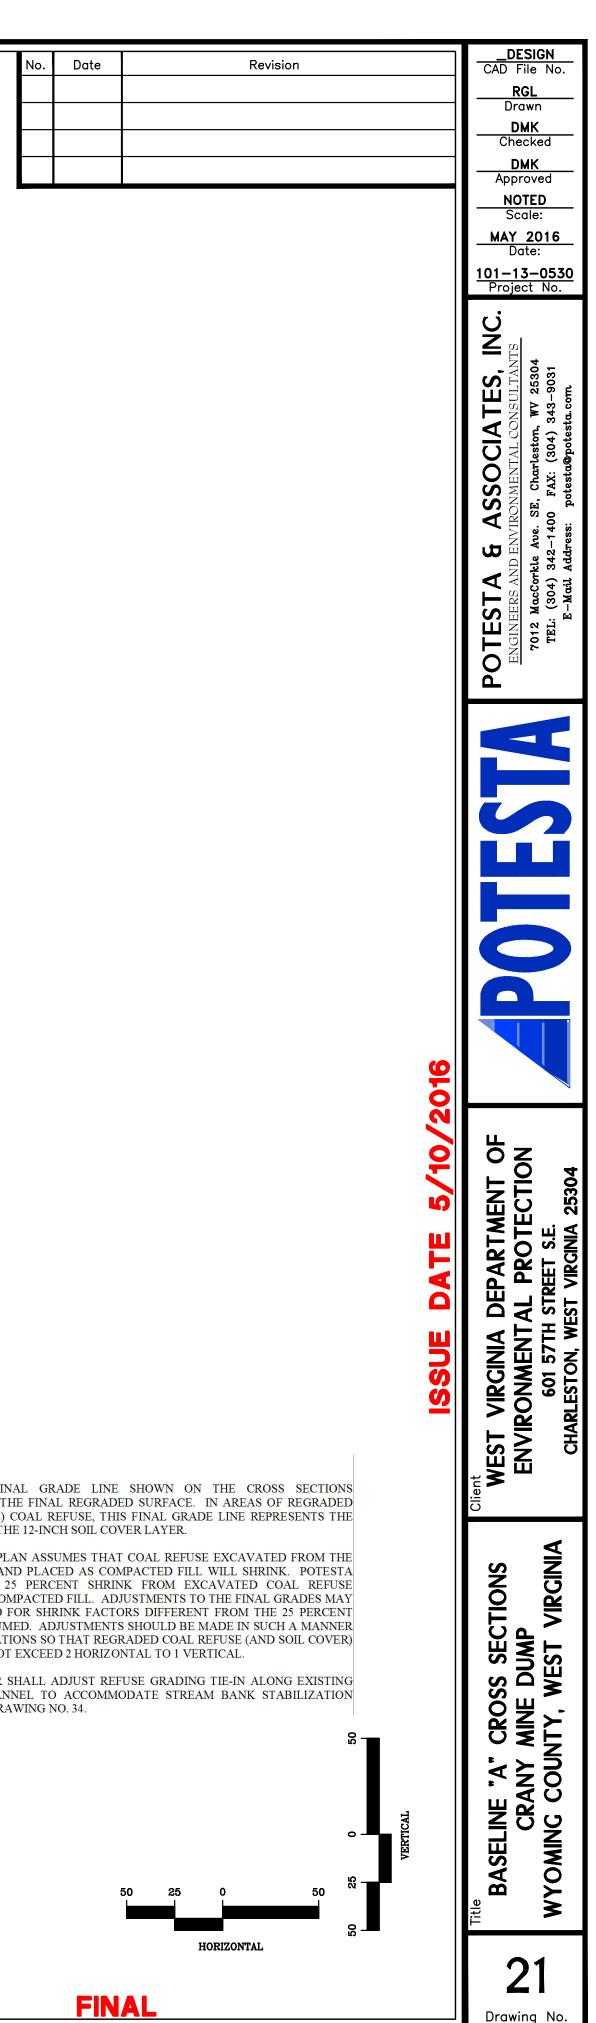

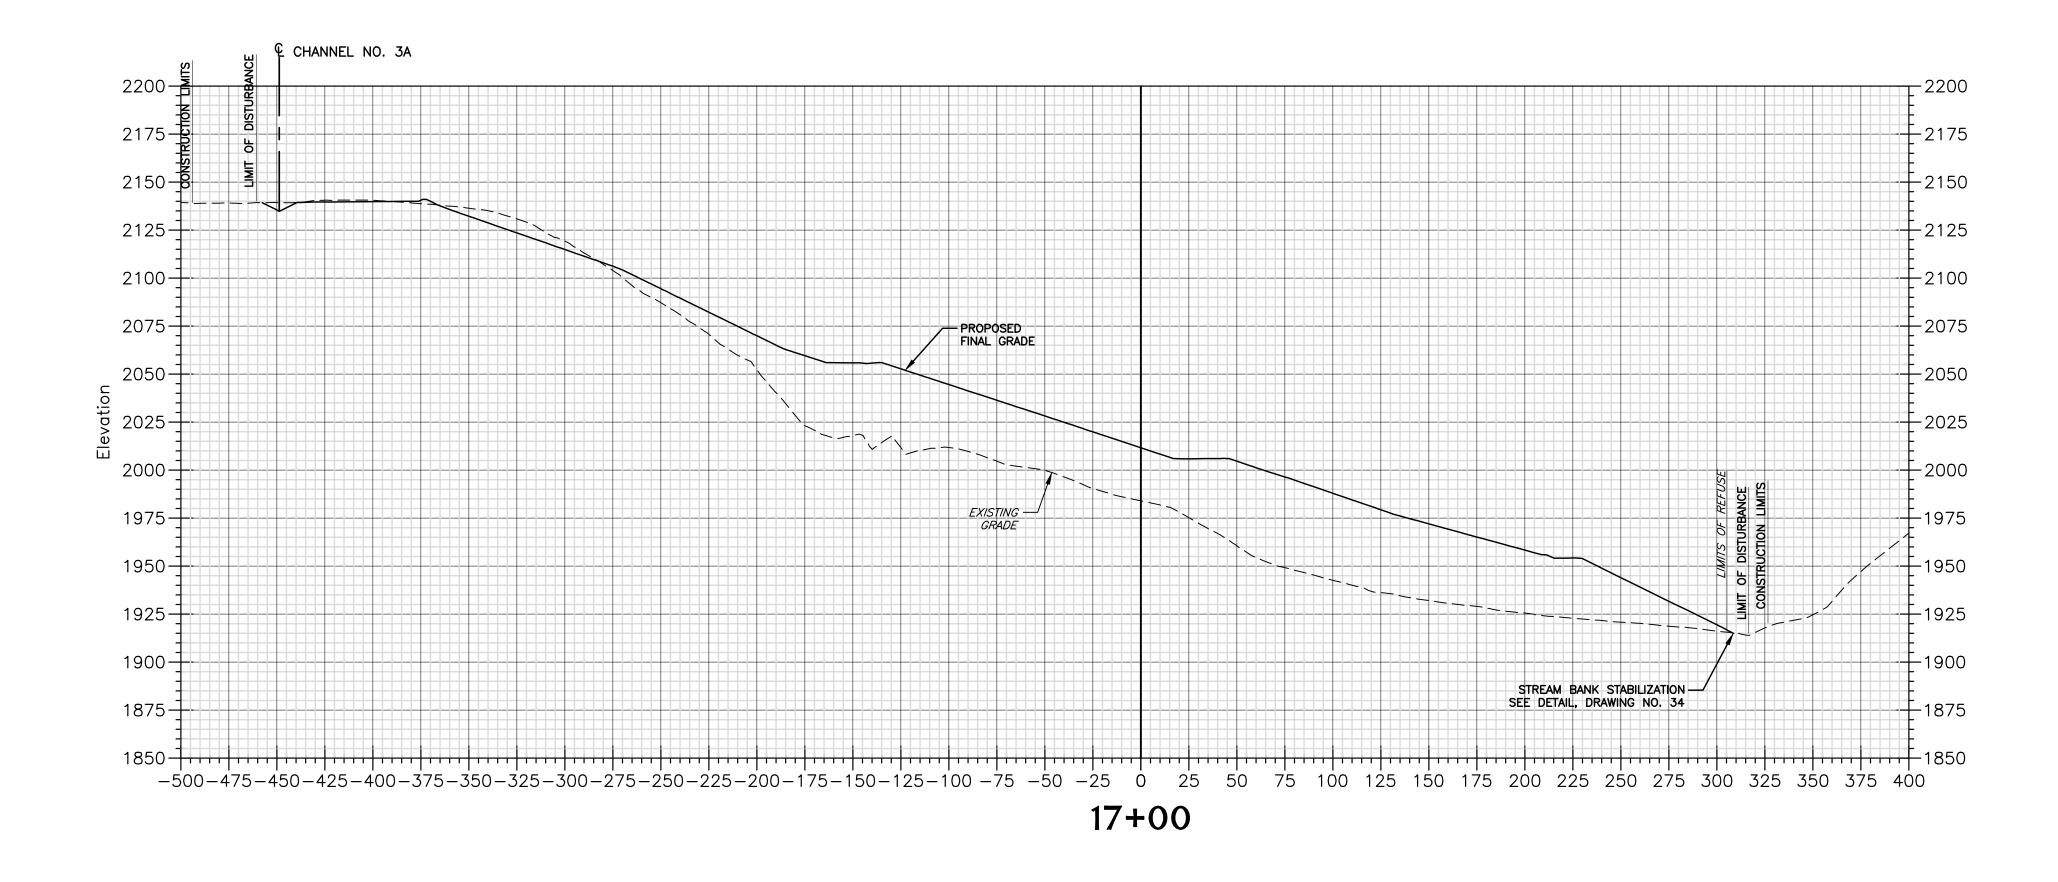
- 1. PROPOSED FINAL GRADE LINE SHOWN ON THE CROSS SECTIONS REPRESENTS THE FINAL REGRADED SURFACE. IN AREAS OF REGRADED (CUT OR FILL) COAL REFUSE, THIS FINAL GRADE LINE REPRESENTS THE SURFACE OF THE 12-INCH SOIL COVER LAYER.
- 2. REGRADING PLAN ASSUMES THAT COAL REFUSE EXCAVATED FROM THE MINE DUMP AND PLACED AS COMPACTED FILL WILL SHRINK. POTESTA ASSUMED A 25 PERCENT SHRINK FROM EXCAVATED COAL REFUSE PLACED AS COMPACTED FILL. ADJUSTMENTS TO THE FINAL GRADES MAY BE REQUIRED FOR SHRINK FACTORS DIFFERENT FROM THE 25 PERCENT FACTOR ASSUMED. ADJUSTMENTS SHOULD BE MADE IN SUCH A MANNER AND AT LOCATIONS SO THAT REGRADED COAL REFUSE (AND SOIL COVER) SLOPES DO NOT EXCEED 2 HORIZONTAL TO 1 VERTICAL.
- CONTRACTOR SHALL ADJUST REFUSE GRADING TIE-IN ALONG EXISTING STREAM CHANNEL TO ACCOMMODATE STREAM BANK STABILIZATION DETAIL ON DRAWING NO. 34.




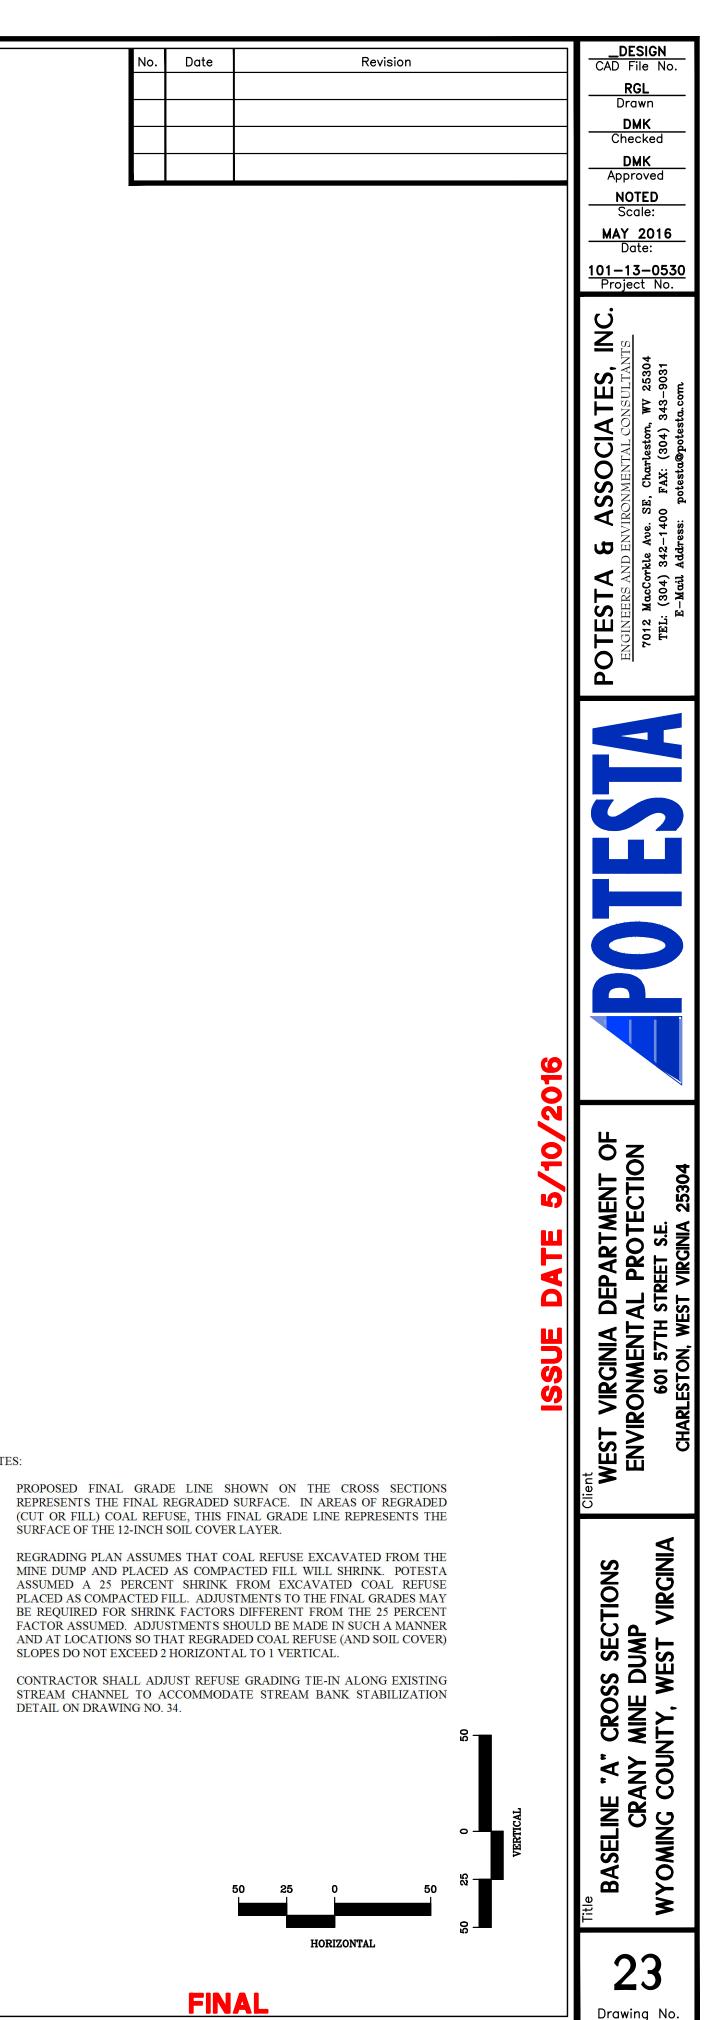

1. REPRESENTS THE FINAL REGRADED SURFACE. IN AREAS OF REGRADED (CUT OR FILL) COAL REFUSE, THIS FINAL GRADE LINE REPRESENTS THE SURFACE OF THE 12-INCH SOIL COVER LAYER.


2. REGRADING PLAN ASSUMES THAT COAL REFUSE EXCAVATED FROM THE MINE DUMP AND PLACED AS COMPACTED FILL WILL SHRINK. POTESTA ASSUMED A 25 PERCENT SHRINK FROM EXCAVATED COAL REFUSE PLACED AS COMPACTED FILL. ADJUSTMENTS TO THE FINAL GRADES MAY BE REQUIRED FOR SHRINK FACTORS DIFFERENT FROM THE 25 PERCENT FACTOR ASSUMED. ADJUSTMENTS SHOULD BE MADE IN SUCH A MANNER AND AT LOCATIONS SO THAT REGRADED COAL REFUSE (AND SOIL COVER) SLOPES DO NOT EXCEED 2 HORIZONTAL TO 1 VERTICAL.

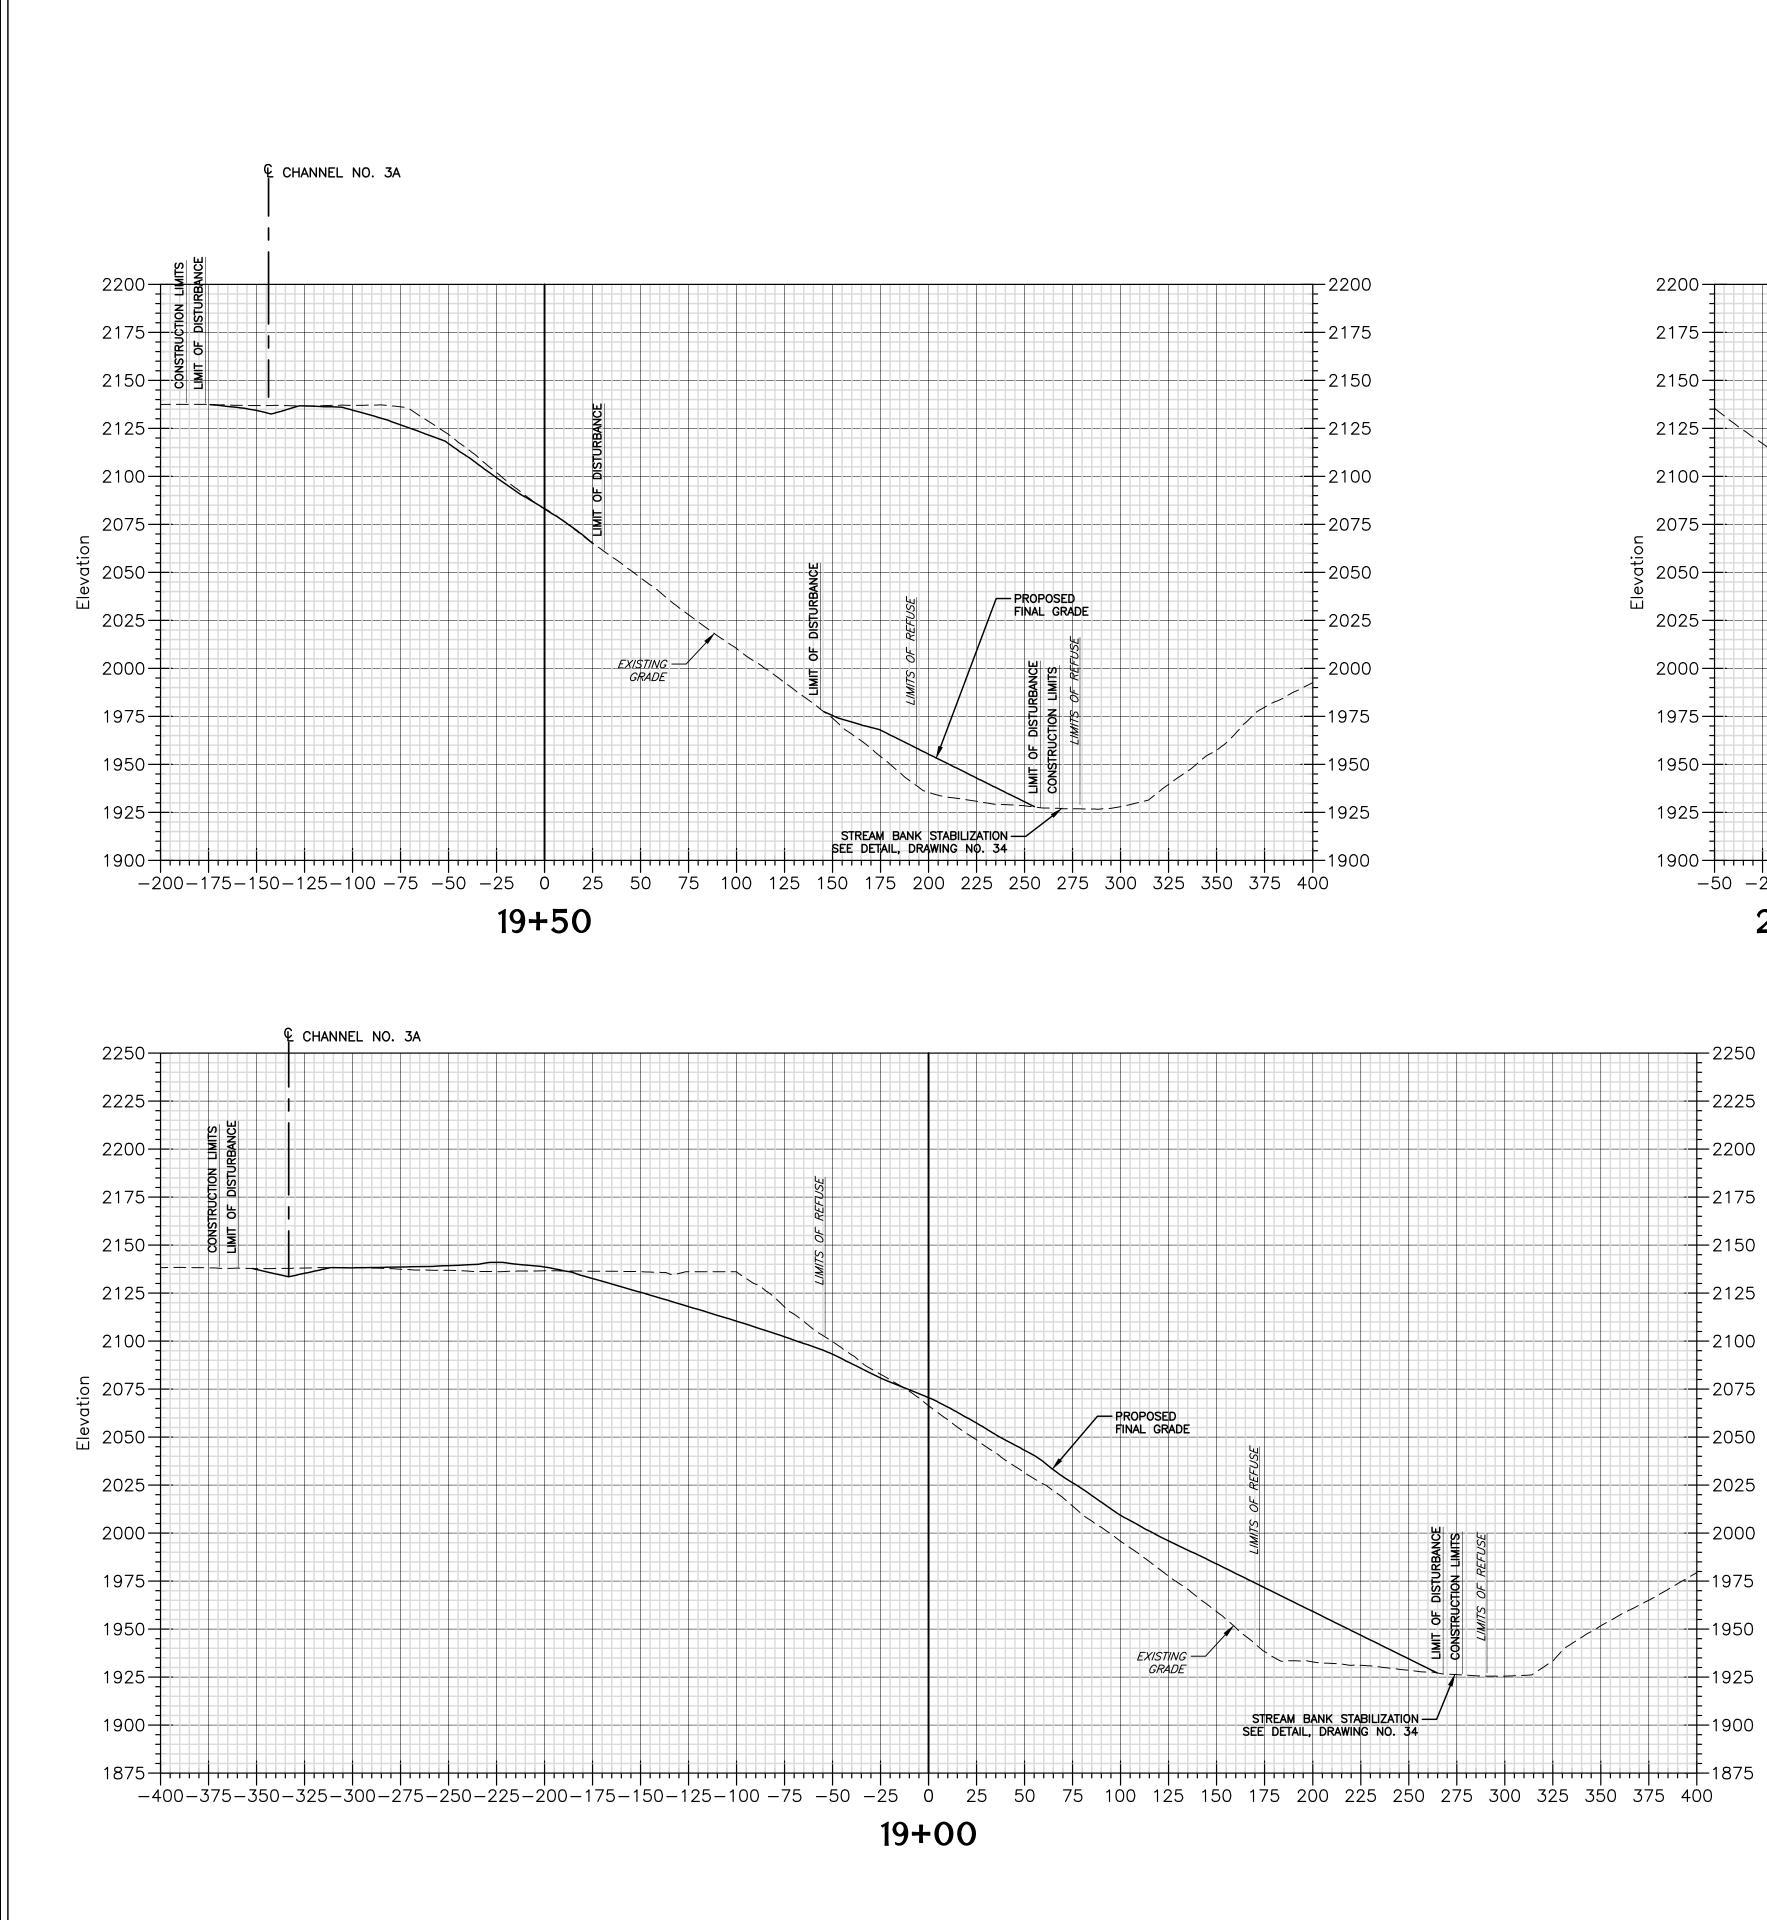


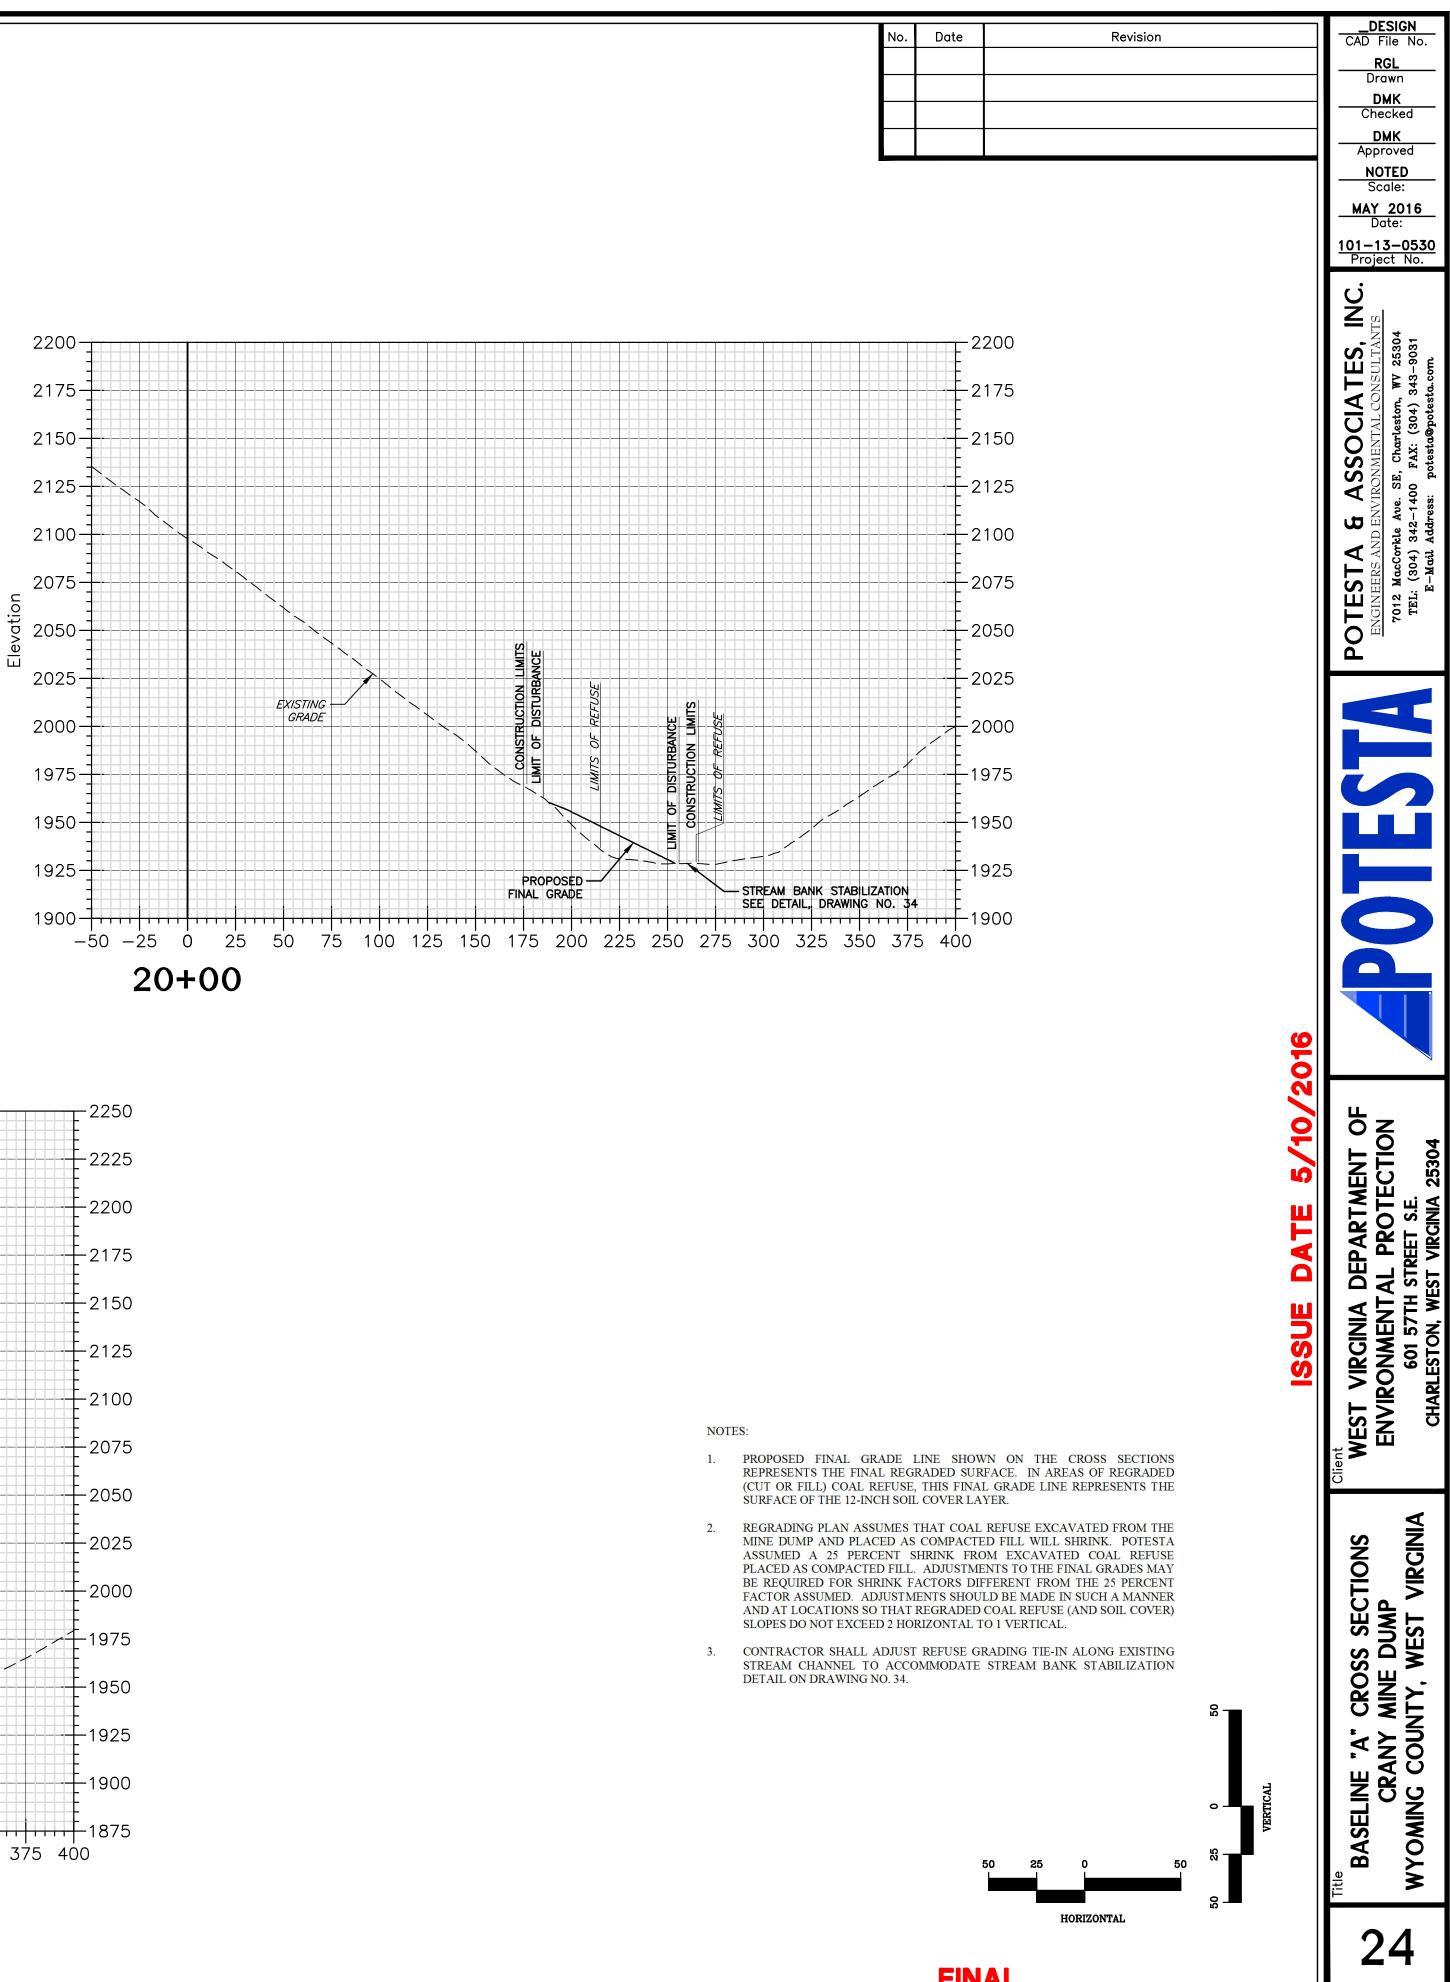


FINAL


Drawing No.

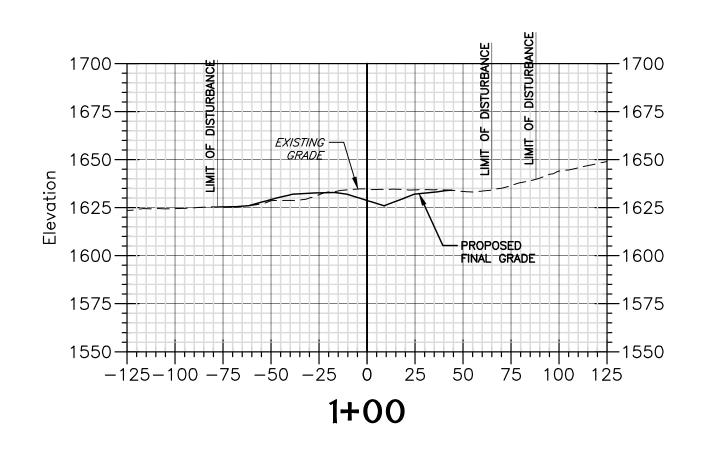


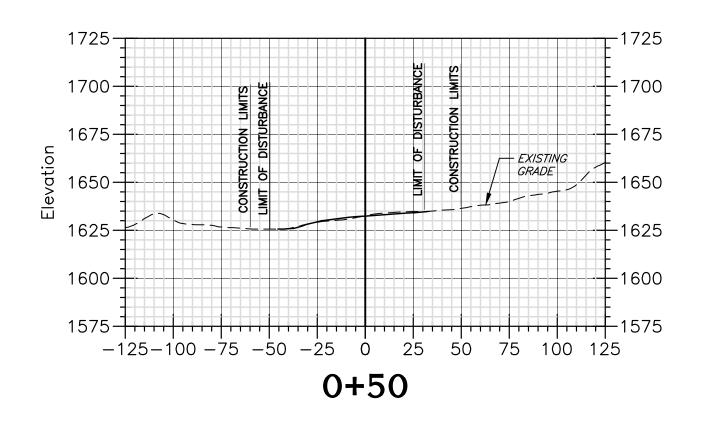


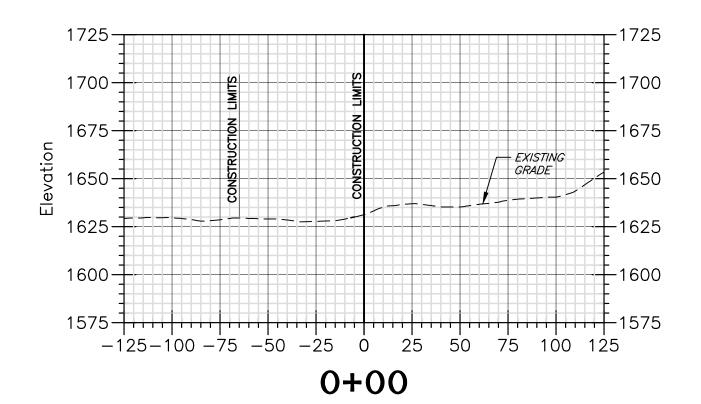





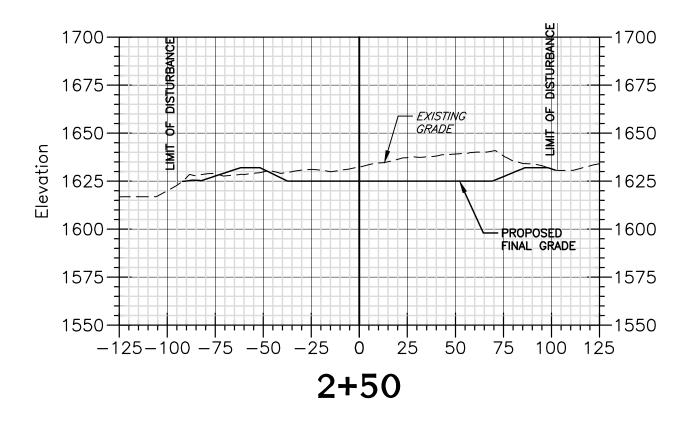

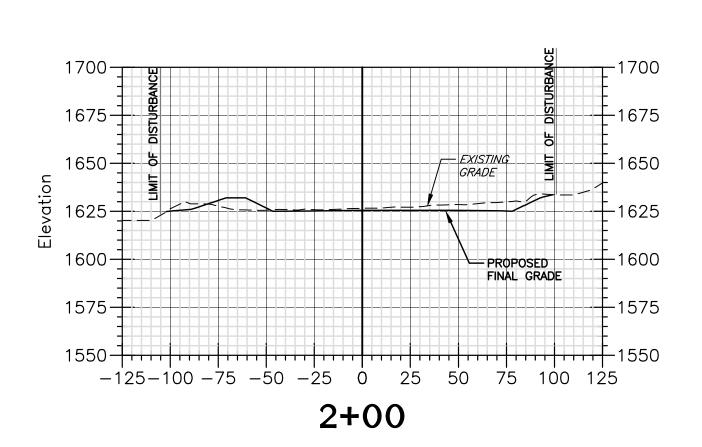


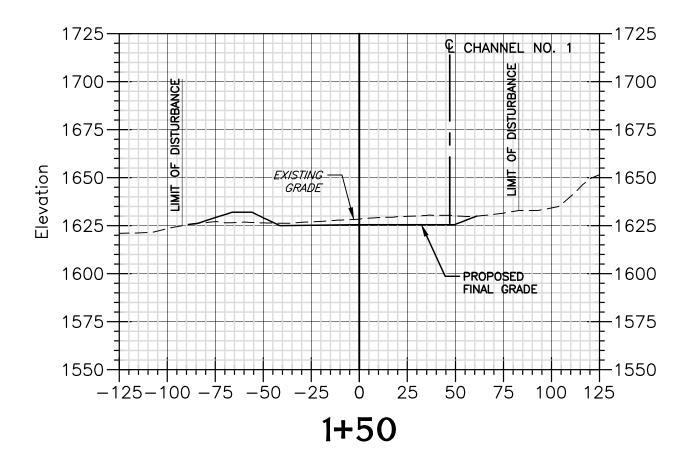


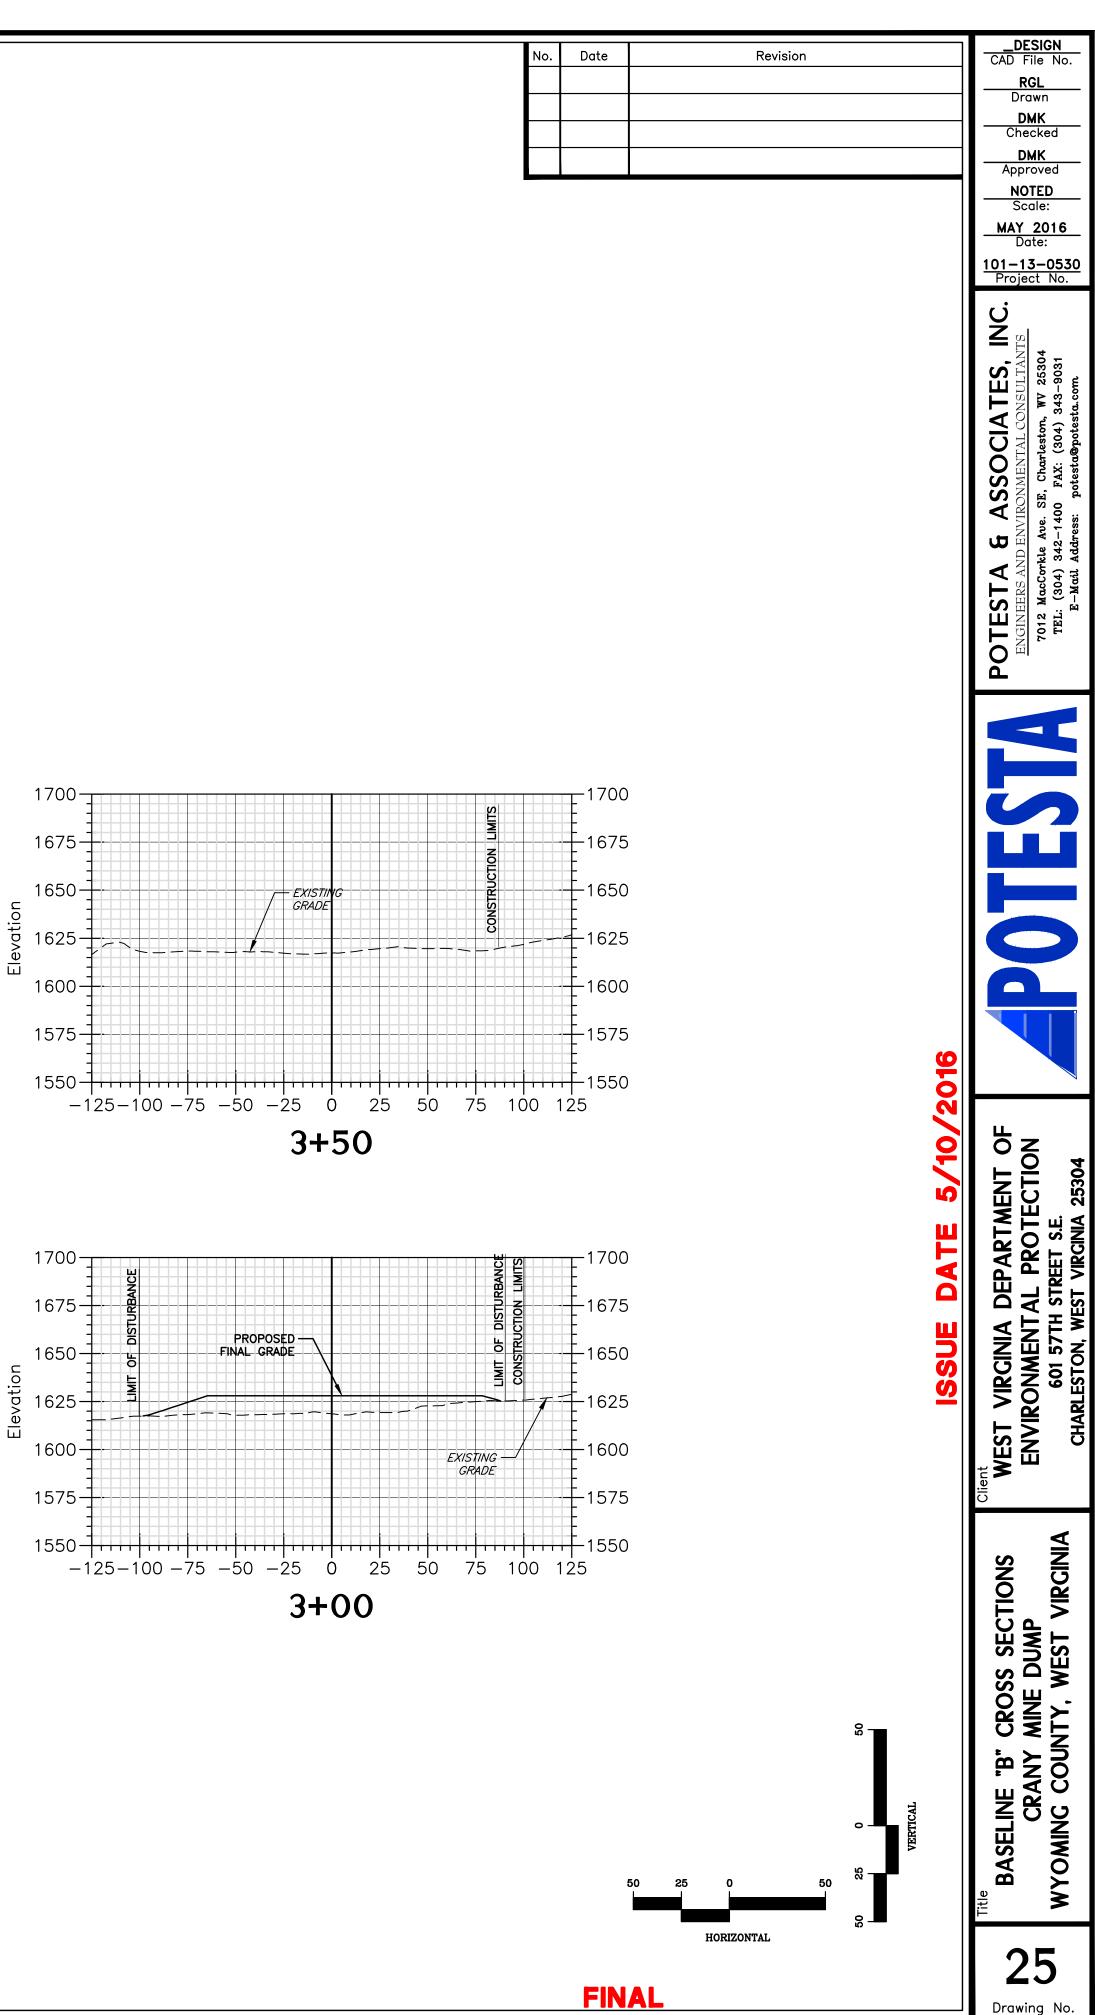


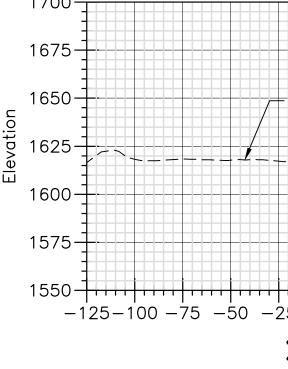




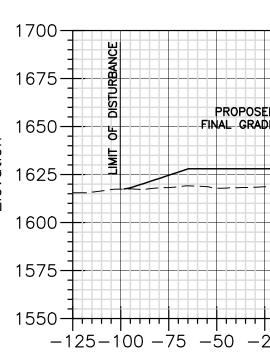

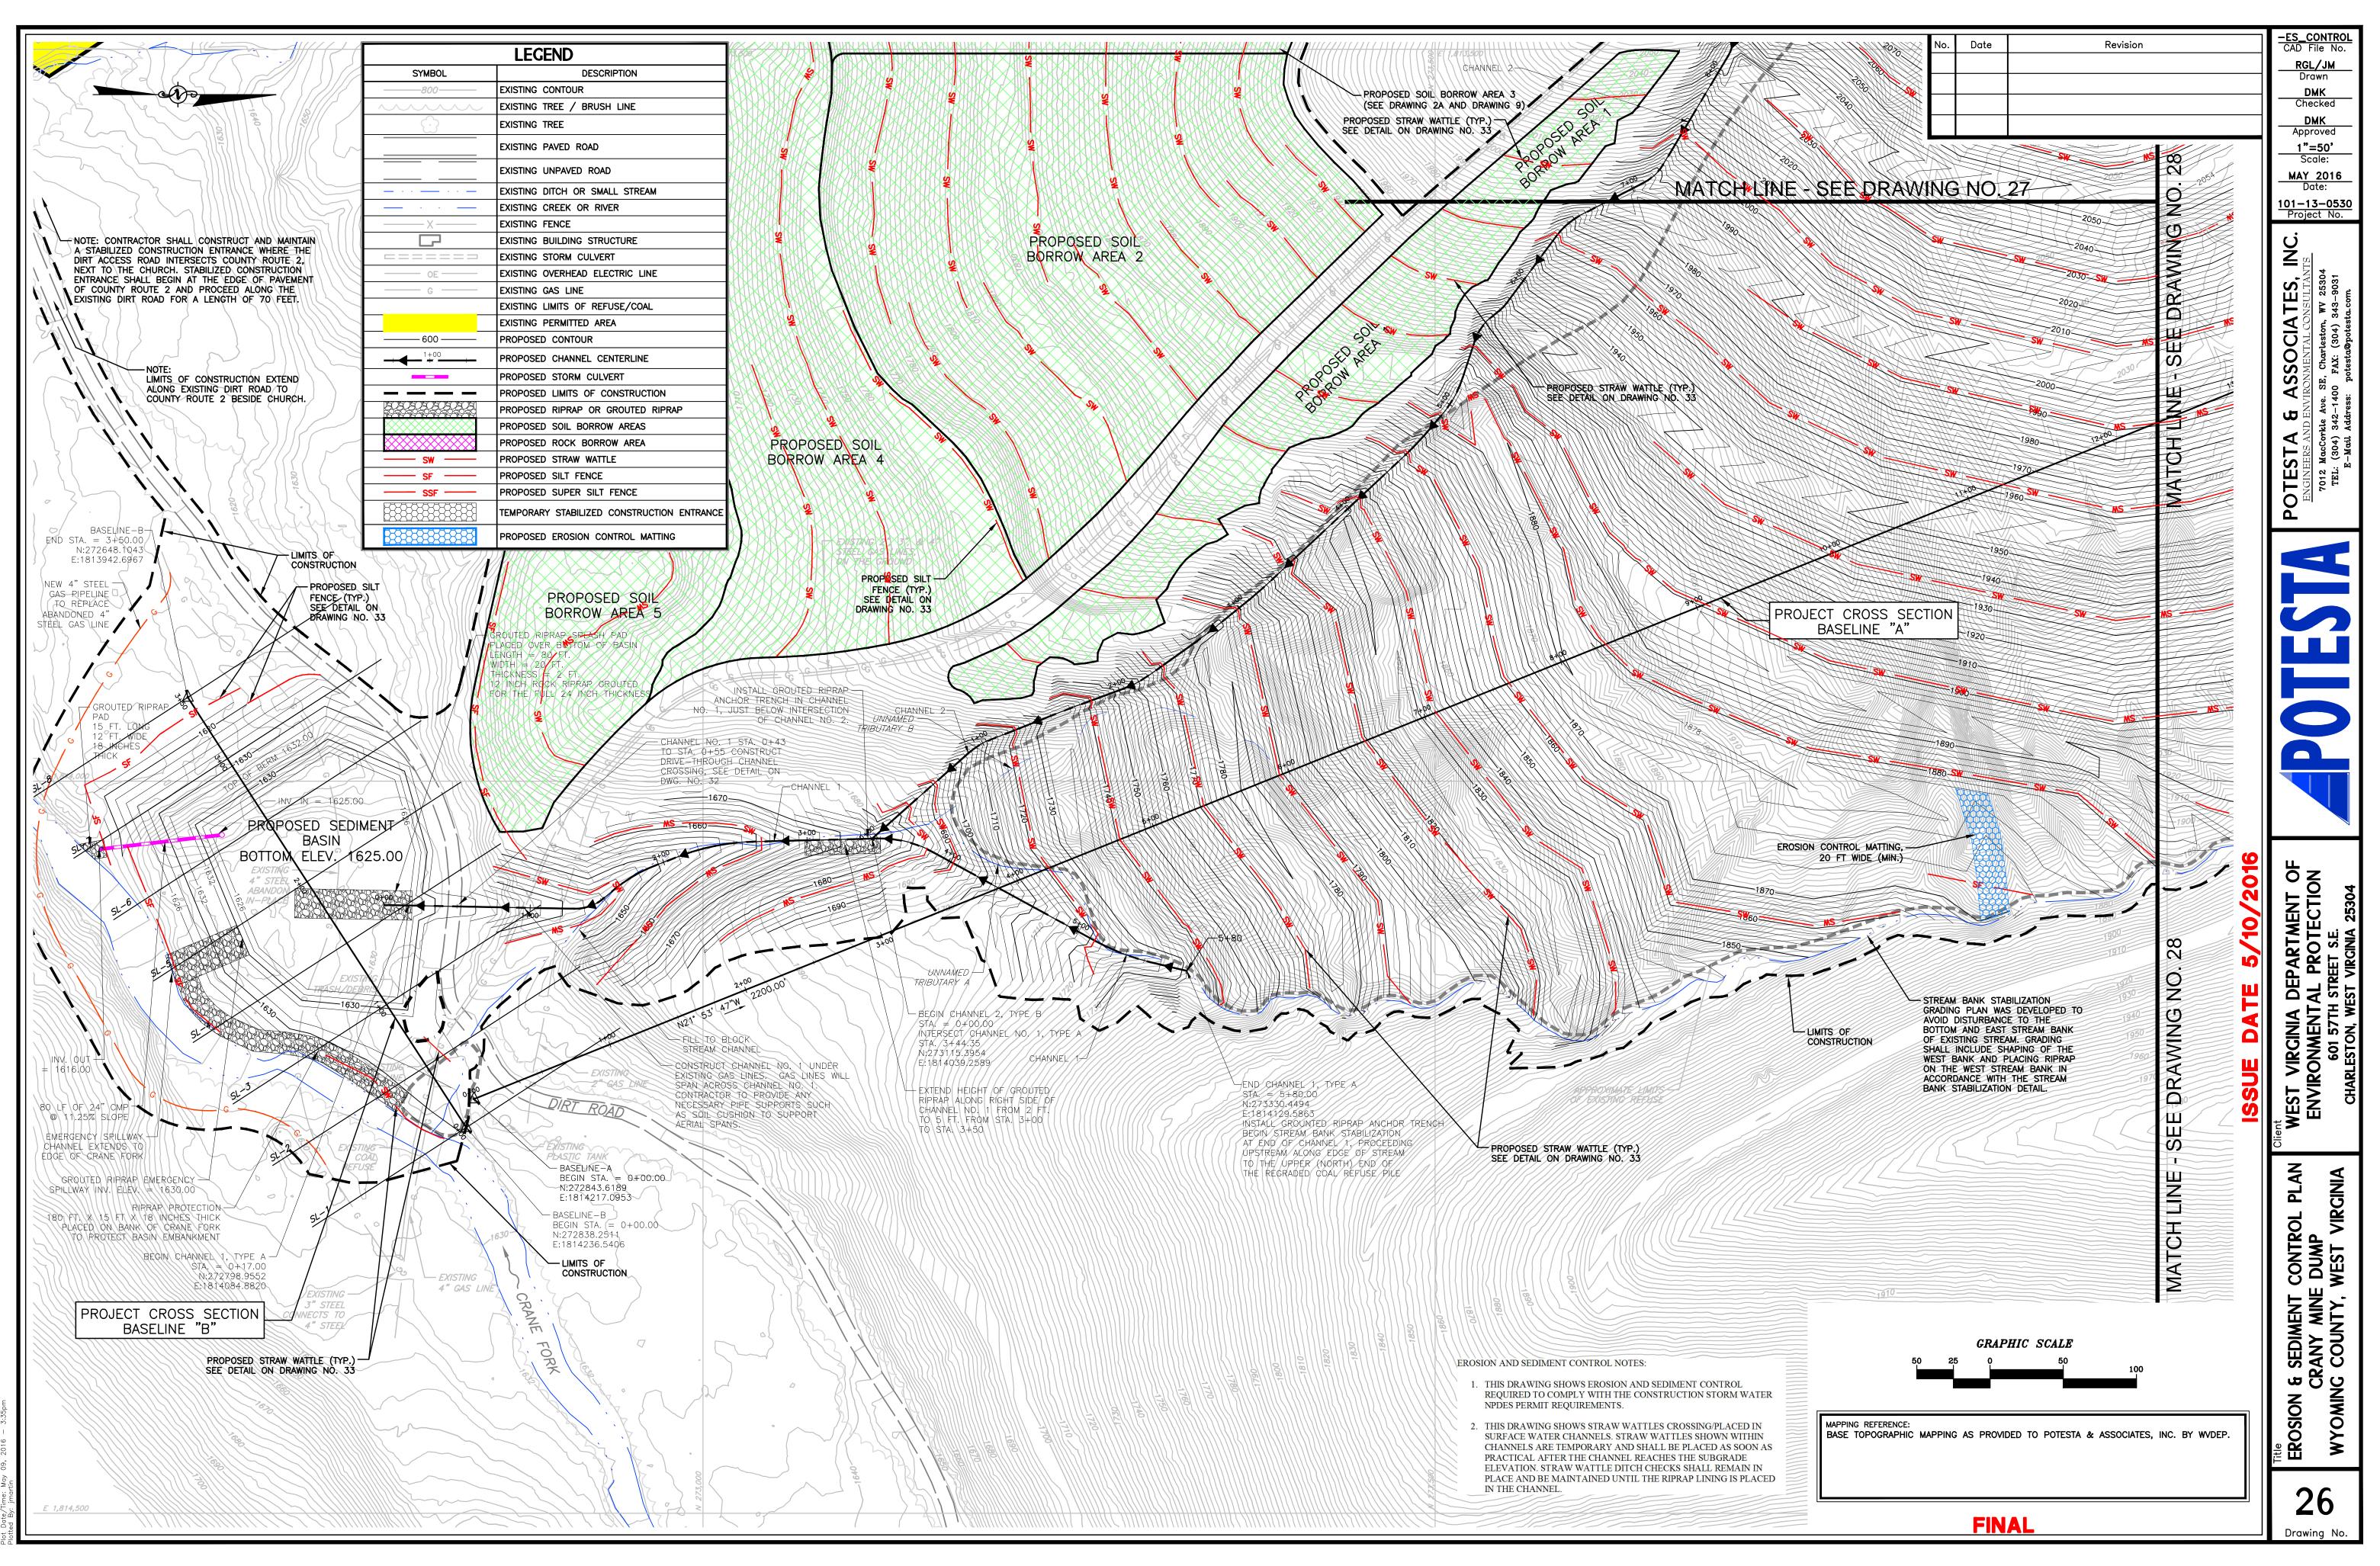


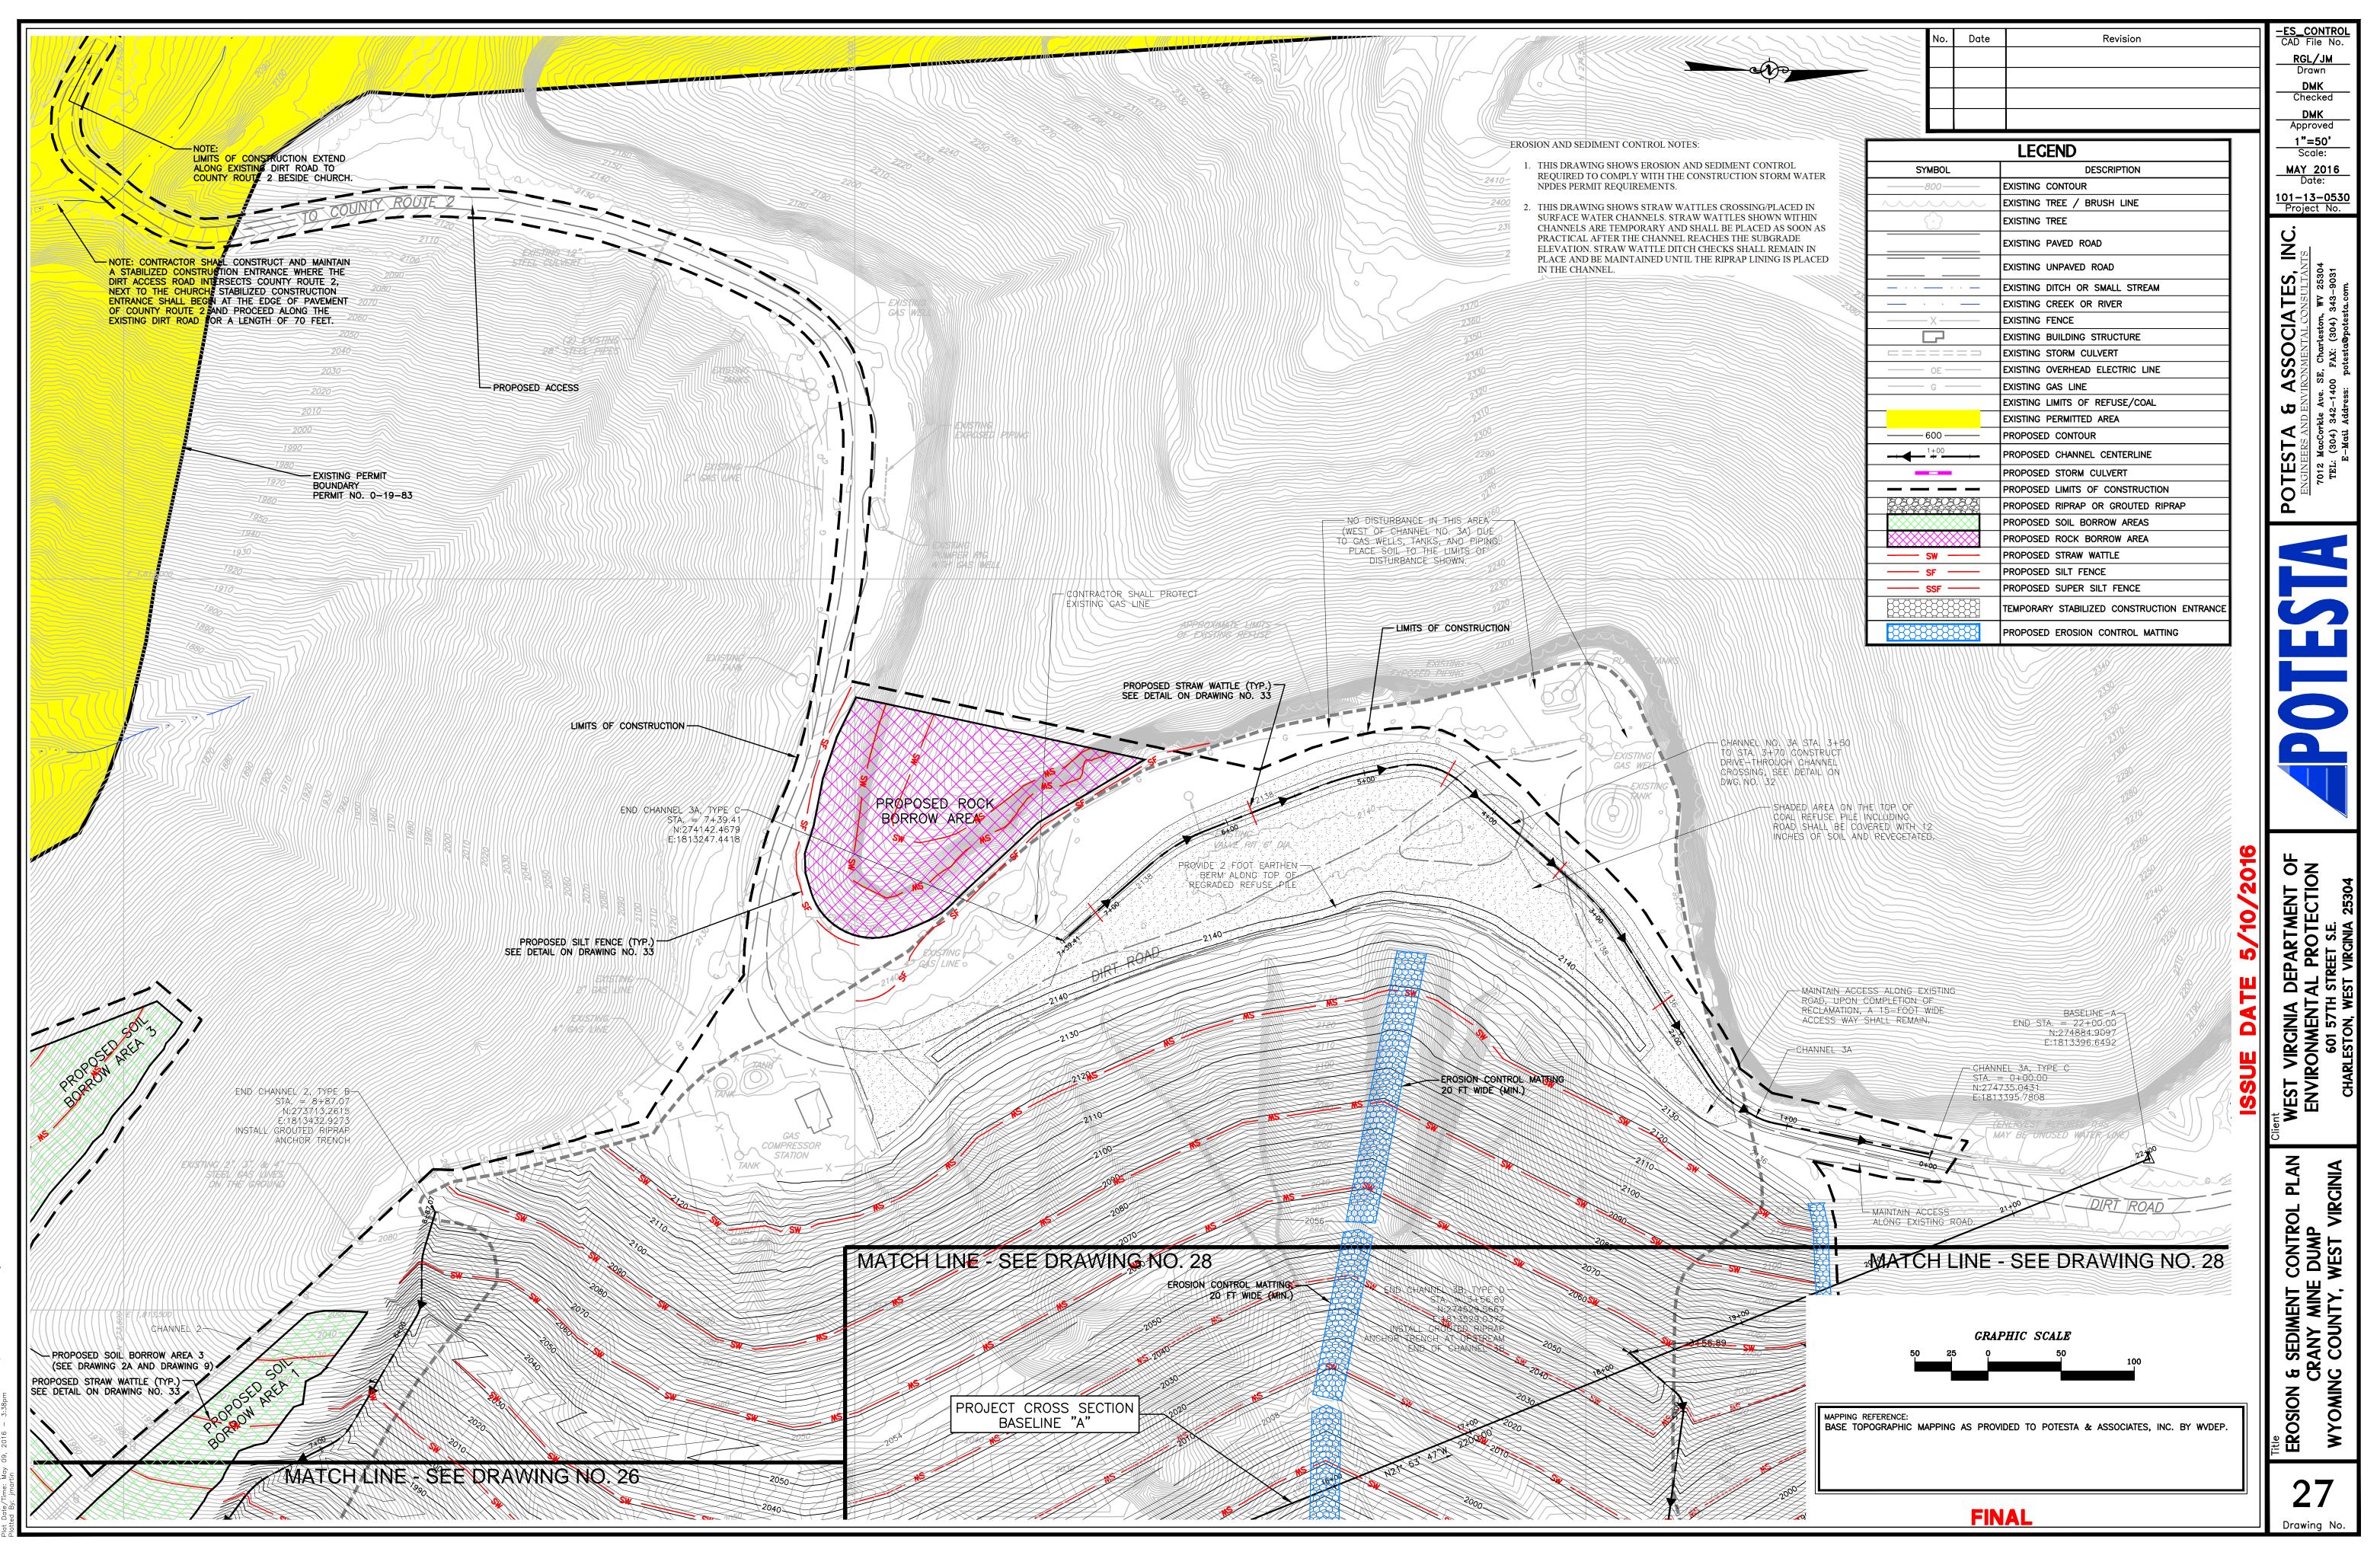


XREF Files: 13-0530\_REC PLAN 13-0530\_EXISTING REC-LEGEND EXIST-LEGEND GOOGLE IMAGE BW E&S-LEGEND EXIST-PERMIT MAP SOIL-LEN IMAGE Files: GE184BA.jpg File: S:\C3D-Proi-YR\2013\13-0530-AML-CRANY\13-0530-ES\_CONTROL.dwq

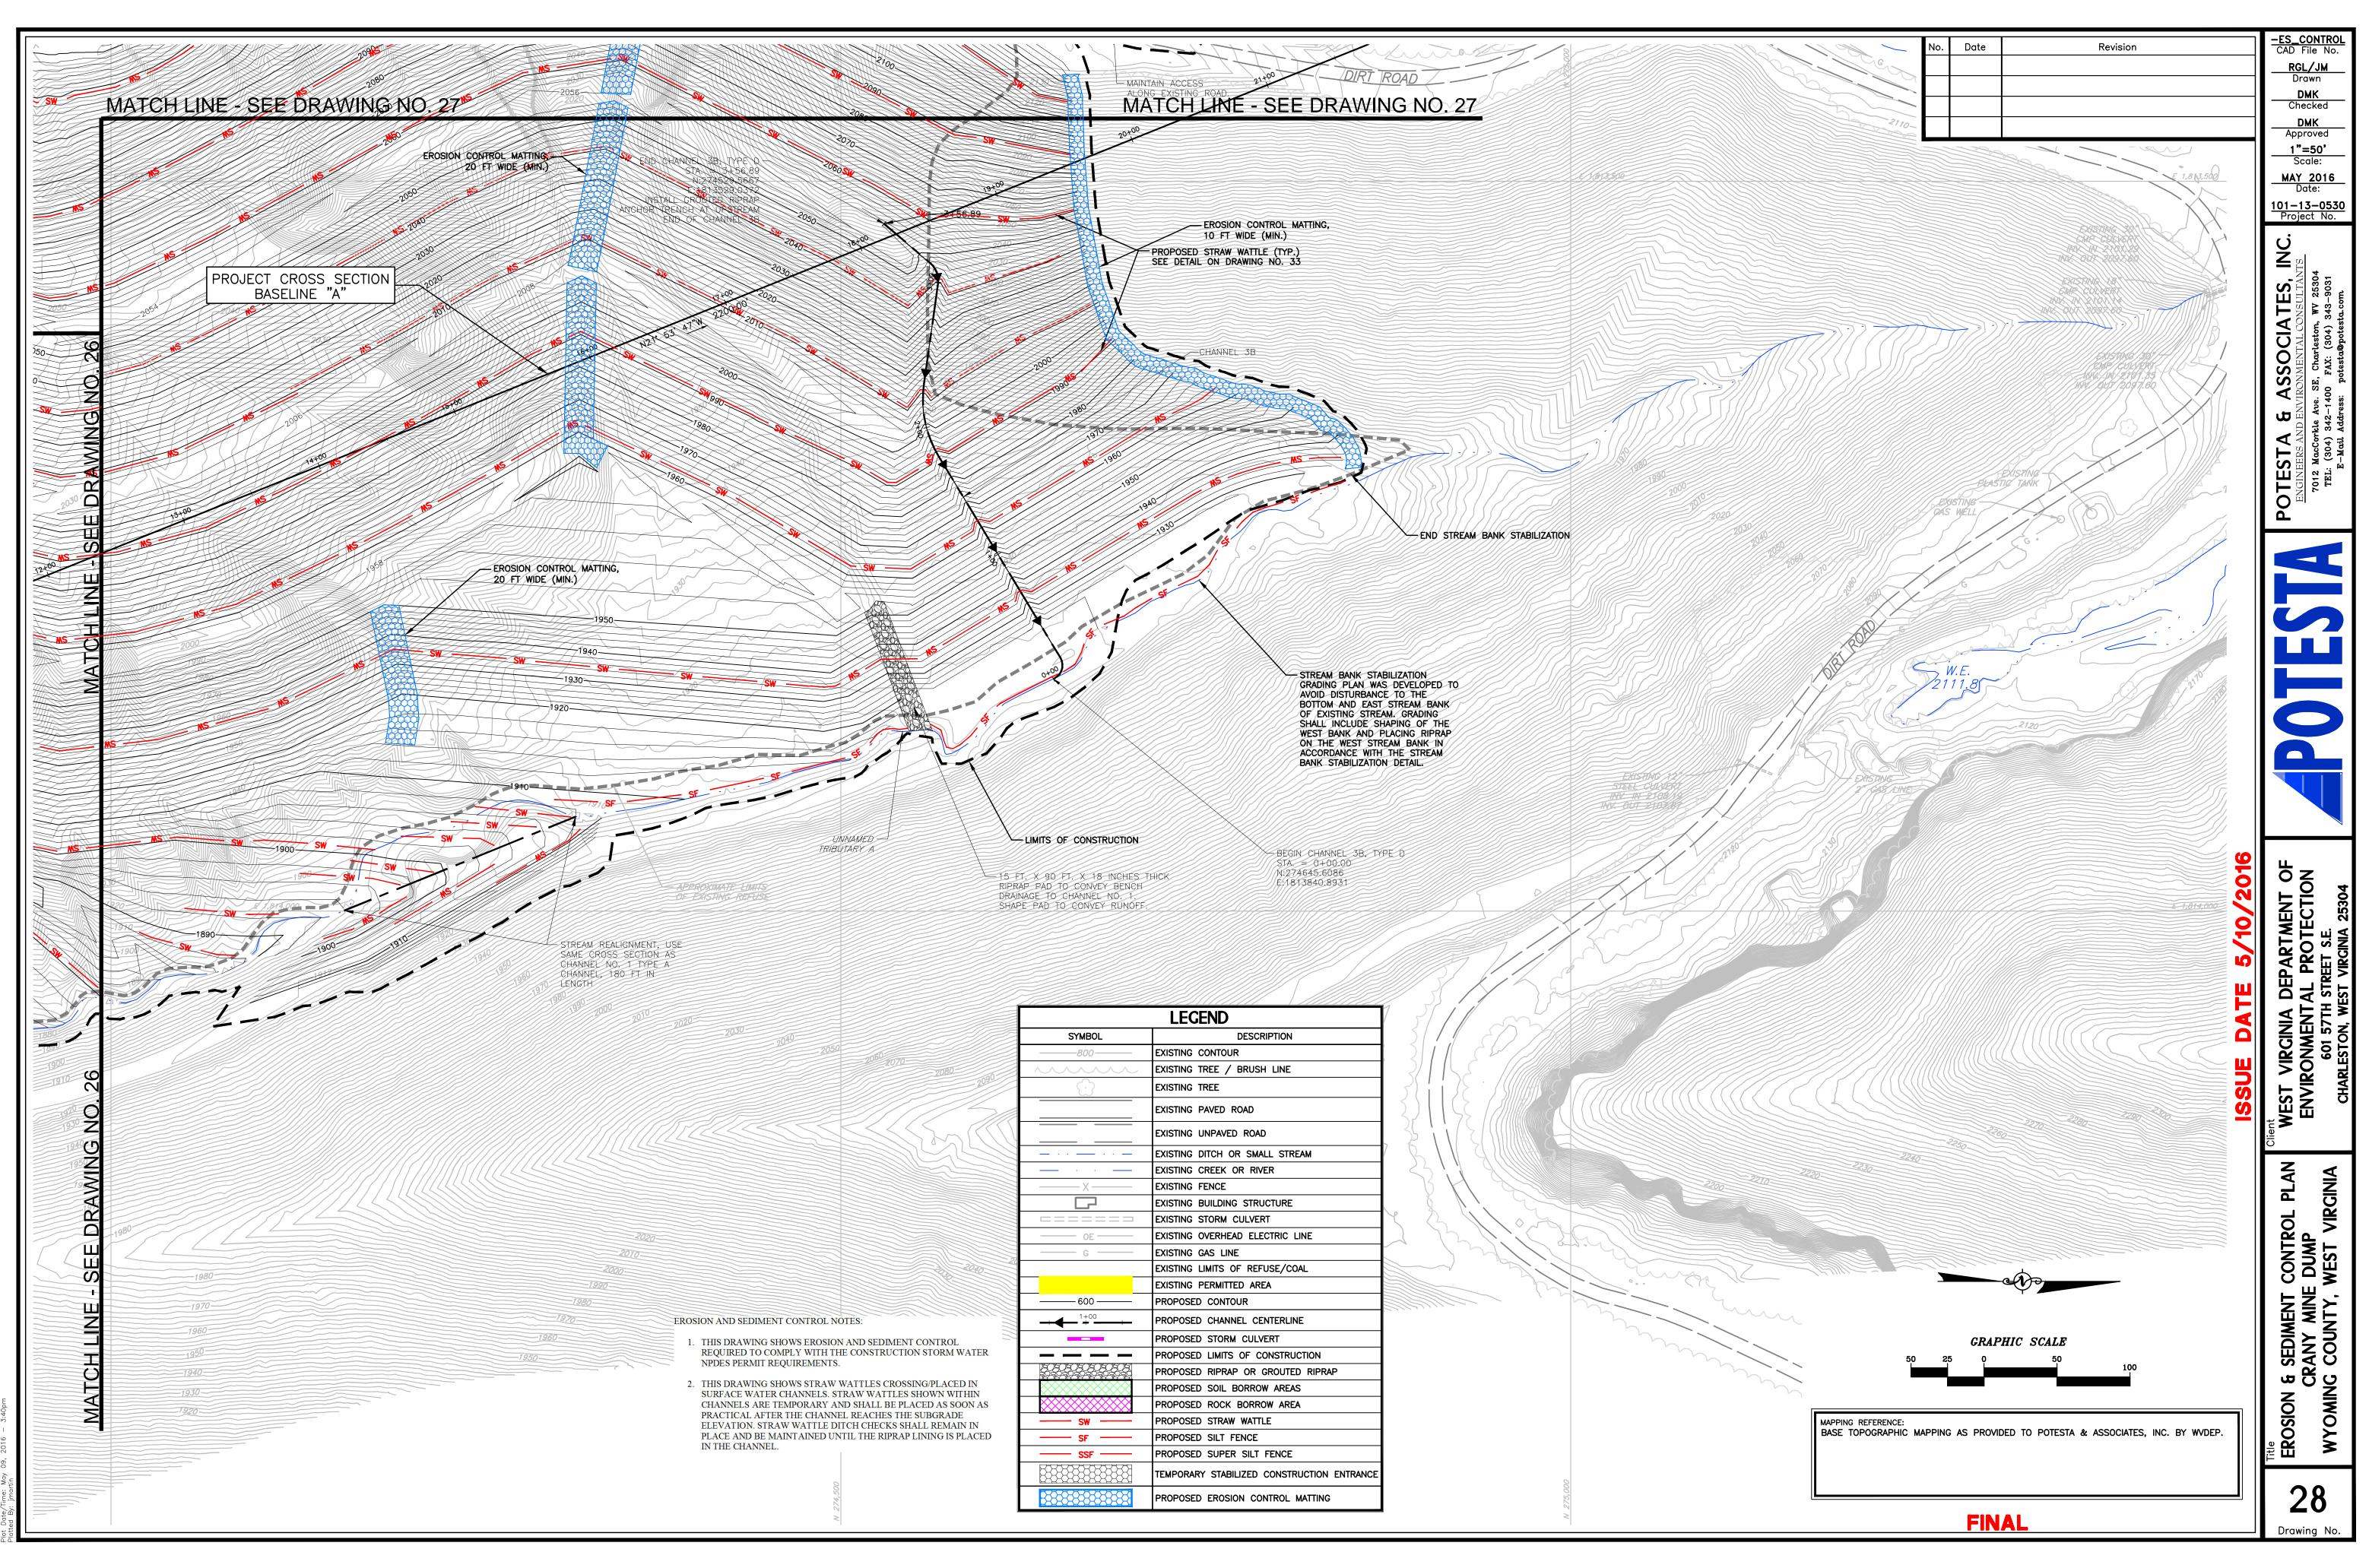


"iles: 13-0530\_REC PLAN 13-0530\_EXISTING REC-LEGEND EXIST-LEGEND GOOGLE IMAGE BW E&S-LEGEND EXIST-PERMIT MAP SO Files: GEIB4BA,jpg \C3D-Proj-YR\2013\13-0530-AML-CRANY\13-0530-ES\_CONTROL.dwg

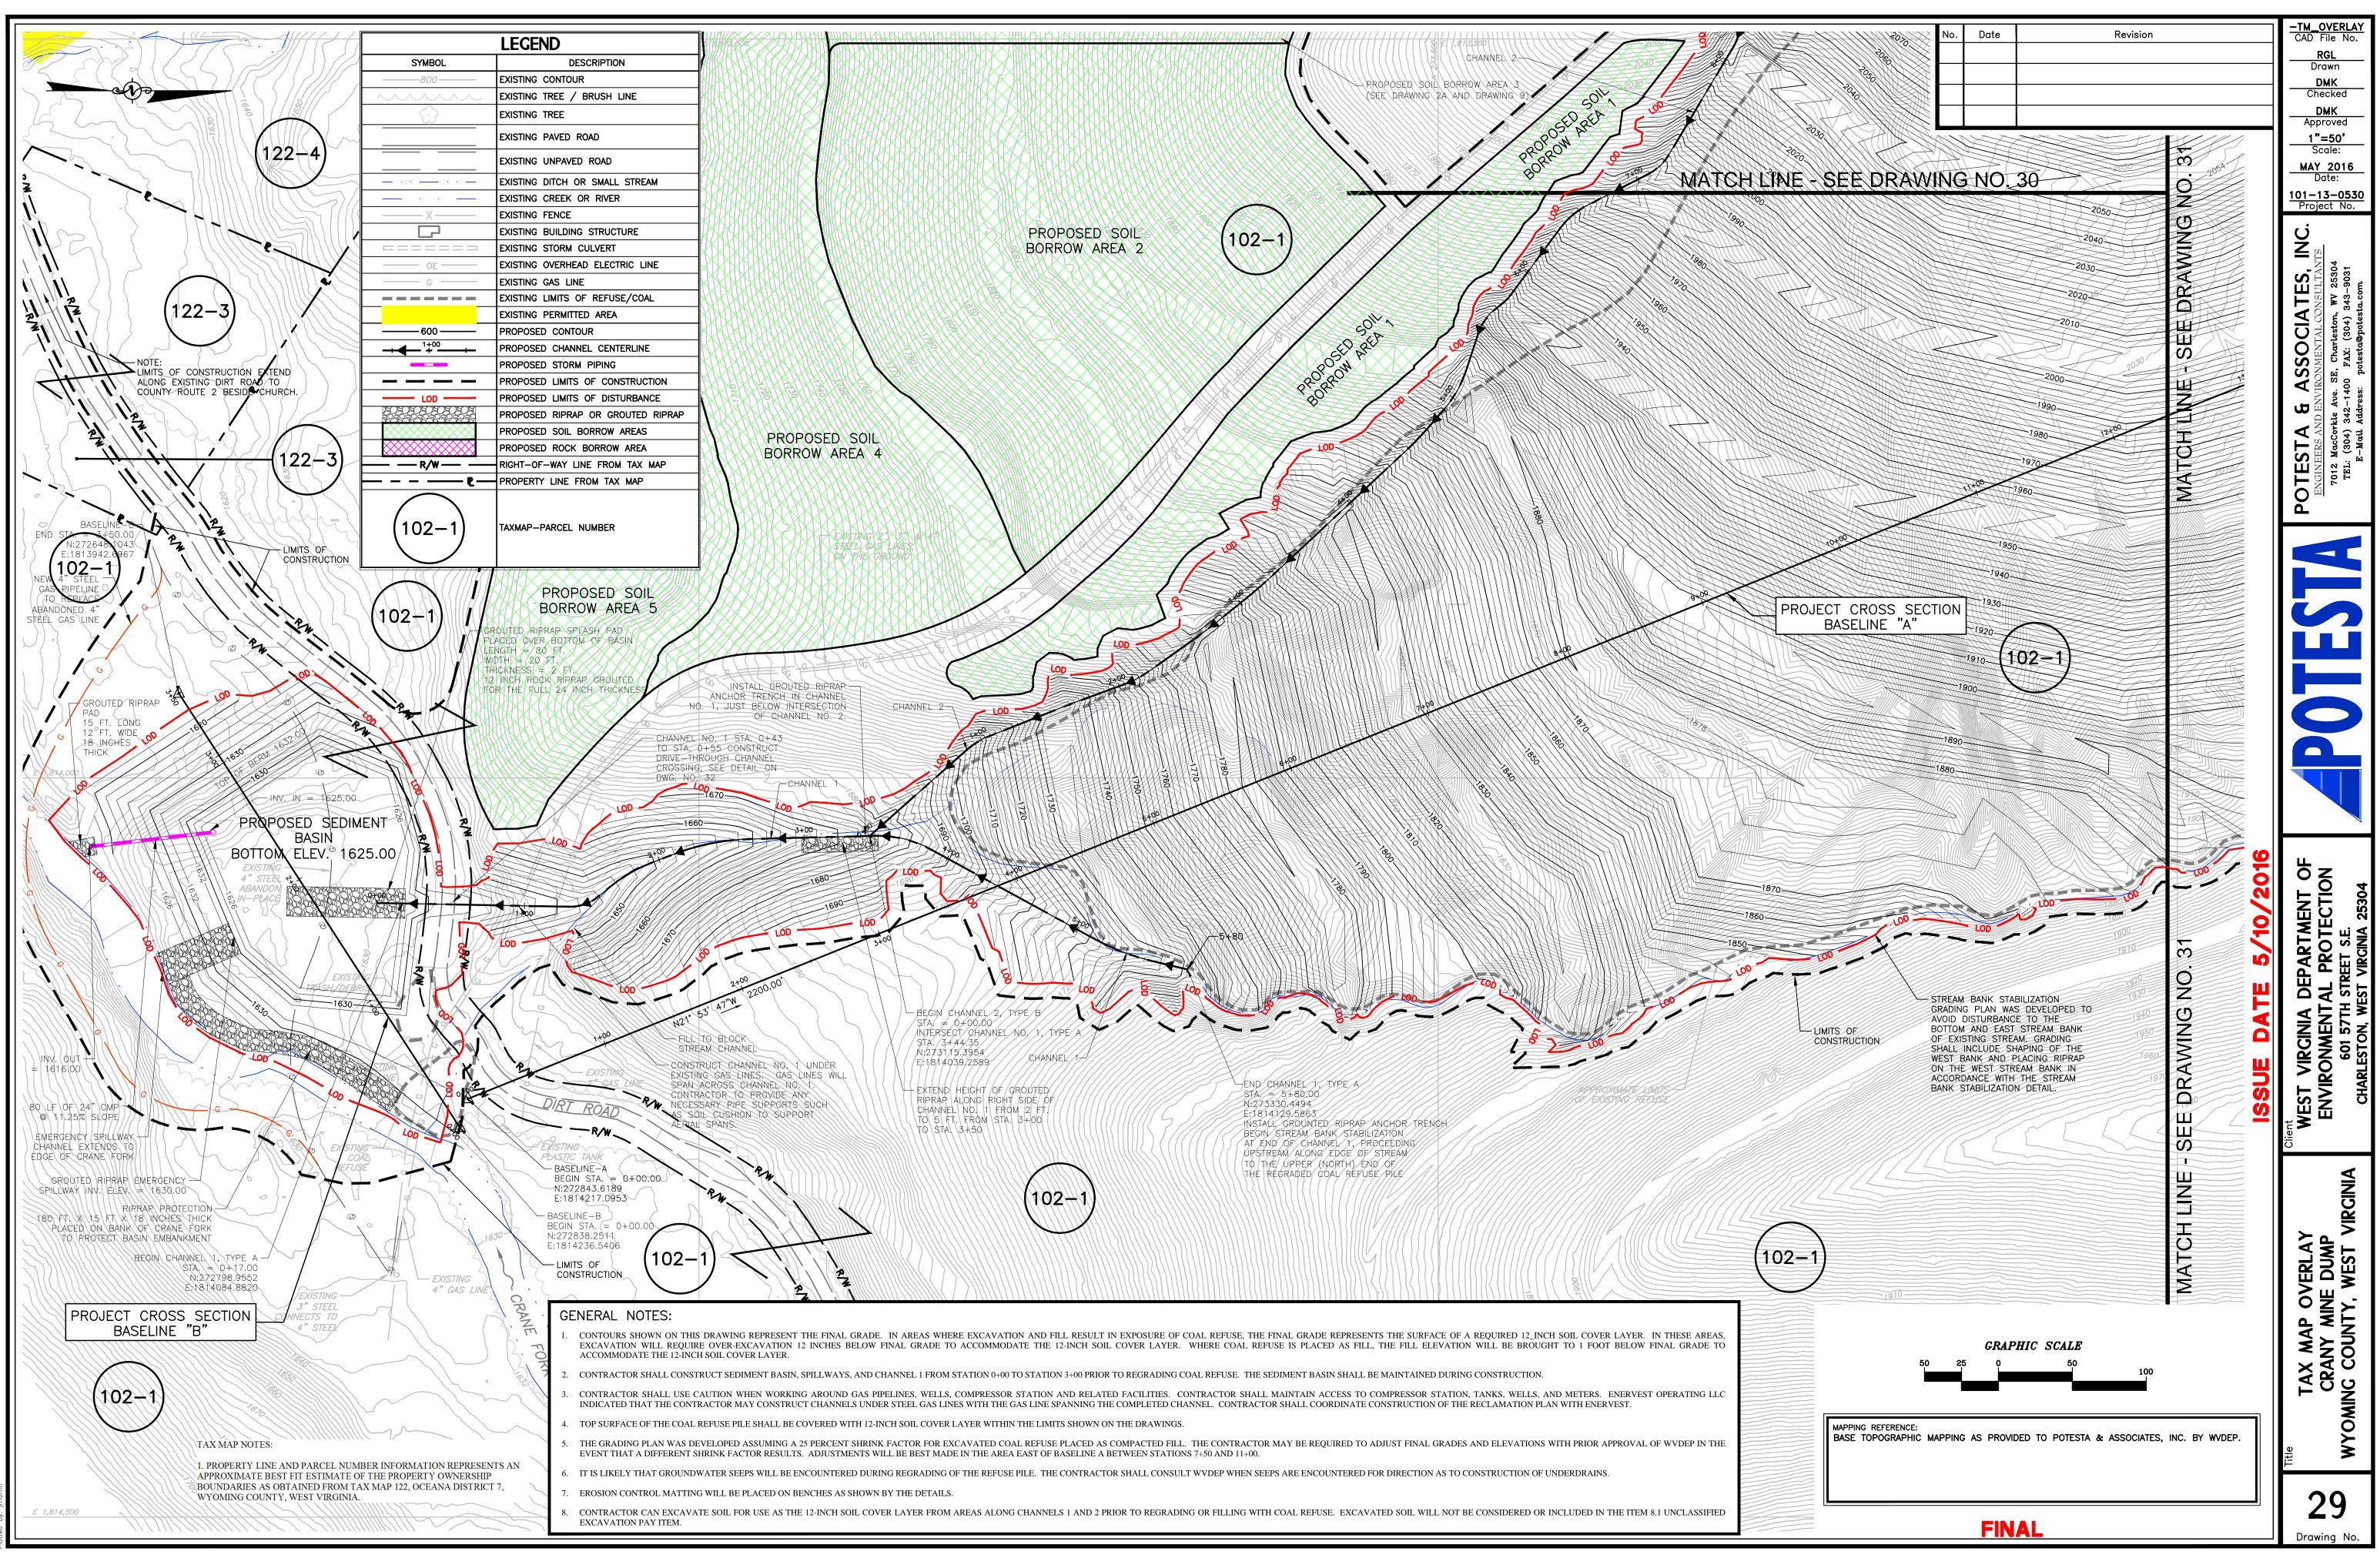

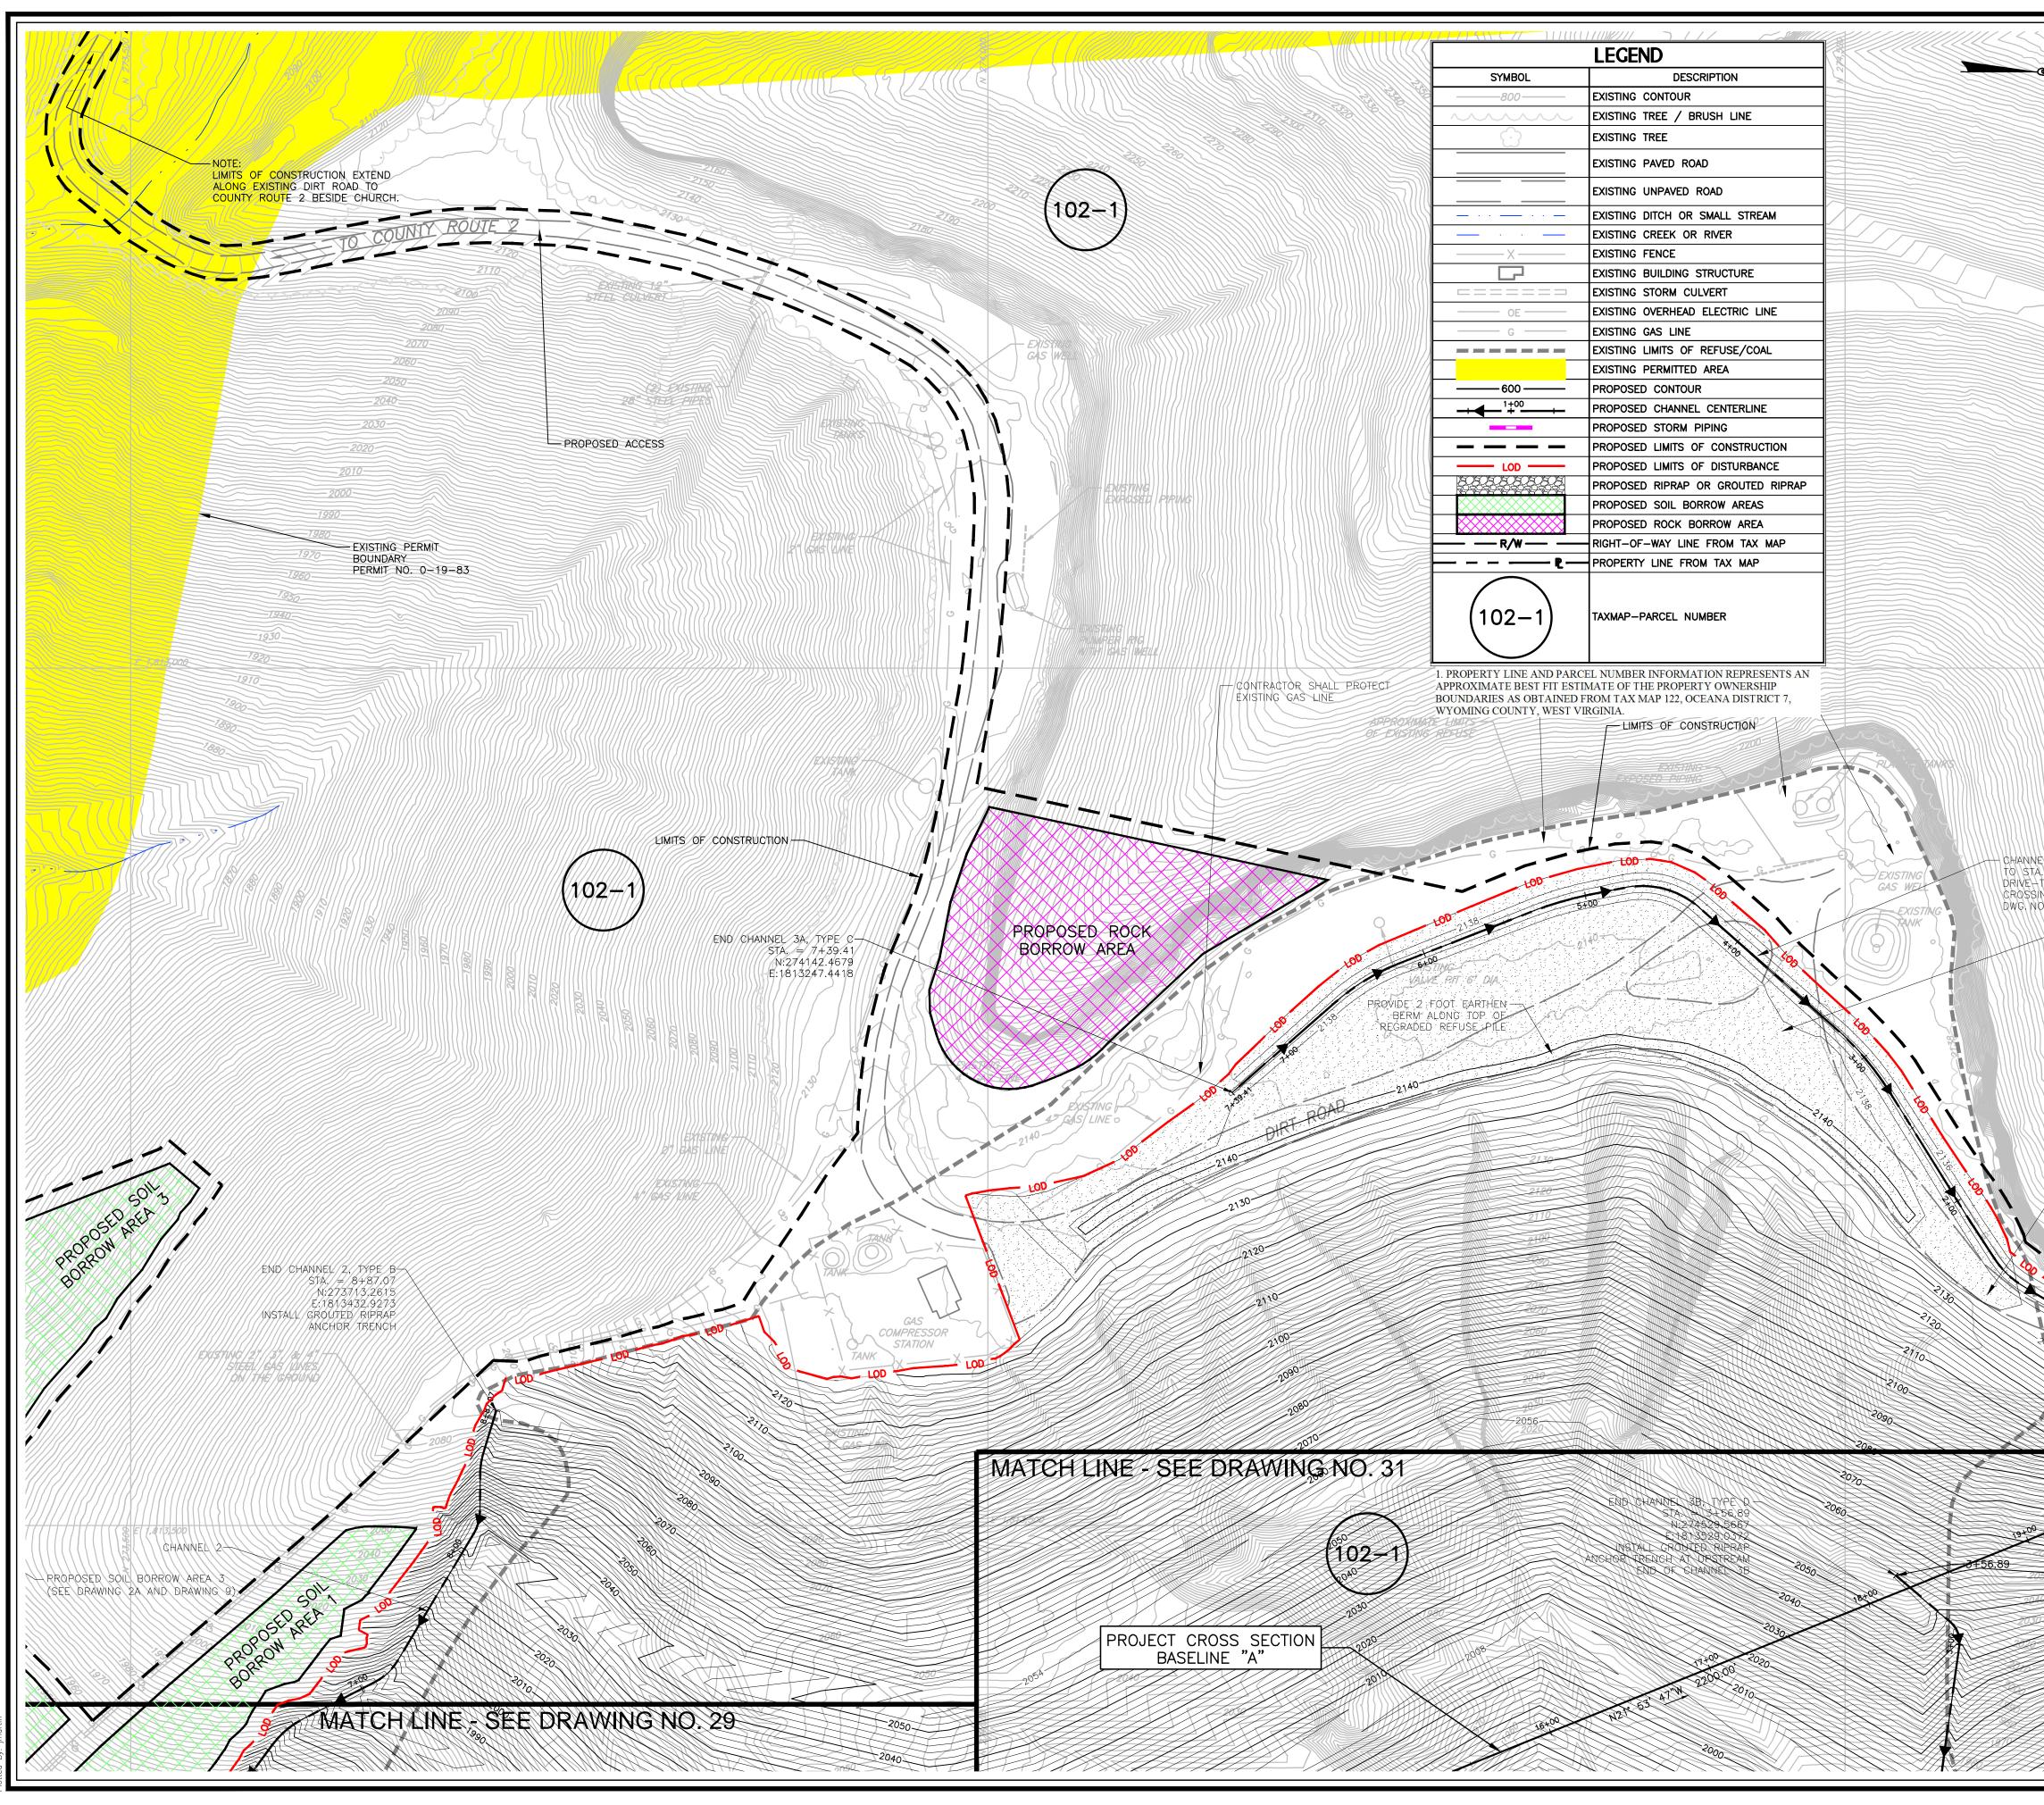


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	No. Date	Revision	-TM_OVERLAY CAD File No.
			RGL Drawn
			DMK Checked DMK
		1	Approved 1"=50'
GE 1.	NERAL NOTE CONTOURS SHOW	<b>TS:</b> IN ON THIS DRAWING REPRESENT THE FINAL GRADE. IN	Scale: <u>MAY 2016</u>
	REFUSE, THE FINA 12_INCH SOIL CO	XCAVATION AND FILL RESULT IN EXPOSURE OF COAL AL GRADE REPRESENTS THE SURFACE OF A REQUIRED OVER LAYER. IN THESE AREAS, EXCAVATION WILL	Date: <u>101–13–0530</u> Project No.
	ACCOMMODATE IS PLACED AS FIL	EXCAVATION 12 INCHES BELOW FINAL GRADE TO THE 12-INCH SOIL COVER LAYER. WHERE COAL REFUSE L, THE FILL ELEVATION WILL BE BROUGHT TO 1 FOOT	с <sup>ј</sup>
2.	LAYER.	RADE TO ACCOMMODATE THE 12-INCH SOIL COVER	NTS ANTS
	CHANNEL 1 FROM	1 STATION 0+00 TO STATION 3+00 PRIOR TO REGRADING THE SEDIMENT BASIN SHALL BE MAINTAINED DURING	ATES, CONSULTAN m, WV 25304 i) 343-9031 esta.com
3.	PIPELINES, WELL	HALL USE CAUTION WHEN WORKING AROUND GAS S, COMPRESSOR STATION AND RELATED FACILITIES.	
	TANKS, WELLS, A THAT THE CONT	AALL MAINTAIN ACCESS TO COMPRESSOR STATION, AND METERS. ENERVEST OPERATING LLC INDICATED RACTOR MAY CONSTRUCT CHANNELS UNDER STEEL	SOCIA MENTAL CC Charleston, FAX: (304) otesta@potes
	CONTRACTOR	THE GAS LINE SPANNING THE COMPLETED CHANNEL. SHALL COORDINATE CONSTRUCTION OF THE LAN WITH ENERVEST.	<b>A AS</b> AVIRON Ave. SE, C-1400 Uress: po
4.		F THE COAL REFUSE PILE SHALL BE COVERED WITH OVER LAYER WITHIN THE LIMITS SHOWN ON THE	ND I rkle 342 Add
5.	FACTOR FOR EXC	AN WAS DEVELOPED ASSUMING A 25 PERCENT SHRINK CAVATED COAL REFUSE PLACED AS COMPACTED FILL.	RS acC 304 Ma
	ELEVATIONS WIT DIFFERENT SHRII	R MAY BE REQUIRED TO ADJUST FINAL GRADES AND H PRIOR APPROVAL OF WVDEP IN THE EVENT THAT A NK FACTOR RESULTS. ADJUSTMENTS WILL BE BEST	POTES ENGINEE 7012 M FEL: (
6	11+00.	EA EAST OF BASELINE A BETWEEN STATIONS 7+50 AND HAT GROUNDWATER SEEPS WILL BE ENCOUNTERED	PC
	DURING REGRAD CONSULT WVDEP	ING OF THE REFUSE PILE. THE CONTRACTOR SHALL WHEN SEEPS ARE ENCOUNTERED FOR DIRECTION AS IN OF UNDERDRAINS.	
7.		DL MATTING WILL BE PLACED ON BENCHES AS SHOWN	
8.	COVER LAYER F	AN EXCAVATE SOIL FOR USE AS THE 12-INCH SOIL ROM AREAS ALONG CHANNELS 1 AND 2 PRIOR TO	ESTA
		FILLING WITH COAL REFUSE. EXCAVATED SOIL WILL ERED OR INCLUDED IN THE ITEM 8.1 UNCLASSIFIED Y ITEM.	ĹĹ
		539 ( ) ) ( ) ( ) ( ) ( ) ( ) ( ) ( ) ( )	0
. NO) 3A STA. 3+50			
3+70 CONSTRUCT HROUGH CHANNEL G, SEE DETAIL ON 32			
COAL REFUSE PILE INCLUDING ROAD SHALL BE COVERED WITH 1 INCHES OF SOIL AND REVEGETATE			~
		2016	ЪХ т
			FMENT OF TECTION .E. IA 25304
			RTM OTE S.E.
			VIRGINIA DEPART CONMENTAL PRO1 601 57TH STREET S.E RLESTON, WEST VIRGINI
MAINTAIN ACCESS ALONG E. ROAD, UPON COMPLETION ( DECALMATION & 15 FOOT	)F	BASELINE - A END STA. = 22+00:00 N:274884.9097	A DE ITAL TH ST WEST
RECLAMATION, A 15-FOOT ACCESS WAY SHALL REMAIN	₩1DE		CINIA MENT, MENT, S7TH FON, WE
CHANNEL 3A		E:1813396.6492	ST VIRGIN IVIRONME 601 57 CHARLESTON
	/ N:2747	EL 3A, TYPE C 0+00.00 35.0431 395.7808	MEST VIRGINIA ENVIRONMEN1 601 5771 CHARLESTON, W
1+00 LOD		YERSILLE WATER LINE	<b>B</b> <b>B</b>
100 - 100 -	7	22,00	
		and the second s	/IRCINIA
MAINTAIN AC	0200	1400 DIRT ROAD	<ul><li></li><li></li><li></li><li></li><li></li><li></li><li></li><li></li><li></li><li></li><li></li><li></li><li></li><li></li><li></li><li></li><li></li><li></li><li></li><li></li><li></li><li></li><li></li><li></li><li></li><li></li><li></li><li></li><li></li><li></li><li></li><li></li></ul>
AMATC	HUNE -	SEE DRAWING NO. 31	RLA NUMI EST
		OLL DRAWING NO. 01	P OVERLAY MINE DUMP VTY, WEST V
50	<b>GRAP</b> 25 о	50	TAX MAP CRANY M IG COUNT
		100	NG CR
MAPPING REFERENCE:			<sup>itle</sup> TA CF WYOMING
BASE TOPOGRAPHIC M	APPING AS PROVII	DED TO POTESTA & ASSOCIATES, INC. BY WVDEP.	Title WY
	FIN	J	30
			Drawing No.

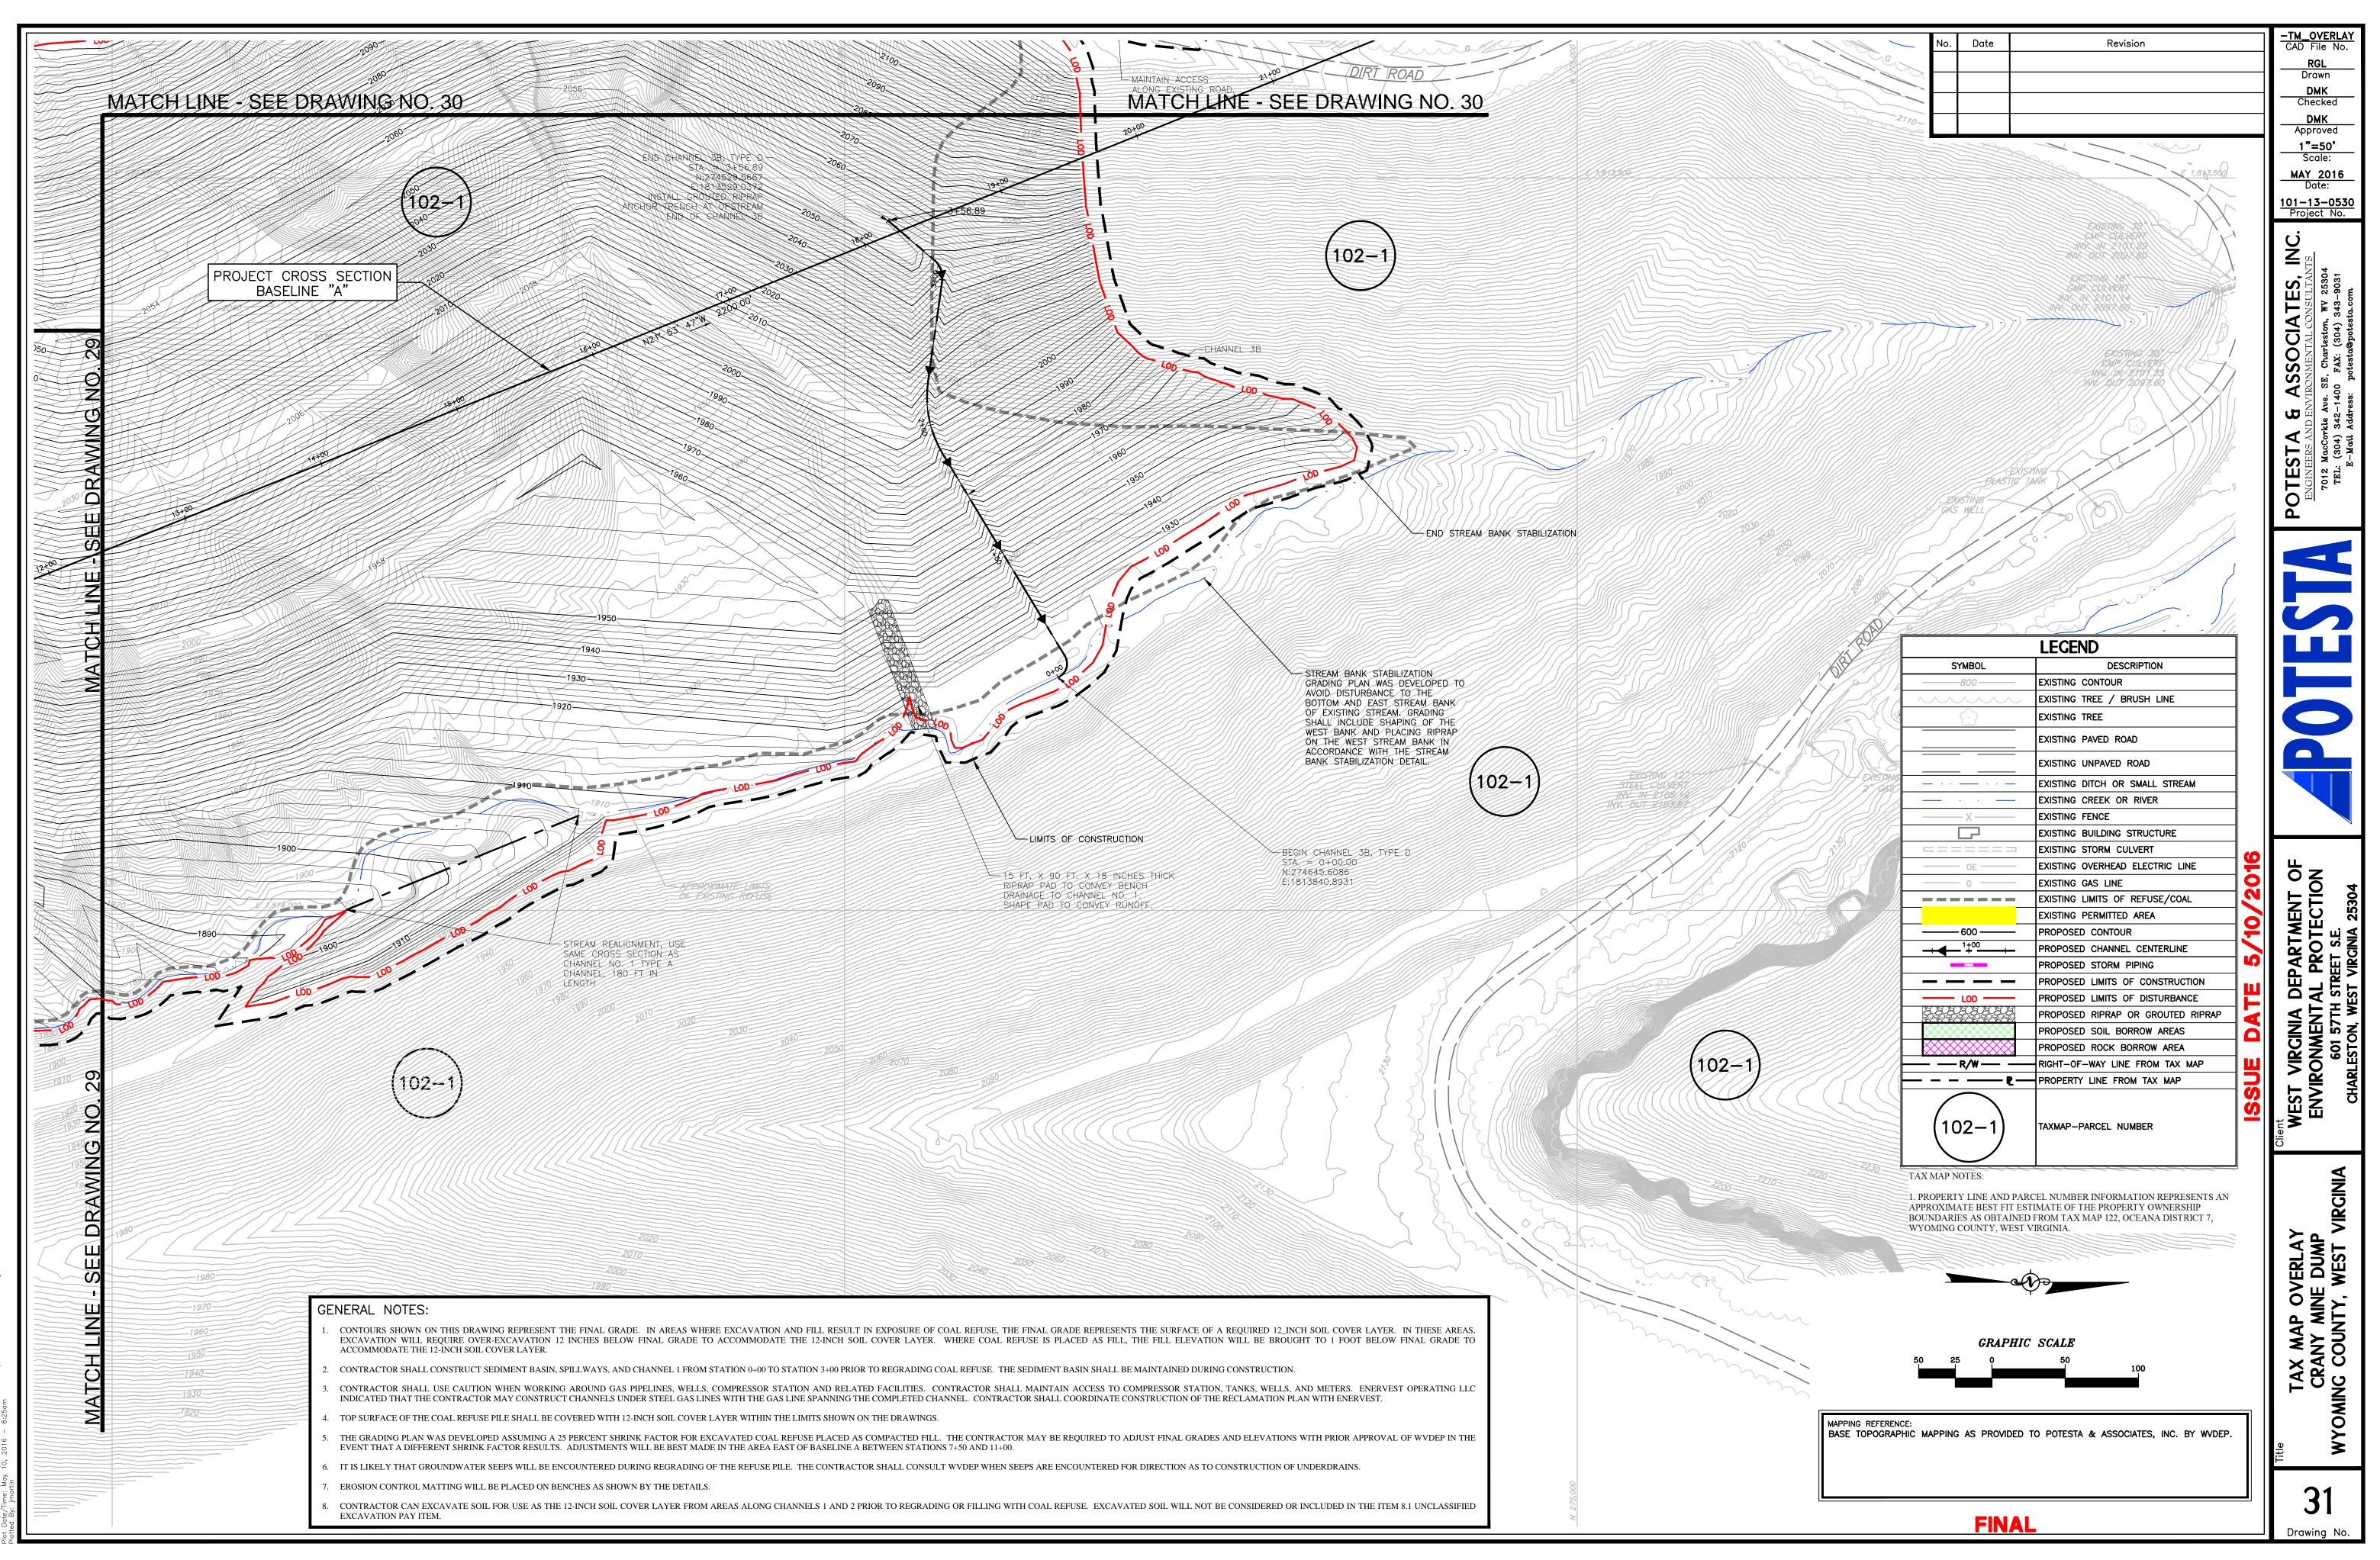


:s: 13–0530\_REC PLAN 13–0530\_EXISTING REC-LEGEND EXIST-LEGEND GOOGLE IMAGE BW EXIST-PERMIT MAP TAXMAP-LEGEND SOIL-LEGE es: TM 122 DISTRICT 7.tif GEI84BA.jpg 33D-Proi-YR\2013\13-0530-AML-CRAMY\13-0530-TM\_OVERLAY.dwg

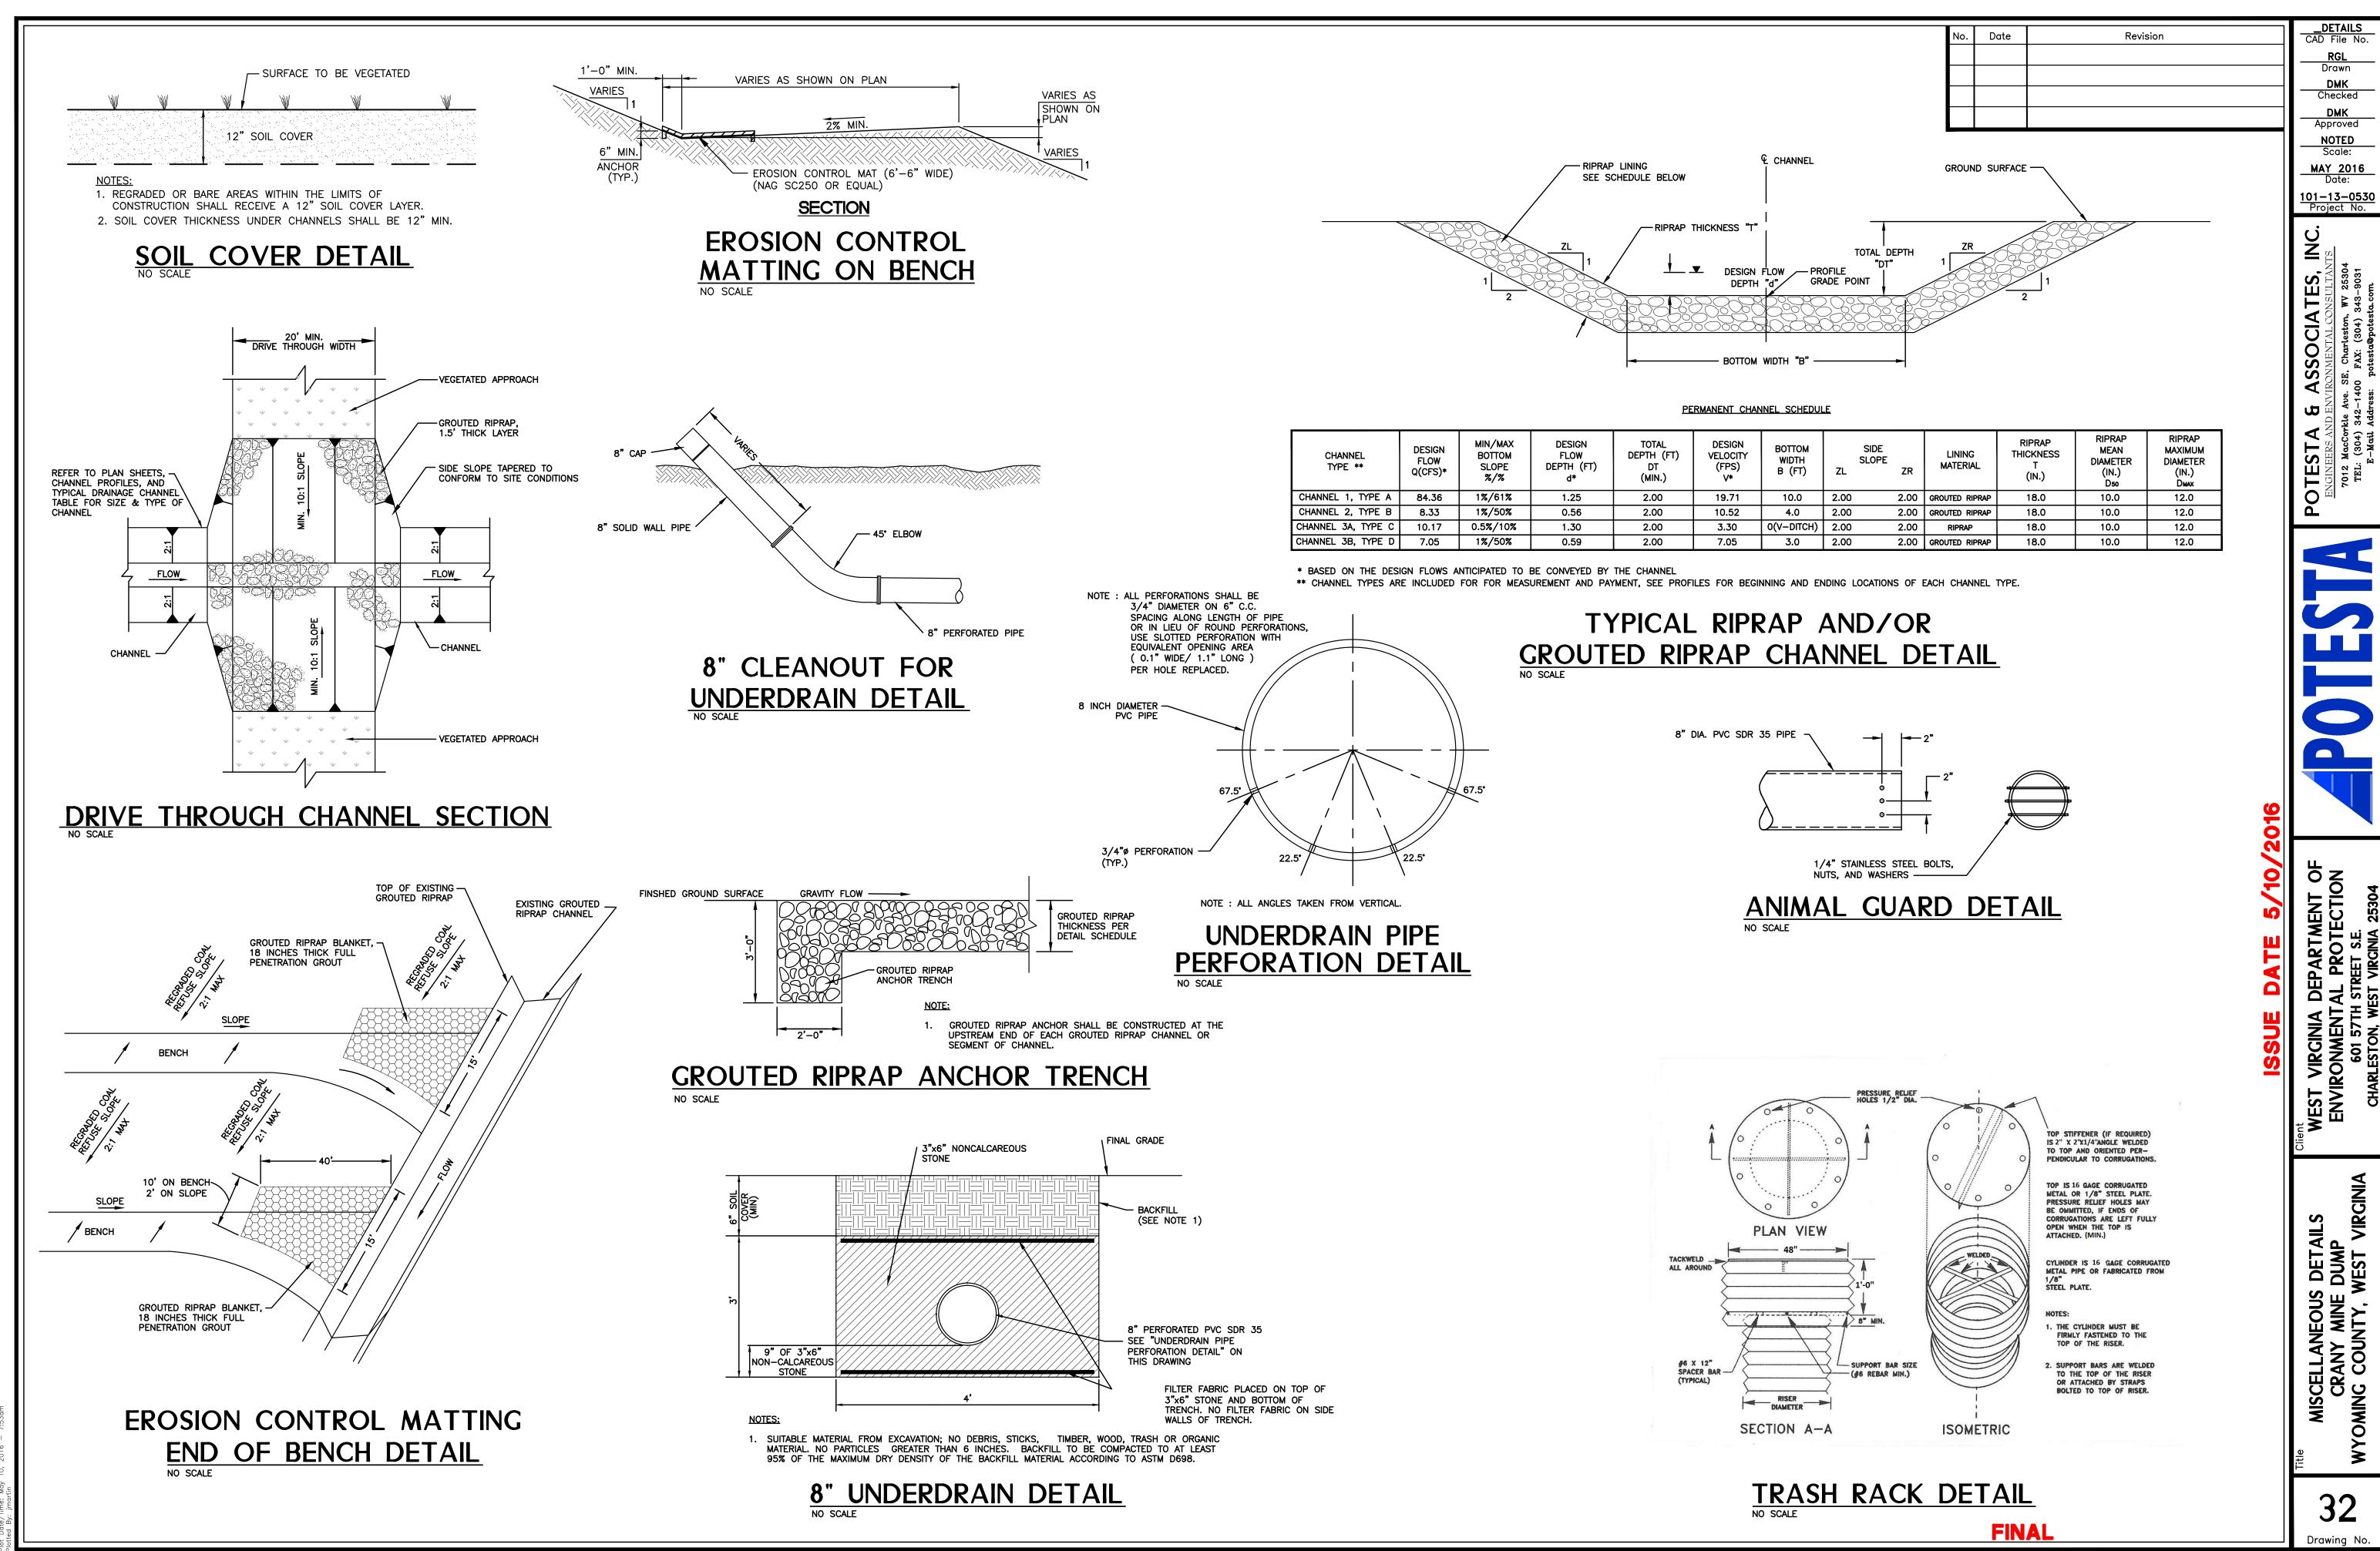


BOTTOM WIDTH B (FT)		ide Ope Zr	LINING MATERIAL	RIPRAP THICKNESS T (IN.)	RIPRAP MEAN DIAMETER (IN.) D50	RIPRAP MAXIMUM DIAMETER (IN.) Dmax
10.0	2.00	2.00	GROUTED RIPRAP	18.0	10.0	12.0
4.0	2.00	2.00	GROUTED RIPRAP	18.0	10.0	12.0
0(V-DITCH)	2.00	2.00	RIPRAP	18.0	10.0	12.0
3.0	2.00	2.00	GROUTED RIPRAP	18.0	10.0	12.0


### STABILIZED CONSTRUCTION ENTRANCE DETAIL NO SCALE


TEMPORARY STONE CONSTRUCTION ENTRANCES TO BE INSTALLED WHERE CONSTRUCTION ACCESS ROADS ADJOIN EXISTING PAVED PUBLIC ROADWAYS.

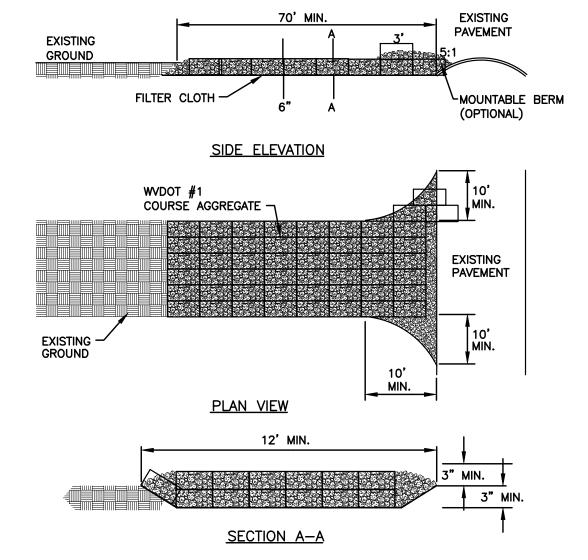


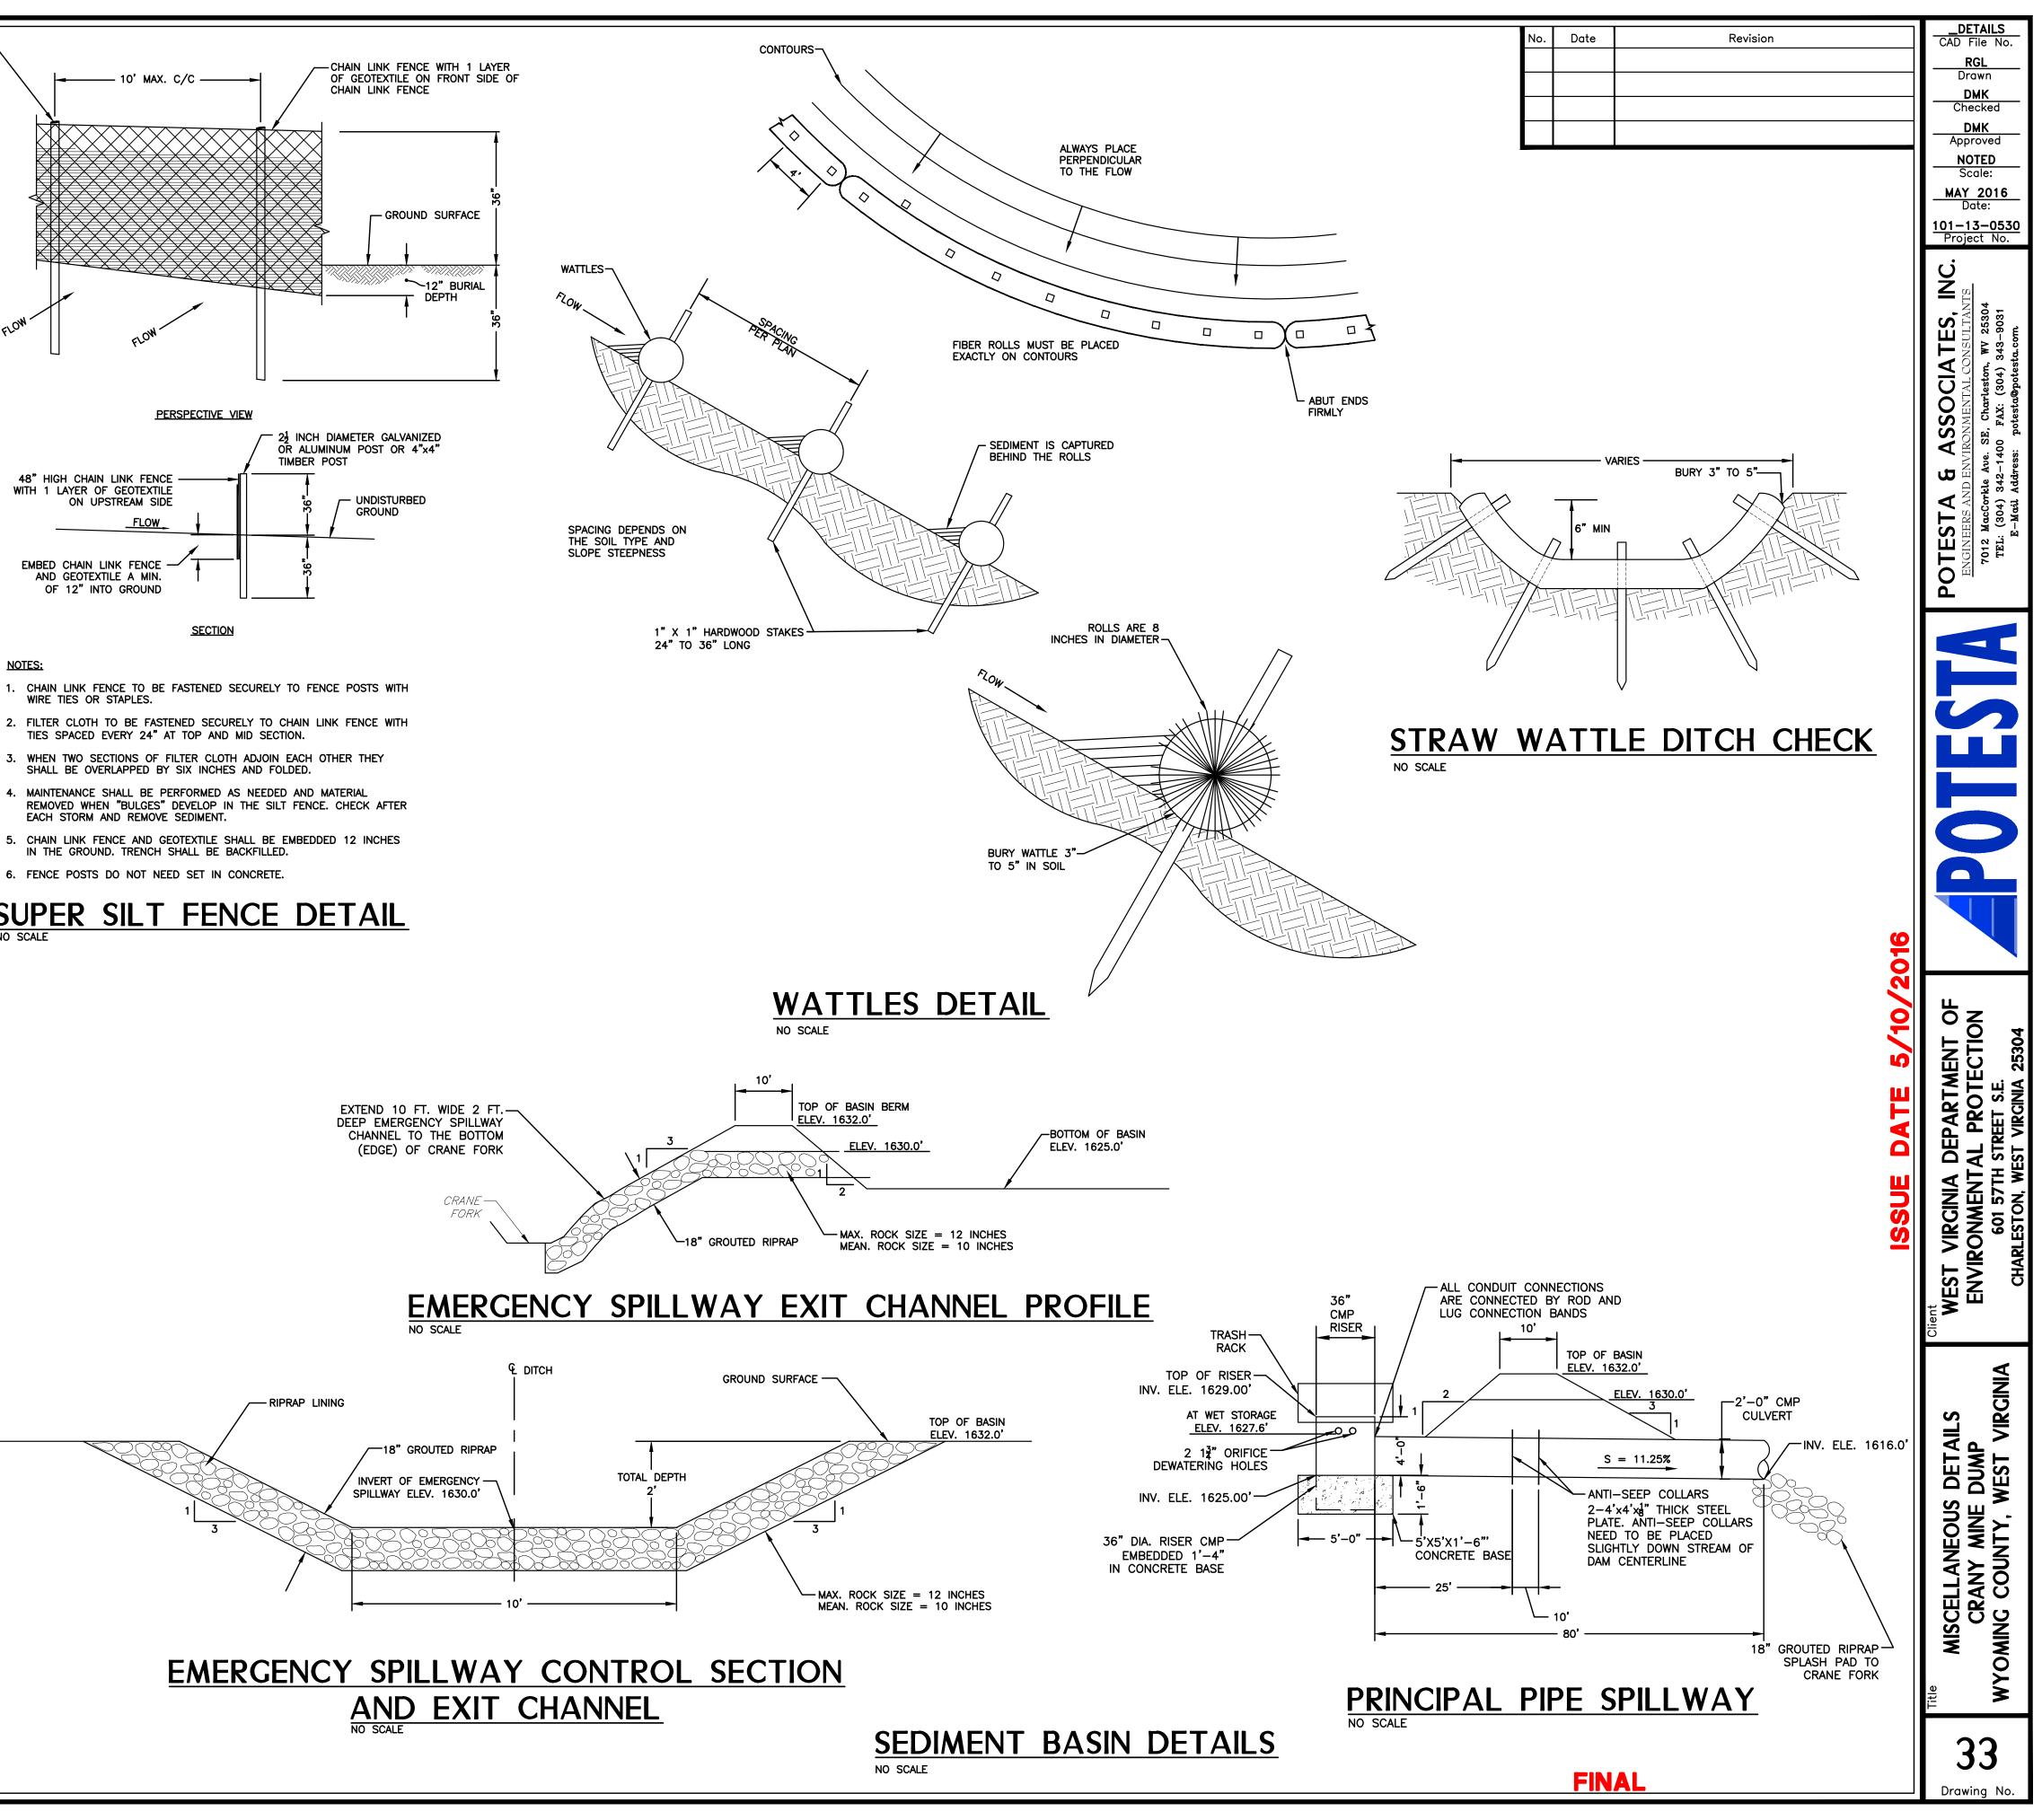



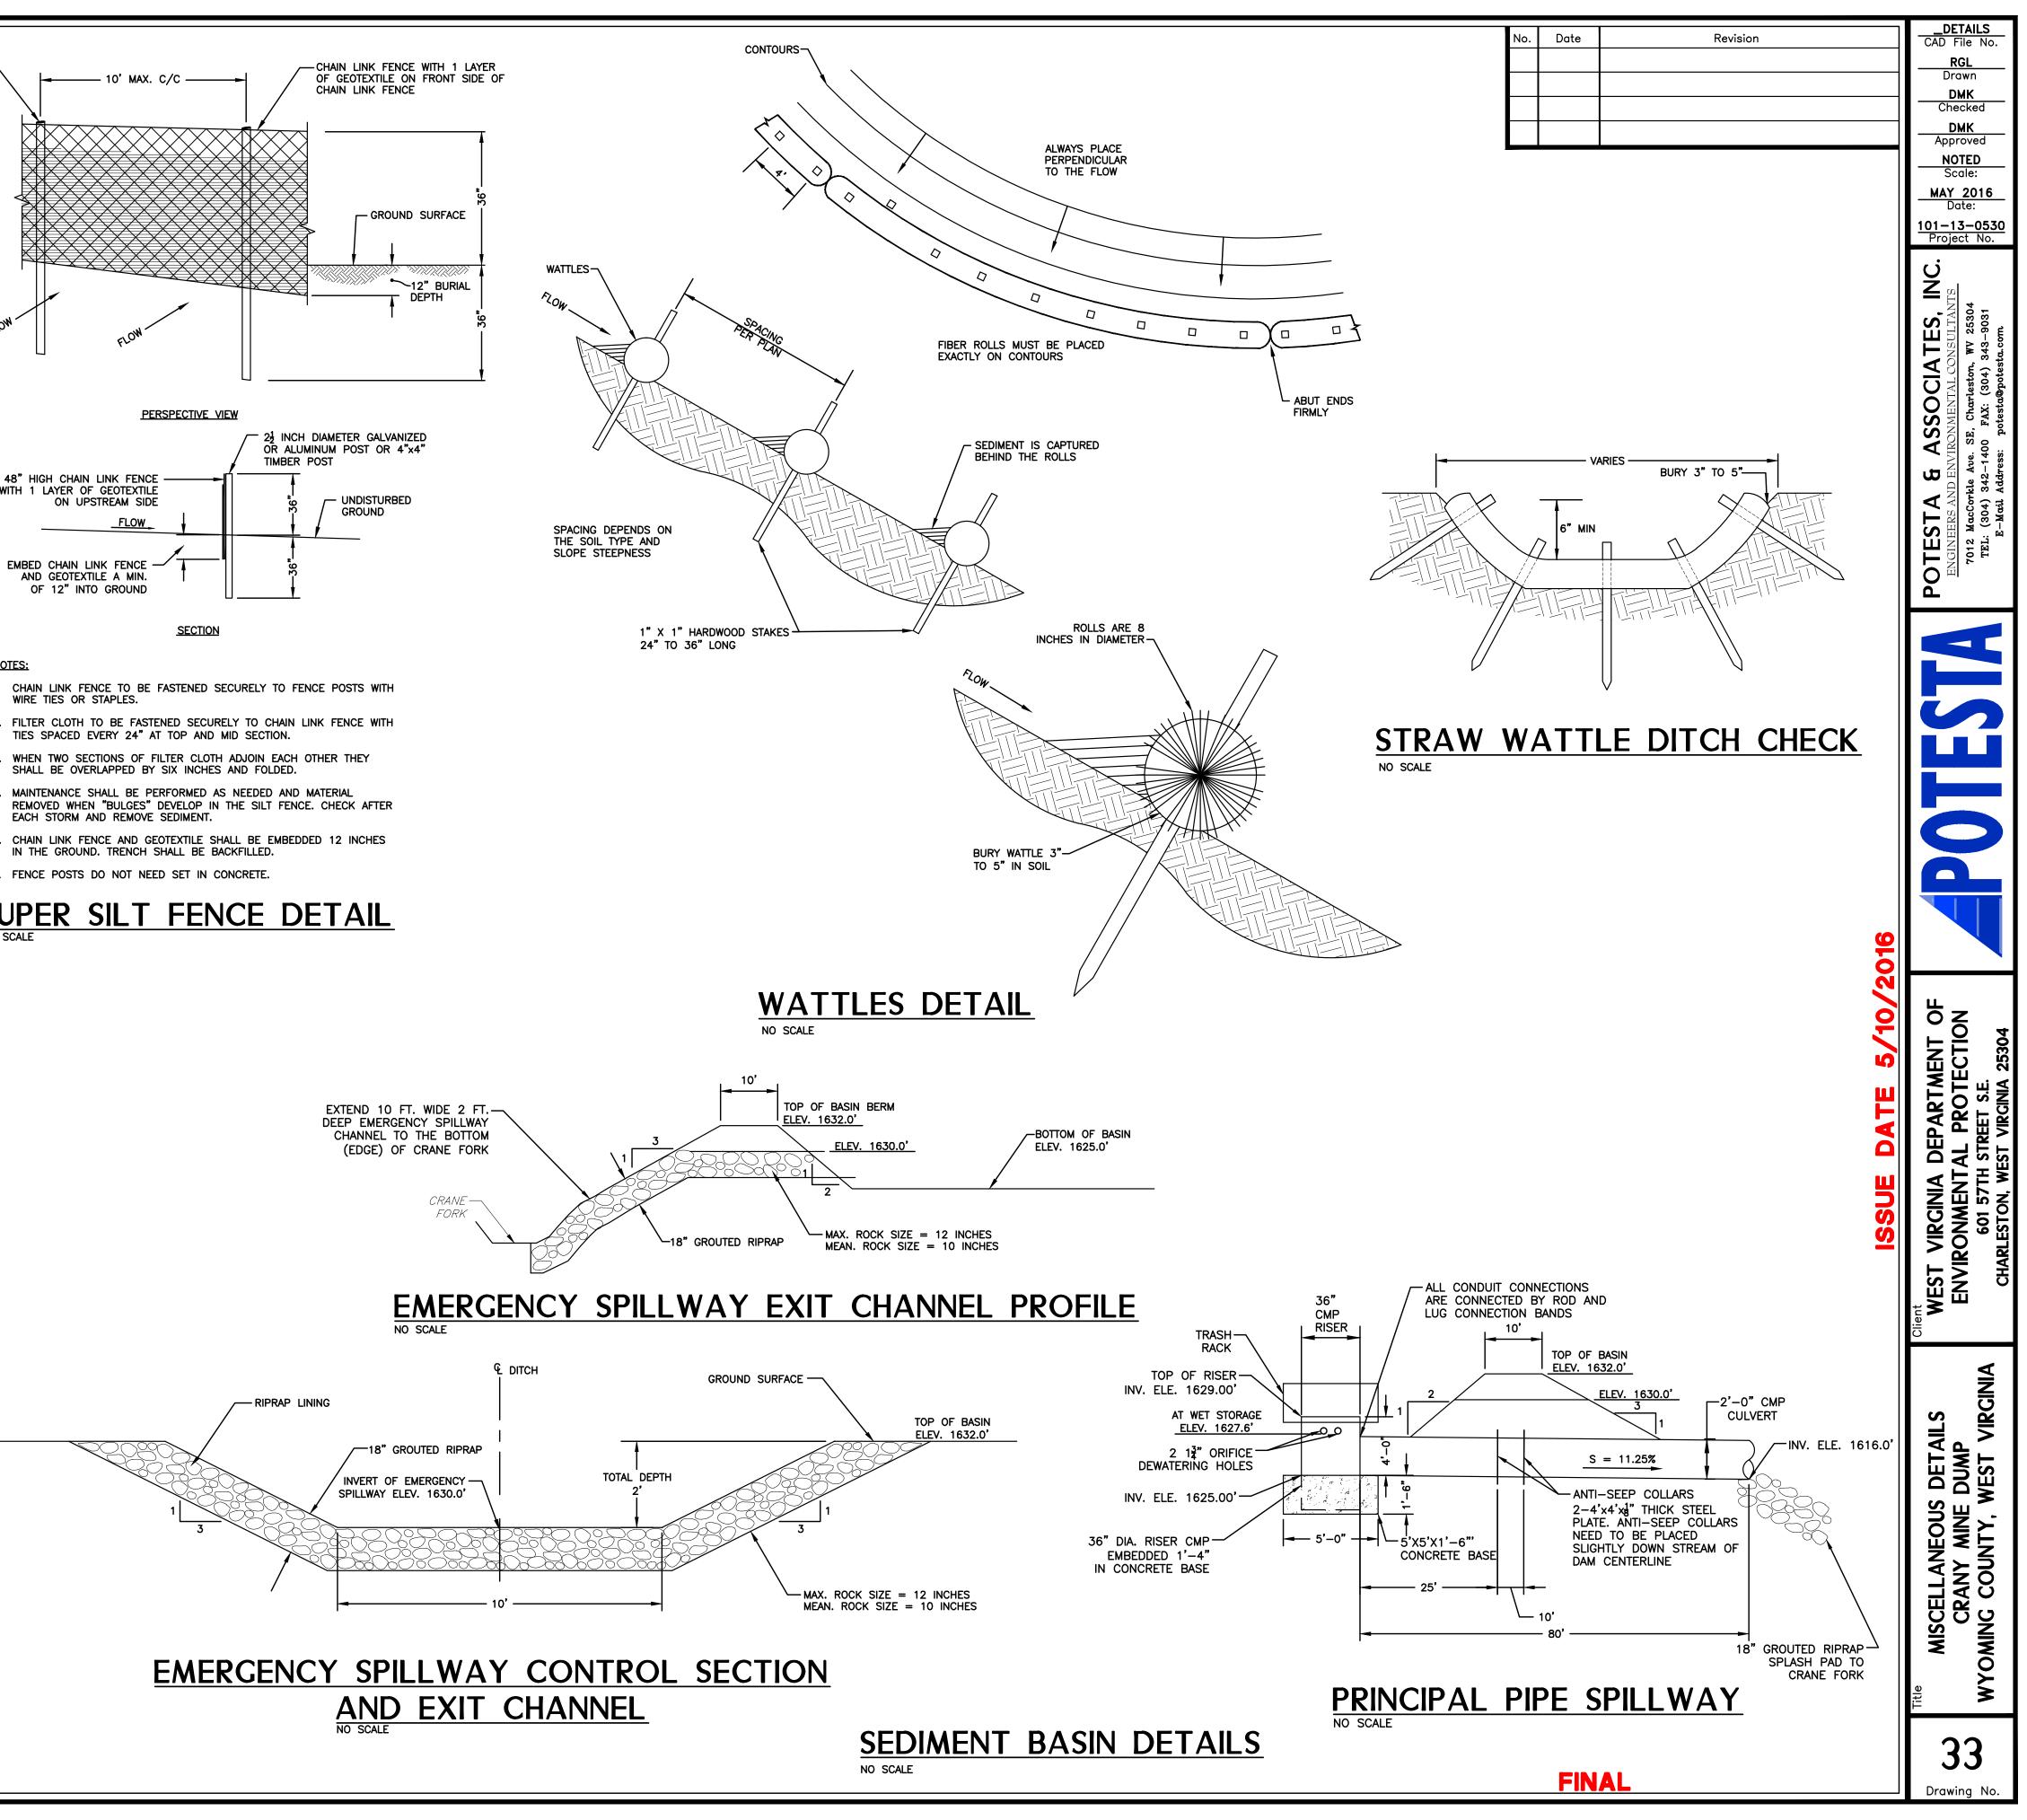


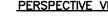


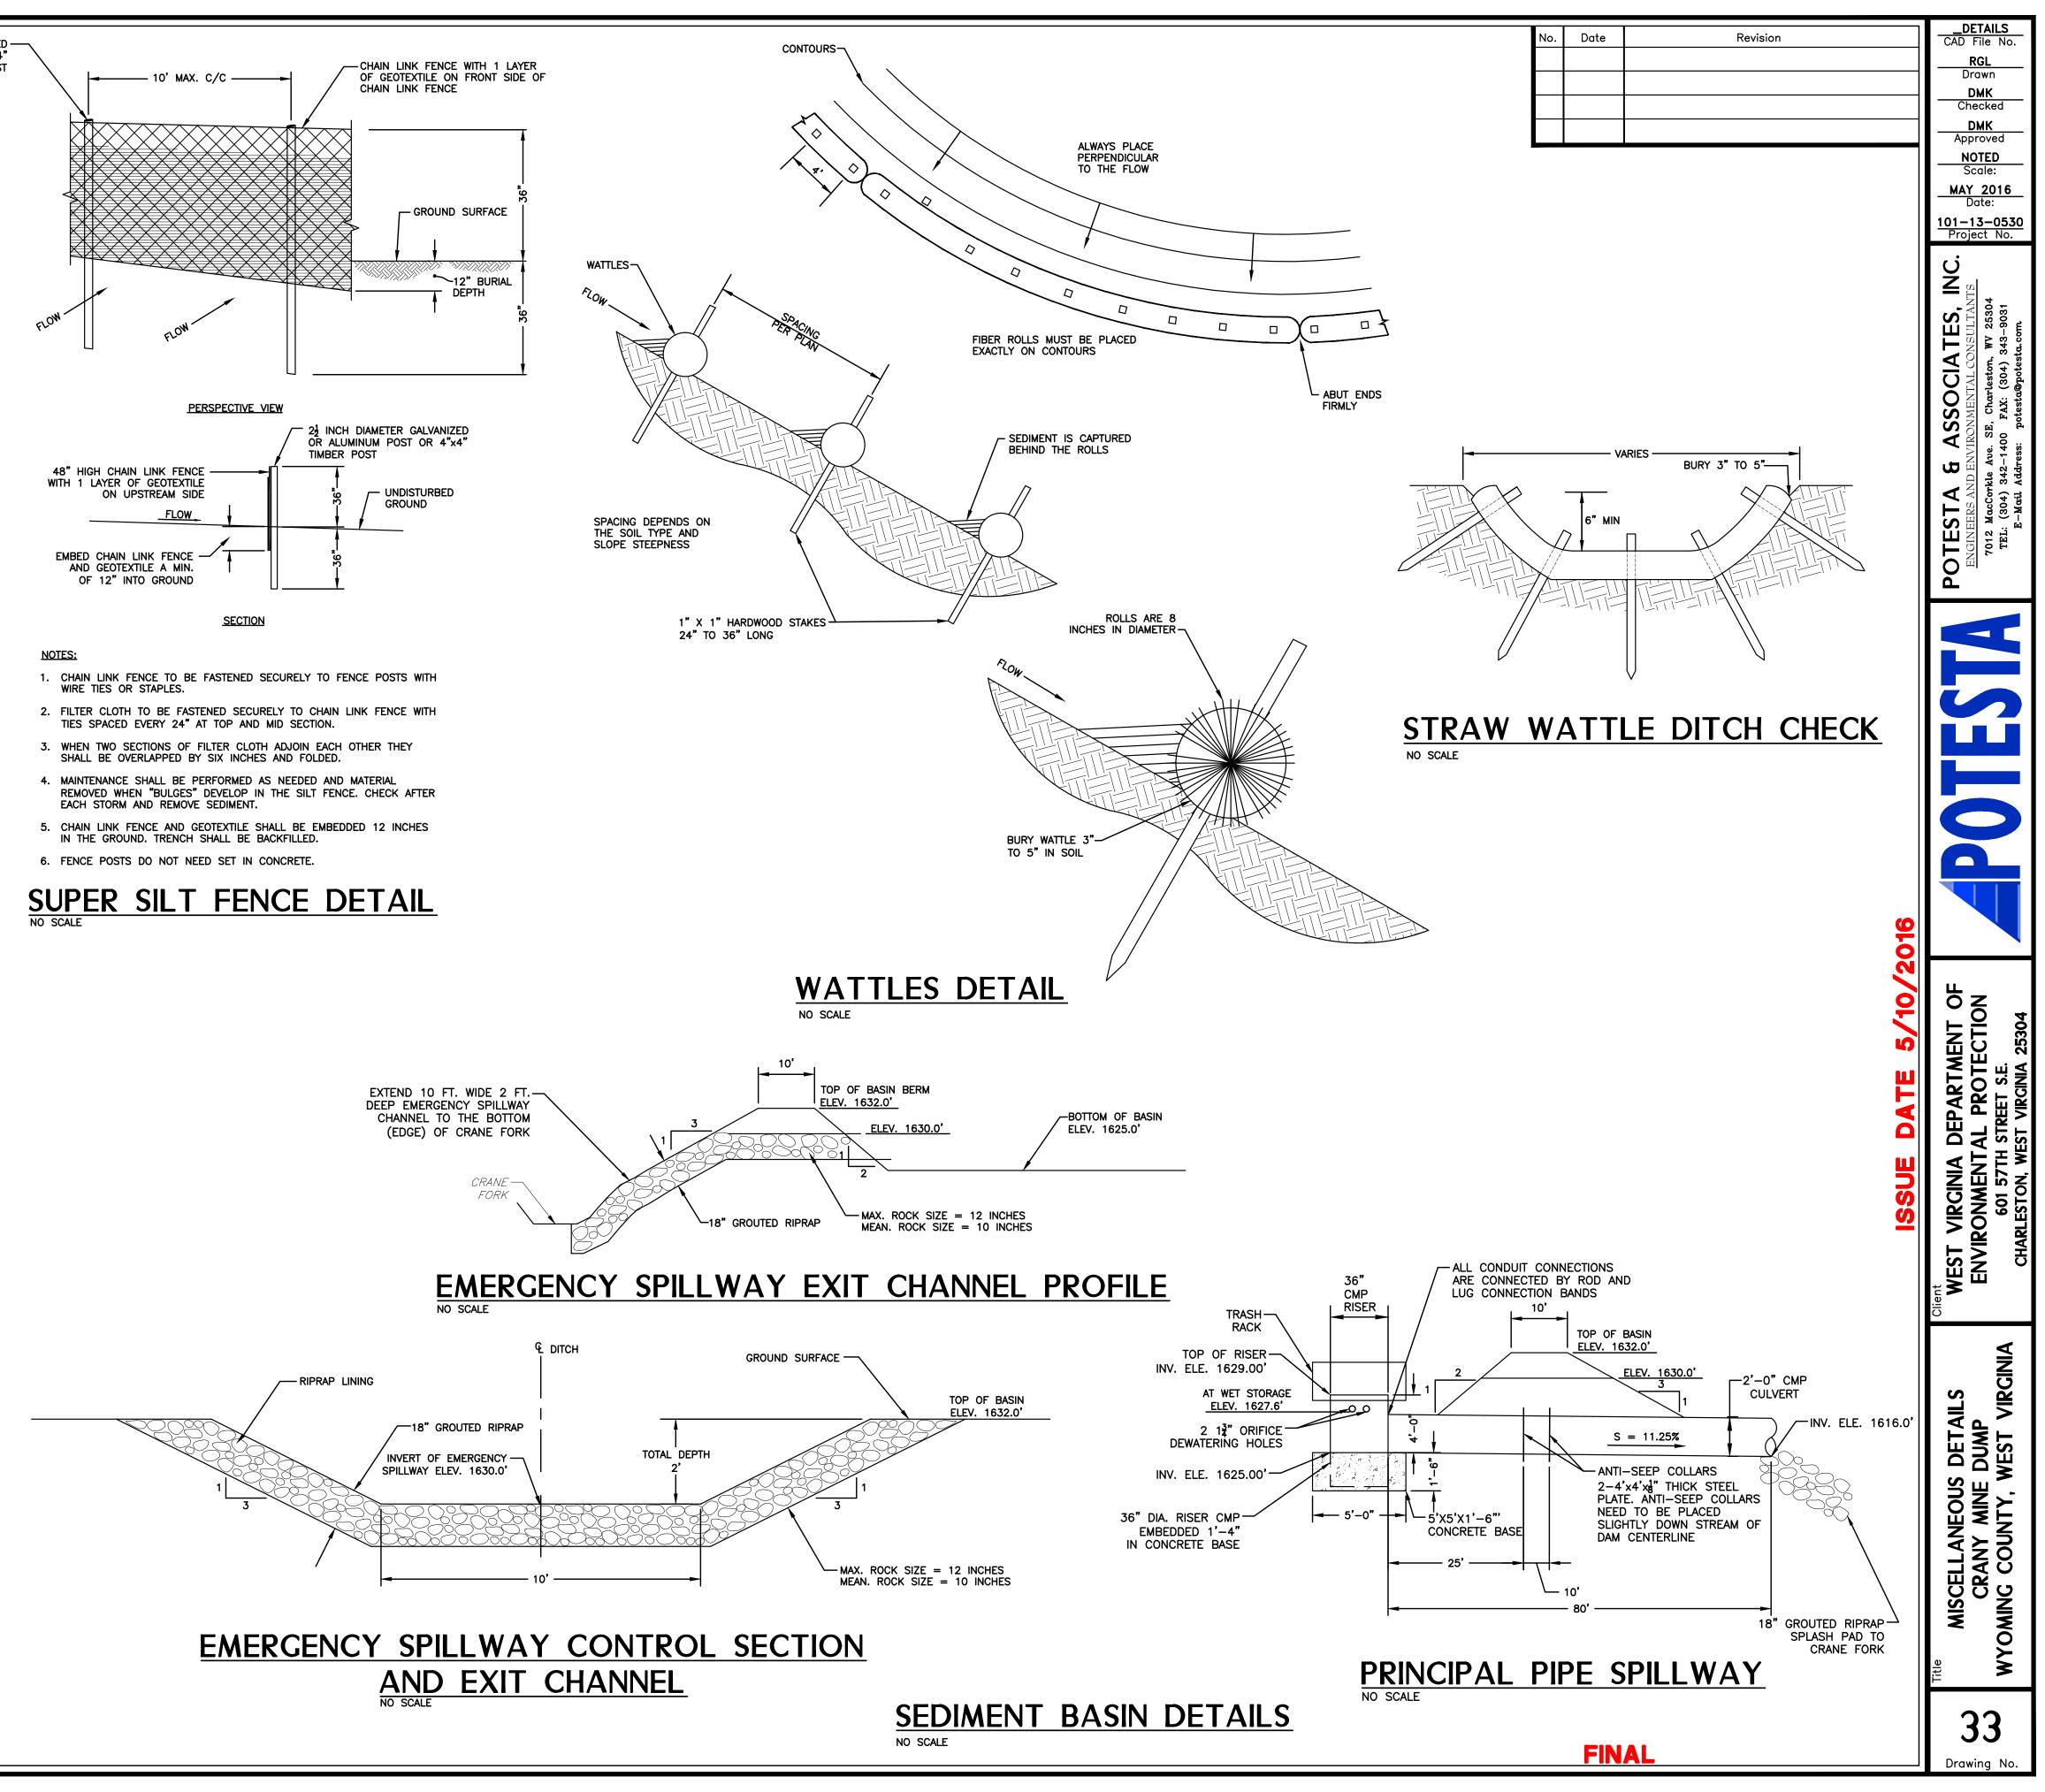


## SILT FENCE DETAIL NO SCALE

- 5. ALL SILT FENCE SHALL BE CHECKED AFTER ANY SIGNIFICANT RAINFALL (IN EXCESS OF 1/2"). DAMAGED SILT FENCE MUST BE REPAIRED WITHIN 24 HOURS; SOONER, IF ADDITIONAL RAINFALL IS EXPECTED.
- 4. FILTER CLOTH SHALL BE "FILTER X", "MIRAFI 100X", "LINQ GTF 180" OR APPROVED EQUAL.
- 3. POSTS SHALL BE CONSTRUCTED OF STEEL EITHER "T" OR "U" TYPE OR 1.5" HARDWOOD.
- MAINTENANCE SHALL BE PERFORMED AS NEEDED AND MATERIAL REMOVED WHEN "BULGES" DEVELOP IN THE SILT FENCE, OR WHEN HALF OF EXPOSED SILT FENCE IS COVERED WITH SEDIMENT.
- 1. WHEN TWO SECTIONS OF SILT FENCE JOIN, OVERLAP ACCORDING TO MANUFACTURERS PUBLISHED RECOMMENDATIONS.

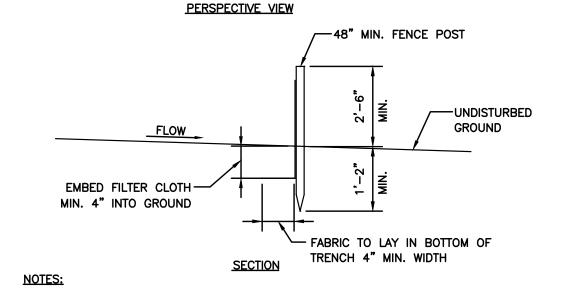


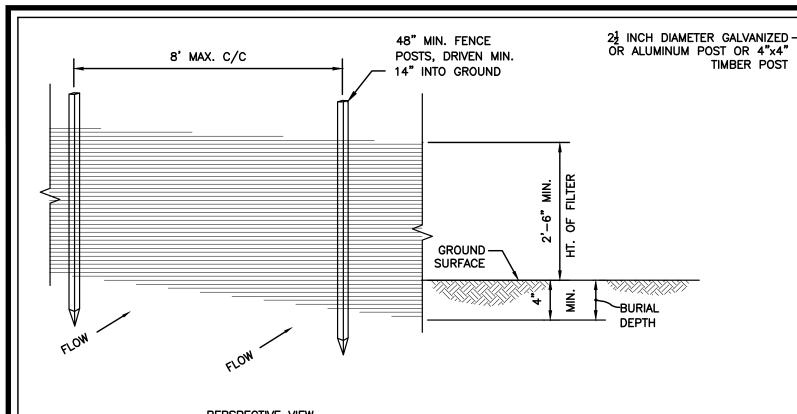

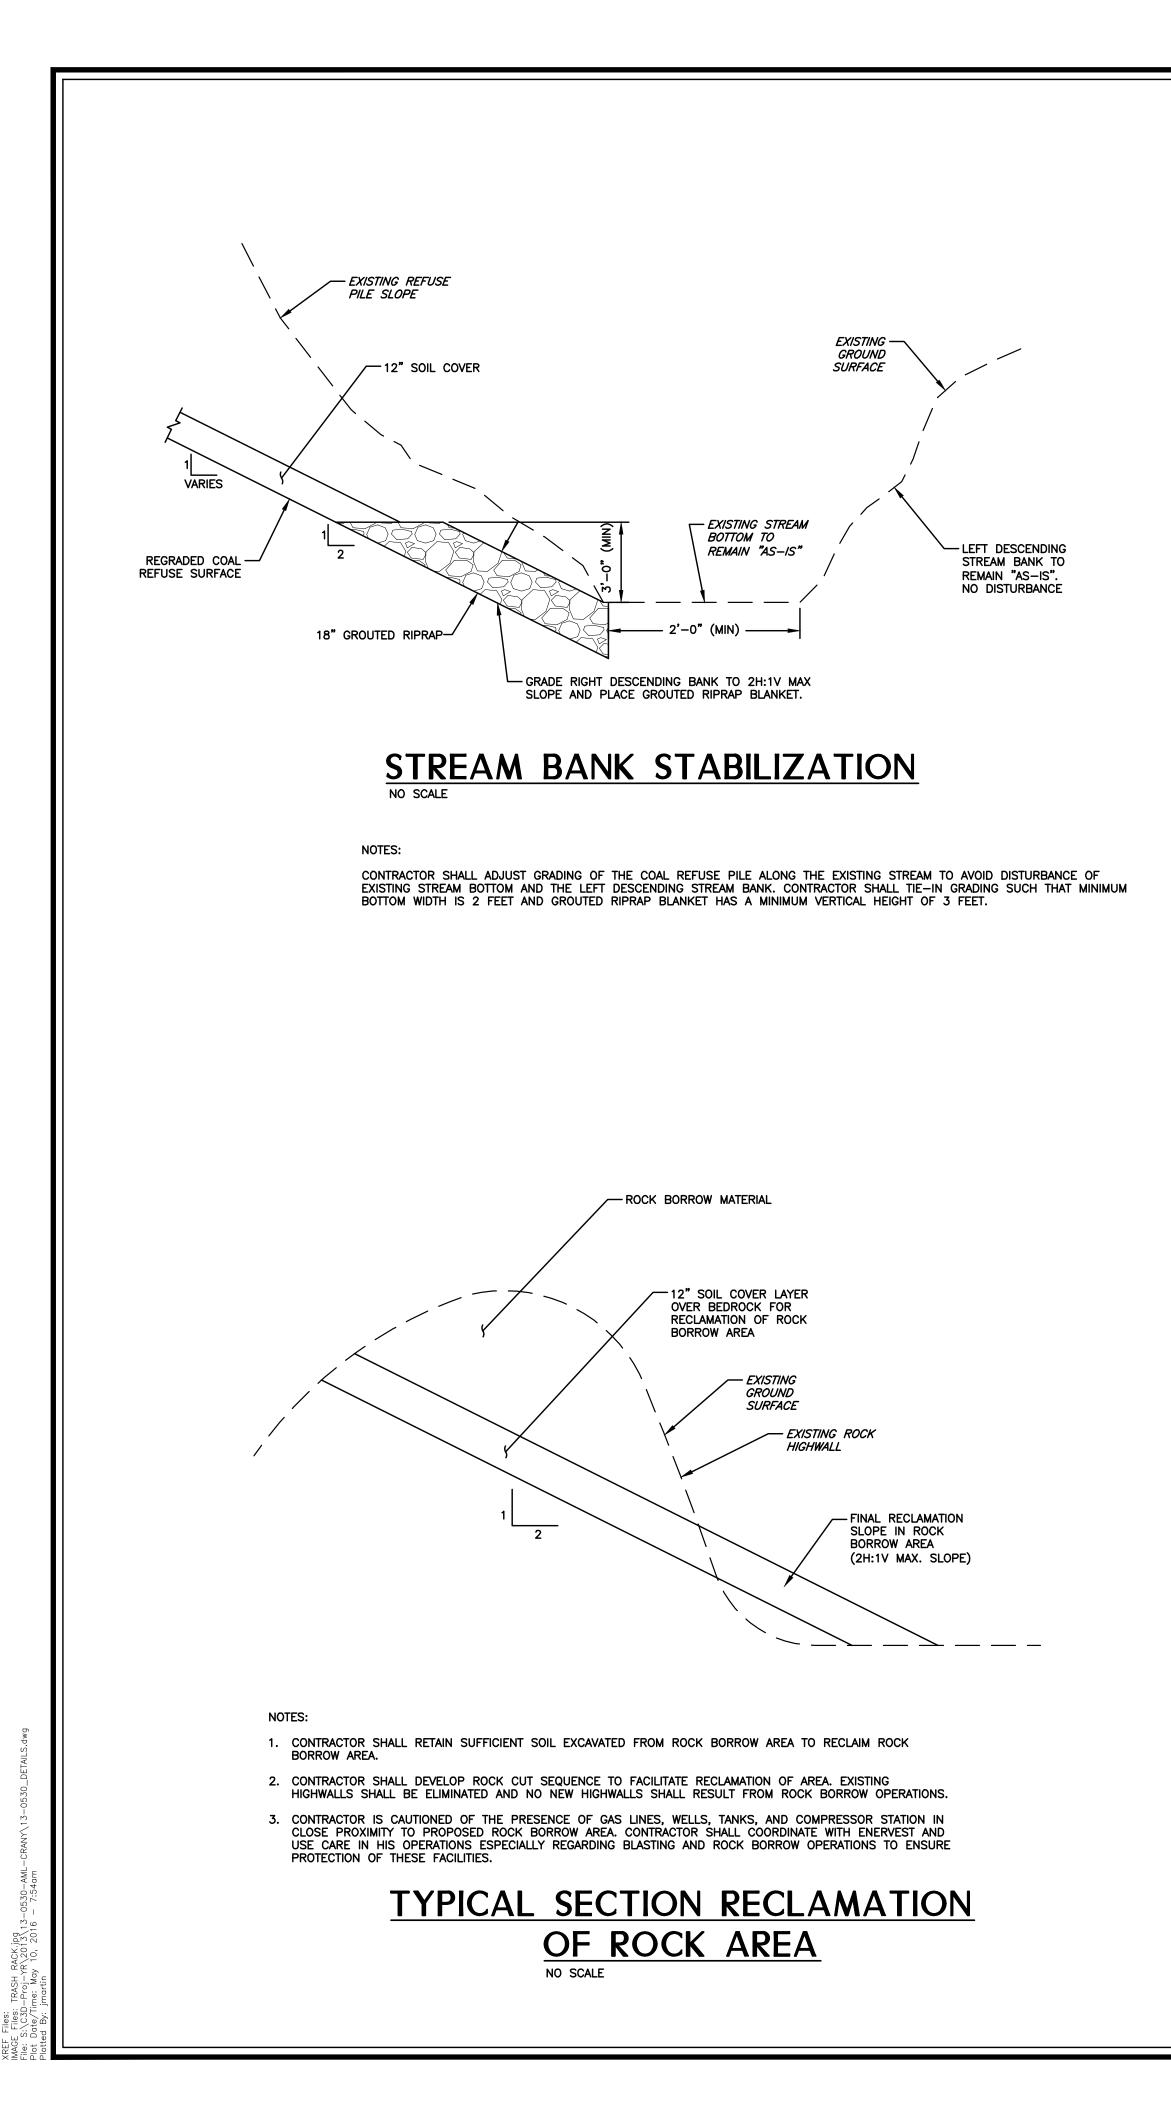

# TYPICAL EARTHEN BERM

2'-0"

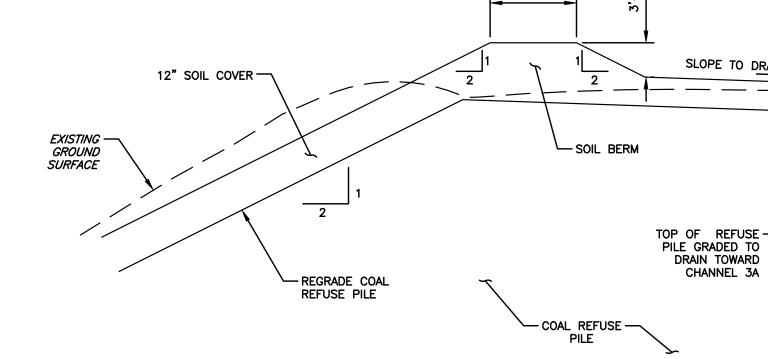

No.	Date	Revision	DETAILS CAD File No. RGL
			Drawn DMK Checked
			DMK Approved
			NOTED Scale: MAY 2016 Date:
			Date: <u>101-13-0530</u> Project No.
			<b>3, INC.</b> ANTS <sup>304</sup> <sup>31</sup>
			<b>DTESTA &amp; ASSOCIATES, IN</b> ENGINEERS AND ENVIRONMENTAL CONSULTANTS 7012 MacCorkle Ave. SE, Charleston, WV 25304 TEL: (304) 342-1400 FAX: (304) 343-9031 E-Mail Address: potesta@potesta.com
			ASSO( RONMENTA SE, Charle 00 FAX: (3
			<b>A B A</b> <u>S AND ENVIRC</u> corkle Ave. S: 04) 342–1400 fail Address:
			POTESTA ENGINEERS AN 7012 MacCorl TEL: (304) E-Mail
			P
		0	
		10/2016	
		5/10	IENT OF ECTION 25304
		DATE	
			RCINIA DEPARTA NMENTAL PROT 601 57TH STREET S.E. ESTON, WEST VIRCINIA
		ISSUE	RCINIA NMEN 501 571 STON, V
	SOIL COVER	2	ST VIRGINI VVIRONMEN 601 57 CHARLESTON,
DRAIN TO CHANNEL 3A			Client WE: EN
			AILS > VIRGINIA
			ETAILS MP ST VIR
			THE MISCELLANEOUS DETAILS CRANY MINE DUMP WYOMING COUNTY, WEST VIR
			LANEC NY MI OUNT
			AISCEL CRA AING O
			Title A WYOA
	FIN	A I	34
			Drawing No.